

TOWN OF JUPITER INLET COLONY A MUNICIPAL CORPORATION

NOTICE OF PUBLIC MEETING: BUILDING AND ZONING COMMITTEE LOCATION: TOWN HALL, 50 COLONY ROAD DATE AND TIME: THURSDAY, JANUARY 18, 2024 AT 5:00 PM

Join by Zoom at: https://zoom.us/join
OR dial-in by location:

+1-301-715-8592 +1-253-215-8782 +1-312-626-6799 +1-346-248-7799 +1-929-205-6099 +1-669-900-6833

> Meeting ID: 585 628 8134 Password: 3787

MEETING AGENDA

- 1. Call to Order.
- 2. Roll Call: Russell Bourne (Acting Chair), Butch Harper, William Gilbane, Brad Eavenson, Roger Siboni. Planning and Zoning Administrator: Bill Whiteford
- 3. Election:
 - A. Chair
 - B. Vice Chair
- 4. Motion to approve prior minutes November 30, 2023 meeting
- 5. Public Comments items not on the agenda (3 minutes).
- 6. Continued Item:
 - A. #4 Ocean Drive: new two-story residence with outdoor pool. Total under air: 5,320 sf. Total square footage: 7,702 sf. Lot occupancy calculation: 49.96% (50% allowed). Maximum building height: 24.0' (25' allowed).
- 7. Discussion Item:
 - A. Minimum landscape requirements for single family residences
- 8. Any Other Matters.
- 9. Motion to Adjourn.

STATE MANDATED STATEMENT

If a person decides to appeal any decision made by the board, agency, or Commission with respect to any matter considered at such meeting or hearing, he/she will need a record of the proceedings, and that, for such purpose, he/she may need to ensure that a verbatim record of the proceedings is made, which record includes the testimony and evidence upon which the appeal is to be based. Any person requiring a special accommodation at this meeting because of a disability or physical impairment should contact the Town Administrative Office at 50 Colony Road, Jupiter Inlet Colony, FL 33469, or by telephone at 561-746-3787, prior to the meeting.



TOWN OF JUPITER INLET COLONY A MUNICIPAL C OR P OR A TIO N

TOWN OF JUPITER INLET COLONY BUILDING AND ZONING COMMITTEE MEETING NOVEMBER 30, 2023

MEETING MINUTES

- 1. Call to Order. Earl Fischer, Chair, called the workshop to order at 5:03 pm
- 2. Roll Call:

Earl Fischer (Chair), Present
Russell Bourne (Vice Chair), Present
Butch Harper, Absent
William Gilbane, Present
Brad Eavenson, Present
Roger Siboni, Present
Bill Muir, Absent
Planning and Zoning Administrator: Bill Whiteford – Present

Flamming and Zoming Administrator. Bill Willterord — Fresent

Also in attendance: Mike Armato, CEA Building Group, Chris Sorenson, CEA Building Group, Mitch Miller, Village Architects, Matt Carrara, resident.

3. Motion to approve prior minutes – July 27, 2023 Meeting, August 17, 2023 Workshop, September 21, 2023 Workshop.

Motion to approve all minutes was made by Roger Siboni, motion was seconded by Brad Eavenson, motion passed unanimously.

4. Public Comments - items not on the agenda (3 minutes).

Matt Carrara brought up discussion on security camera installations. Committee discussed height of security cameras, and issues of homeowner's privacy. Earl stated that this needs to be discussed. Bill Whiteford suggested that this issue needs to be brought up at Commission level, Earl Fischer suggested requiring a permit so that it can be regulated.

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TOWN OF JUPITER INLET COLONY

A MUNICIPAL C OR P OR A TIO N

5. New Item:

A. #4 Ocean Drive: new two-story residence with outdoor pool. Total under air: 5,320 sf. Total square footage: 7,702 sf. Lot occupancy calculation: 49.77% (50% allowed). Maximum building height: 24.0′ (25′ allowed).

Bill Whiteford provided an overview of the plans and report from Gary Rager, GeoPoint Surveying, for 4 Ocean to the Committee. Mr. Miller, architect for the project, stated that updates to the plans were submitted just prior to the meeting. The Committee discussed some of the other questions that Chad Gruber, Civil Engineer for the project, needed to talk with Tom Jensen about. There is a Federal easement on the North property line, a Removal Agreement was submitted, and the Town needs acknowledgement from the owners of 3 Ocean regarding shared access to the dune walkover. Mike Armato stated that it is in the works.

Question was raised by Mr. Miller: Who puts together the plan for the dune walkover? There is a proposed cross access between 3 and 4 Ocean and maintenance of the landscape will be a condition of the impact review. Roger Siboni stated that there was discussion on the height of the retaining wall, the sea grapes, and recommends that one person maintain the sea grapes and expense for each homeowner will be allocated by square feet of area maintained for each. Need and agreement between 4 & 5 Ocean on the landscaping.

Vote is tabled until the next Building and Zoning meeting to included outstanding items between homeowners:

- Walkover Agreement
- Sea Grapes / Landscaping Agreement
- Letter of "No Objection" from the Town to the DEP

6. Discussion Item:

A. Permit Fees and Time Extensions, Resolution 2019-07.

This item was put on the agenda by a request from Mayor Chip Block, but the committee is waiting for a Building and Permit Utilization report from Rick Hartley before it can make its recommendation to the Commission.

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TOWN OF JUPITER INLET COLONY A MUNICIPAL C OR P OR A TIO N

Bill Whiteford reviewed items of discussion on the minutes from Workshop of September 21, 2023, and there was a short discussion on permit renewals. Matt Carrara recommended that a force majeure provision be added to the language, which the Committee discussed, and Bill Whiteford stated that the State of Florida will typically issue a moratorium on permit fees in the event of a natural disaster or other event.


- 7. Any Other Matters.
 - A. Earl Fischer stated that he will be stepping down in January. Committee needs to get the word out for anyone that would like to sit on the B&Z Committee. Both Earl Fischer and Bill Muir will be leaving the B&Z Committee.
- 8. Motion to Adjourn. Motion to adjourn made by Russell Bourne, motion seconded by Brad Eavenson, motion passed unanimously, and the meeting adjourned at 6:04 p.m.

Approved,	Attest,
Earl Fischer, Chair	Kathi Cornelius, Deputy Town Clerk

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VILLAGE ARCHITECTS AIA

November 1, 2023

Town of Jupiter Inlet Colony 50 Colony Road Jupiter Inlet Colony, FL 33469

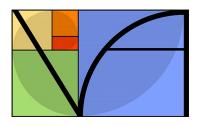Mitchell E. Miller
400 N. Cypress Drive, Suite 21
Tequesta, Florida 33469
(561)743-4959 ph
(561)743-1225 fax
Mitch.Miller@Village-Architects.com
www.Village-Architects.com

Re: Gooch Residence 4 Ocean Drive

To whom it may concern,

Below is a brief narrative desribing the new residence at the above listed property within Jupiter Inlet Colony.

A new two story home, driveway, pool and patio will be built at the vacant lot within the proposed building setbacks. The proposed first floor slab will be slightly higher (1.07') than the current floor slab elevation. The new home will consist of a 2 1/2 car garage, 4 bedrooms, 6 baths, and 1 half bath. The house will be built on a piling foundation system so as to meet coastal construction requirements set by the state of Florida and there is no basement. The exterior style of the home is "Island Modern" and the roof is flat.

If you have any questions or comments regarding this contract, please call.

Sincerely,

Mitchell E. Miller, AIA, NCARB (Principal of the Corporation)

Min & Mi

MEM/mem

LOT COVERAGE BY BUILDINGS (2-STORY)		
LOT AREA	16,800	SQ. FT.
FIRST FLOOR AIR CONDITIONED AREA SECOND FLOOR AIR CONDITIONED AREA GARAGES COVERED ENTRY COVERED LANAI COVERED PORCH SIDE ENTRY BALCONY CANTILEVERED BALCONY UNINHABITABLE AREA UNDER UPPER ENTRY EAVE	2,423 1,113 79 593	SQ. FT.
TOTAL FLOOR BUILDING AREA	7,702	SQ. FT.
FLOOR AREA PERCENTAGE CALCULATIONS:		
MAX ALLOWED LOT COVERAGE PERCENTAGE: (5,376/16,800) PROPOSED LOT COVERAGE PERCENTAGE: (4,980/16,800)	32.00 29.64	PERCENT PERCENT
MAX ALLOWED SECOND TO FIRST FLOOR PERCENTAGE: (2,988/4,980) PROPOSED SECOND TO FIRST FLOOR PERCENTAGE: (2,722/4,980)	60.00 54.66	PERCENT PERCENT
MAX ALLOWED TOTAL LOT PERCENTAGE: (8,400/16,800) TOTAL LOT PERCENTAGE: (7,702/16,800)	50.00 45.85	PERCENT PERCENT

LOT OCCUPANCY	
LOT AREA	16,800 SQ. FT.
HOUSE FOOTPRINT-ENCLOSED	4,011 SQ. FT.
COVERED ENTRY COVERED LANAI COVERED PORCH SIDE ENTRY PATIOS AND DECKS DRIVEWAY, PARKING AREAS EQUIPMENT PADS UNDER EAVES GREATER THAN 24"	79 SQ. FT. 593 SQ. FT. 226 SQ. FT. 72 SQ. FT. 62 SQ. FT. 1419 SQ. FT. 190 SQ. FT. 0 SQ. FT.
UNDER BREEZEWAYS WALKS AND STEPPING STONES POOL POOL DECK BOUNDRY WALLS SEAWALLS DUNE CROSSOVER (ON PROPERTY) OTHER HARDSCAPE (RETAIN, PRIVACY WALLS)	0 SQ. FT. 213 SQ. FT. 360 SQ. FT. 848 SQ. FT. 0 SQ. FT. 0 SQ. FT. 59 SQ. FT. 262 SQ. FT.
TOTAL LOT OCCUPANCY AREA	8,394 SQ. FT.
PROPOSED LOT COVERAGE	49.96% 8,394 SF
MAX ALLOWABLE LOT COVERAGE	50.0% 8,400 SF
CONTRACTOR TO VERIFY ALL SQUARE FOOTAGES	

DOCUMENT QUALIFICATION

THIS DRAWING WAS PREPARED BASED ON INFORMATION PROVIDED BY THE OWNER AND OR THE CONTRACTOR IN THE FORM OF A BOUNDARY SURVEY PREPARED BY LIDBERG LAND SURVEYING, INC. DATED 4-27-23 DRAWING NO. 23-044-112 SHEET 1 OF 1. USE WITHOUT VERIFICATION WILL BE AT THE USER'S SOLE RISK. THE USER SHALL INDEMNIFY THE ARCHITECT "VILLAGE ARCHITECTS AIA" FROM ALL CLAIMS AND LOSSES RESULTING FROM SUCH USE. THE DELIVERY OF THIS DRAWING TO THE USER SHOULD NOT BE CONSTRUED TO PROVIDE AN EXPRESS WARRANTY OR A GUARANTEE TO ANYONE THAT CERTAIN CONDITIONS EXIST OR THAT THE USE OF THIS DRAWING IMPLIES THE REVIEW AND APPROVAL BY THE ARCHITECT OF ANY SHOP DRAWING BASED ON THIS INFORMATION. USE OF THIS DRAWING IN NO WAY RELIEVES ANY OTHER PARTY FROM MEETING REQUIREMENTS IMPOSED BY CONTRACT OR OTHER MEANS.

SITE NOTES

- 1. VERIFY LOCATION OF UTILITIES WITH SUBDIVISION BEFORE PROCEEDING WITH WORK. 2. DRAINAGE TO BE INDICATED ON LANDSCAPE PLAN.
- 3. CONNECTION INSPECTION OF UTILITIES REQUIRED PRIOR TO BACKFILL 4. CONTRACTOR TO HAVE CERTIFIED FLORIDA SURVEYOR LAYOUT BUILDING ON LOT TO
- ASSURE THAT NO SETBACKS OR EASEMENTS ARE ENCROACHED
- 5. CONTRACTOR SHALL PROVIDE SOIL BORING TEST AND DEMUCK AND REPACK SOIL AS REQUIRED.

6. CONTRACTOR TO PROVIDE (1) 4" AND (1) 6" PVC SLEEVE UNDER DRIVEWAY

PARTIAL LEGAL DESCRIPTION

LOT 4, PLAT OF JUPITER INLET BEACH COLONY, ACCORDING TO THE PLAT THEREOF ON FILE IN THE OFFICE OF THE CLERK OF THE CIRCUIT COURT IN AND FOR PALM BEACH COUNTY, FLORIDA, RECORDED IN PLAT BOOK 24, PAGE 139.


THE PROPERTY LIES WITHIN FLOOD ZONE VE

DESIGN CODES: FLORIDA BUILDING CODE, RESIDENTIAL, 7TH EDITION (2020) W/ AMENDMENTS TO THE FBC, CH1 ADMINISTRATION FBC ENERGY CONSERVATION 7TH EDITION (2020) FBC RESIDENTIAL 7TH EDITION (2020)

FBC EXISTING BUILDING 7TH EDITION (2020) FBC MECHANICAL 7TH EDITION (2020)

FBC PLUMBING 7TH EDITION (2020)

NEC NFPA 70 2020 EDITION FS FLORIDA STATUTES

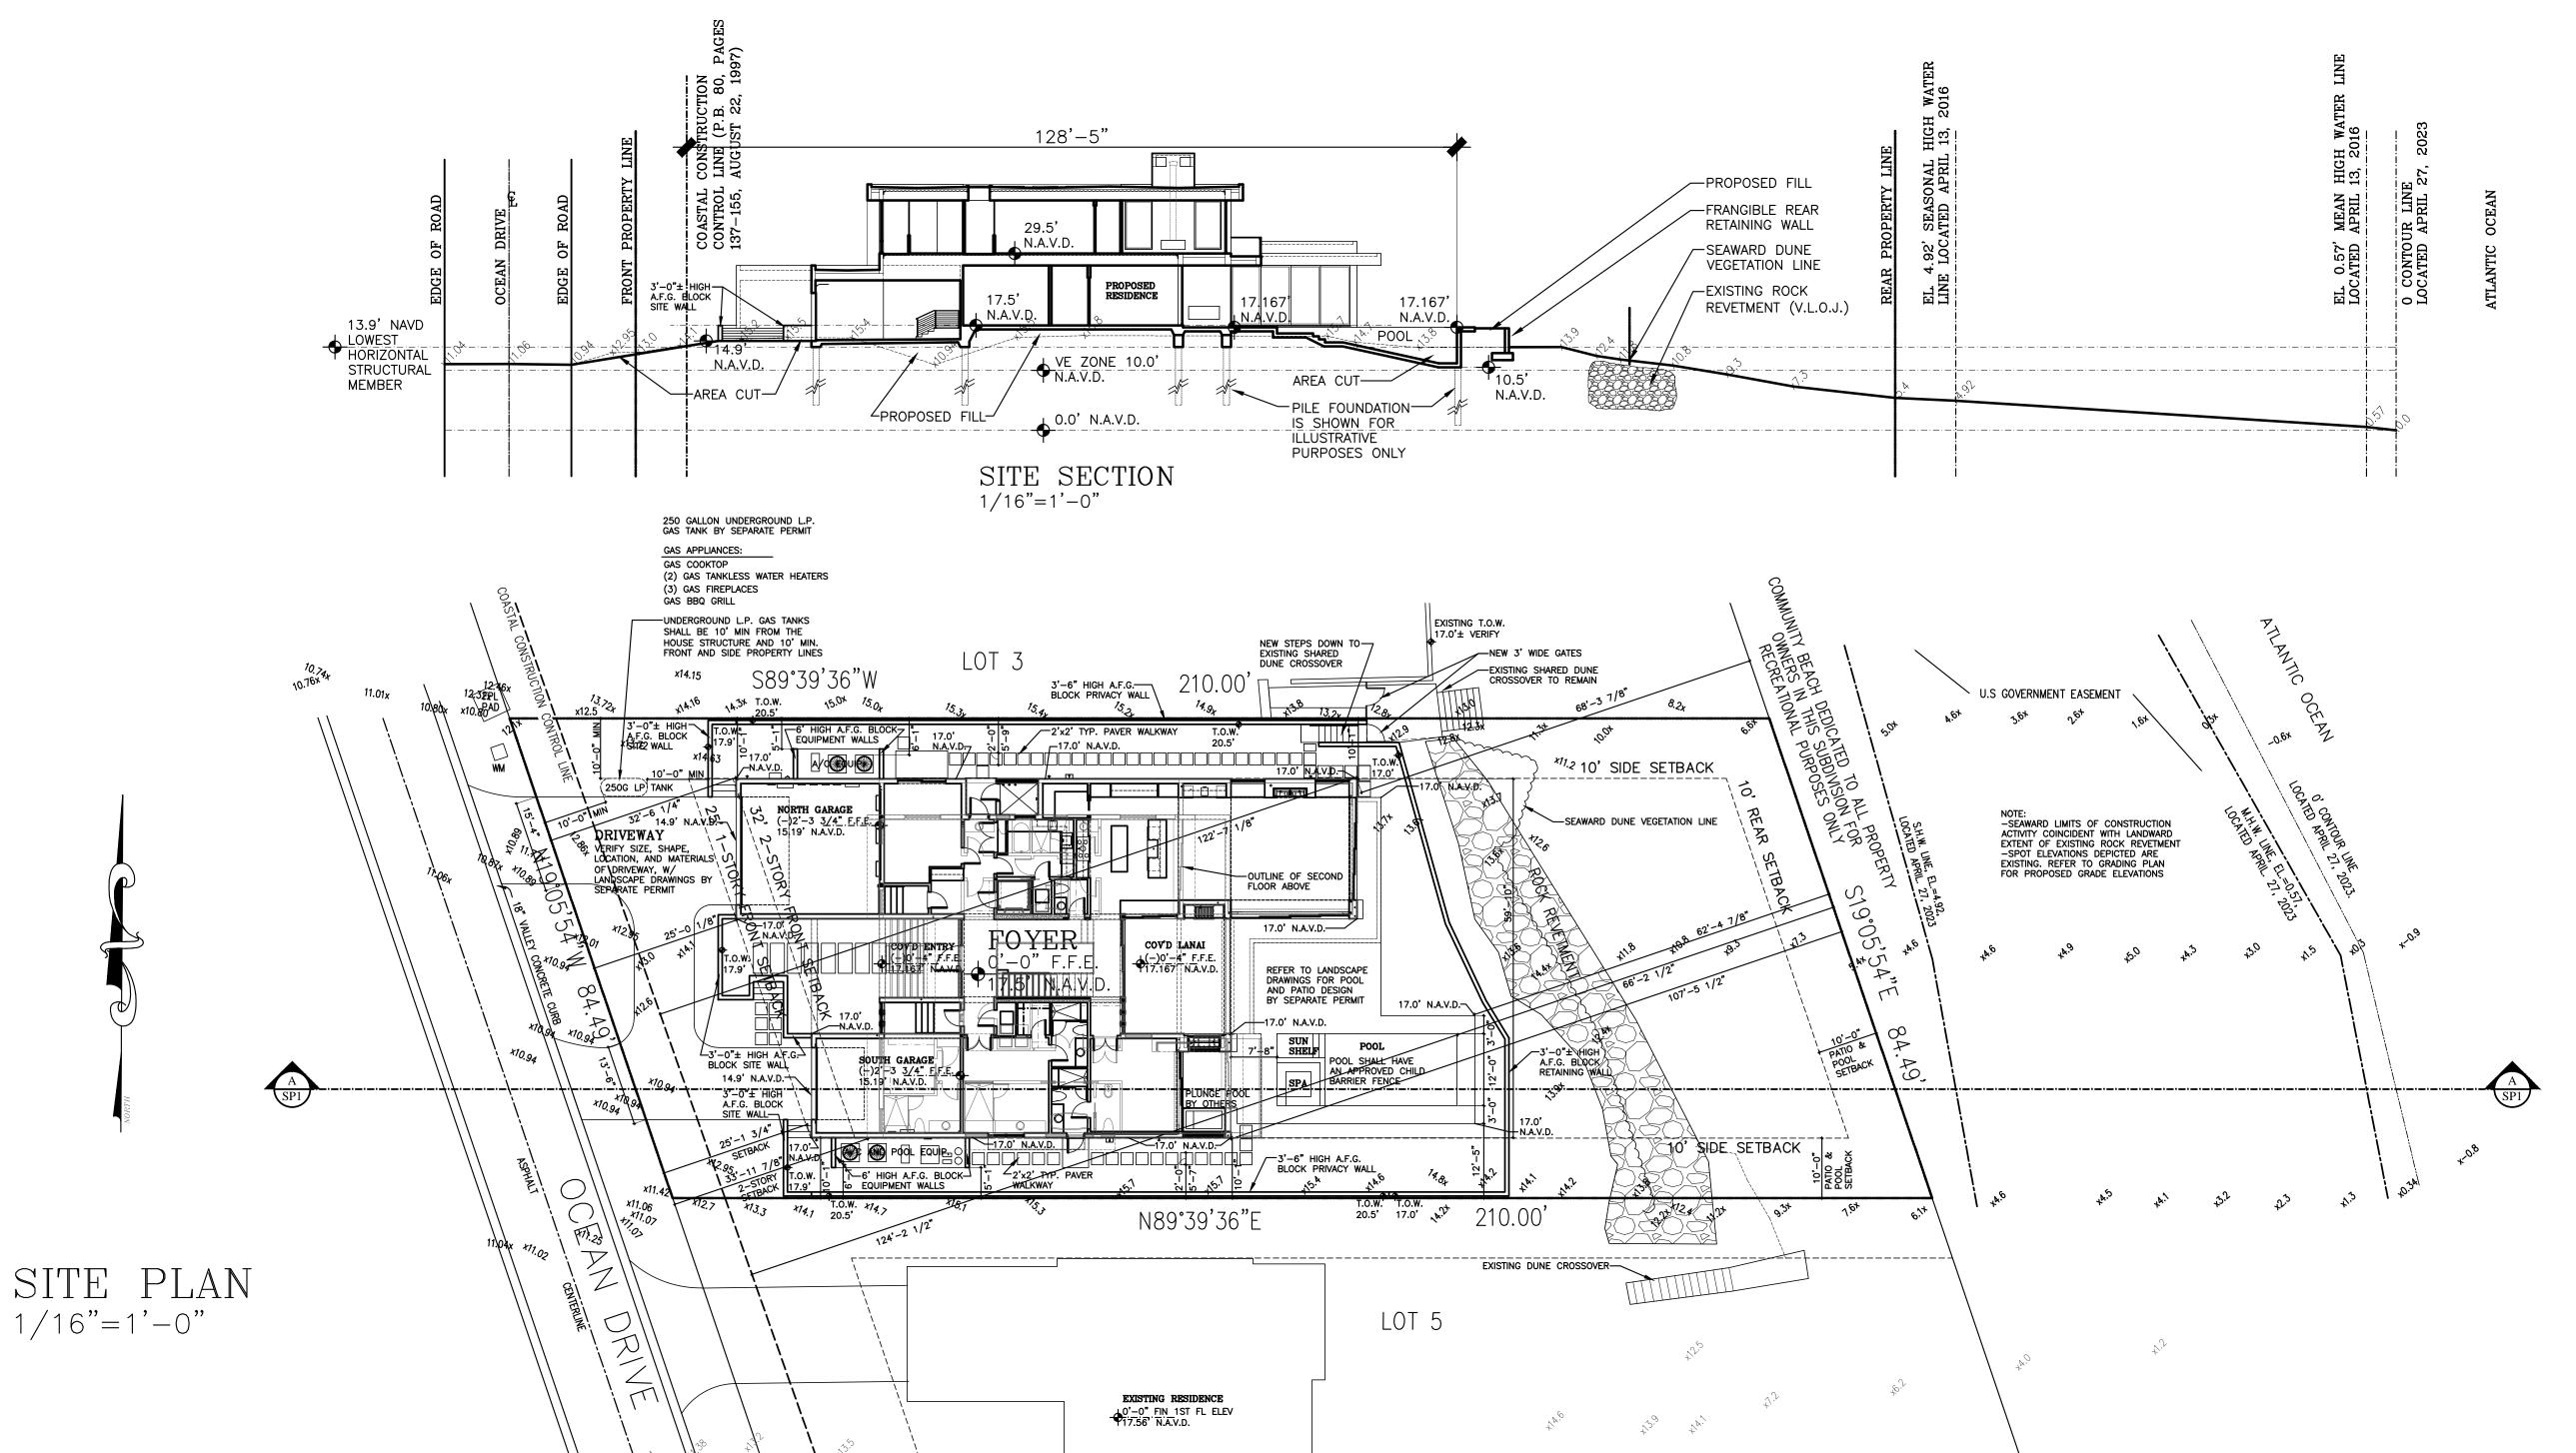

VILLAGE ARCHITECTS AIA 400 N CYPRESS DRIVE, SUITE 21 Tequesta, FL 33469 Phone: 561-743-4959 Fax: 561-743-1225

www.Village-Architects.com

AA26001195

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Mitchell E. Miller Florida License No. AR91772 As Principal of Village Architects AIA, Inc.

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Consultant:

Revisions: 11-1-23 JIC REVIEW

12-21-23 JIC REVIEW

Sheet Title:

SITE PLAN


Scale:	
1/16" = 1'-0"	
Comm ·	Da

23-006 4-10-23 Checked: Drawn: SHM **MEM**

Sheet No.

NOT FOR CONSTRUCTION

Print Date: 12-14-23

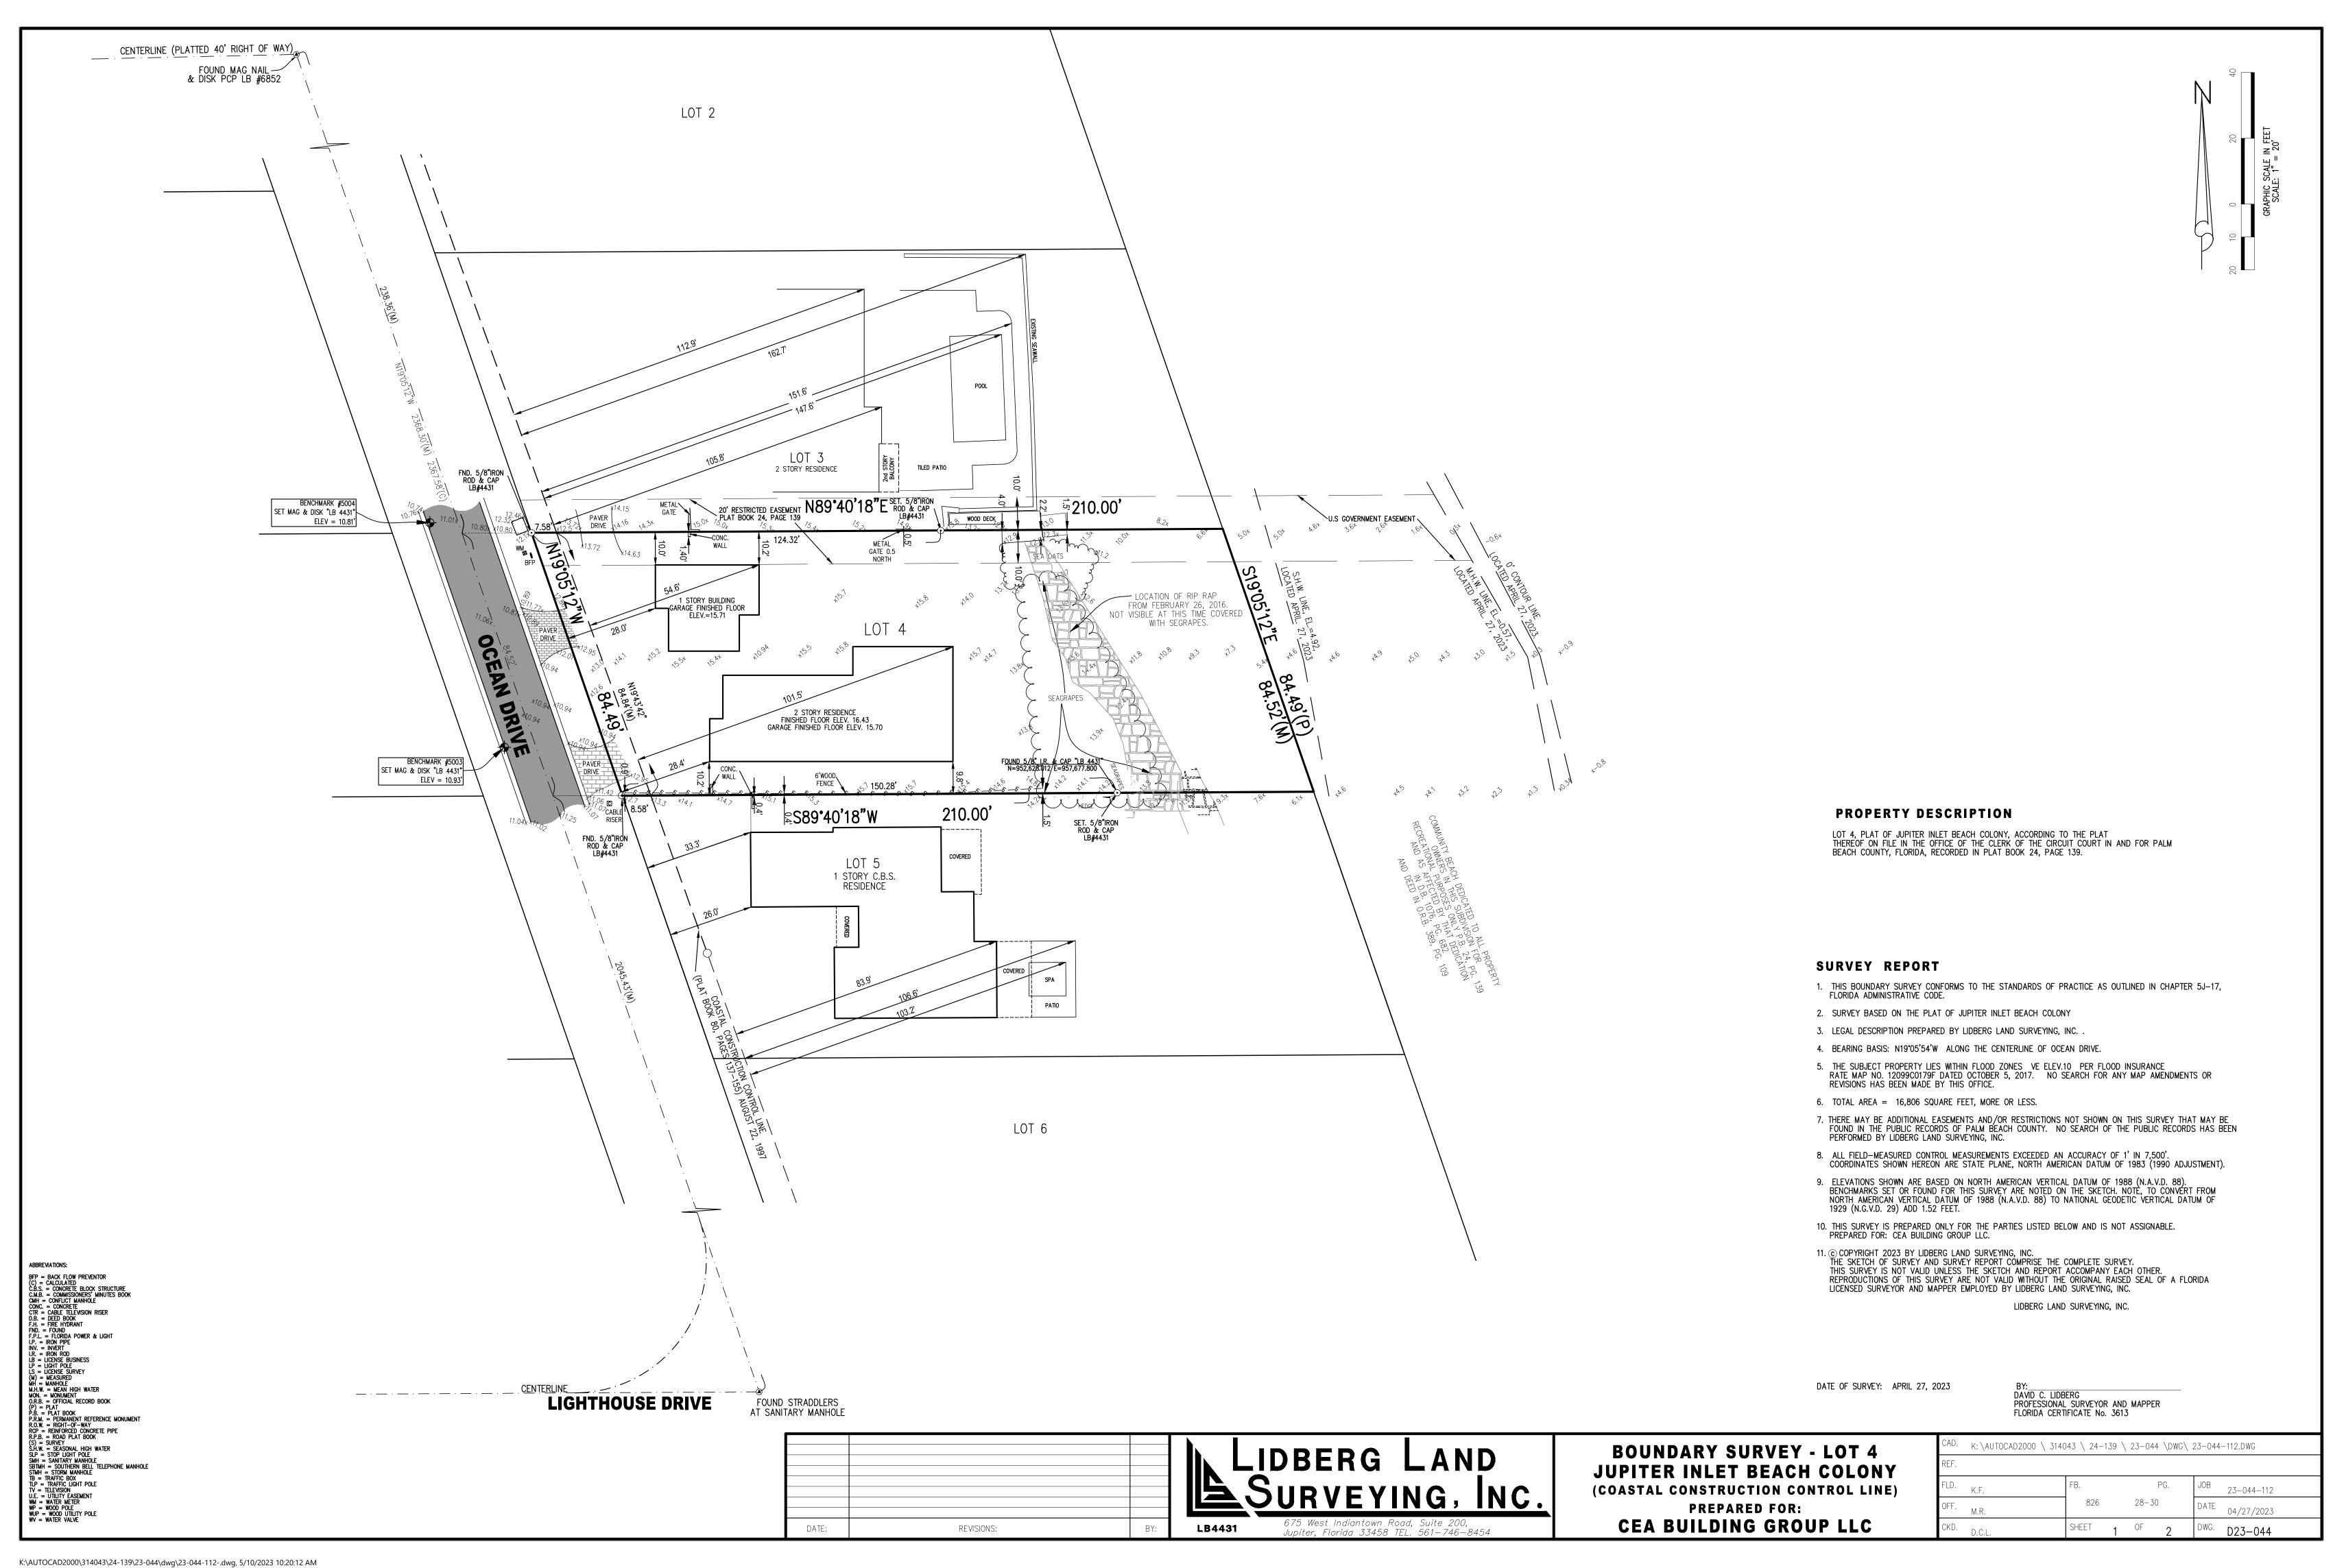

November 8, 2023



Bill Whiteford, PhD, AICP, Planning and Zoning Administrator 50 Colony Road Jupiter Inlet Colony, Florida 33469

RE: 4 Ocean Drive, Jupiter Inlet Colony, Florida 33469 – Lot 4

Dear Bill,

We have reviewed the files we received November 7, 2023 of <u>Lot 4</u>. We find items relevant to the code are listed below, and additional areas of concern are stated also:

1. 50% Max. Lot area coverage calculation = 7,366 sq. ft. or 44%, 8,326 provided.

2.

- a) 32% Max First Floor Coverage = 4,979 sq. ft. or 30%, 4,980 provided
- b) 60% Max (of first) Second Floor = 2,428 sq. ft. or 49%, 2,772 provided.
- c) 50% Total Floor Coverage 7,407 sq. ft. or 44% 7,702 provided.
- 3. 24' Building Height to the top: 24' plan. Wall height is 24'. (South)
- 4. Roof eave: Plan shows it to be 2 when provided.

5. Pool: meets setbacks (10' from Side).

- 6. 3 car garage, outdoor spaces provided. The driveway appears to be 14' wide, the provided flare is 17.5'.
- 7. Windows, review of the proposed right elevation shows about 11% calculated.
- 8. The building did meet the setbacks of 10' on the sides, 25' front (first floor) and 10' in the rear. And the two story is over 32' setback for the front setback.

9. 30% Front Yard Landscape is: 52% green

Sincerely,

Gary A. Rager, P.S.M. License No. LB4828

Vice President

Director of East Coast Operations

Bill Whiteford

To: Mitch Miller

Cc: Sam Miller; Jensen, Tom (Tom.Jensen@kimley-horn.com); Chuck Yannette; Richard Clarke; Michael Armato; Matthew

Percy; Chad Gruber

Subject: RE: 4 Ocean Drive JIC_grading and drainage plan

Hi Bill,

There were no changes to the house. The only change made was regarding the shared dune crossover (see attached). We met with Mr. Ryan and his wife and reviewed the current shared wood deck and stairs. Mr. Ryan agreed to continuing to share the access but wanted a few changes. He wanted the steps on our side relocated so that he didn't see them from his steps and gates added at the bottom of both his and our steps to create more privacy and to keep people from wandering from one property to the other. The existing deck area and steps will remain with repairs being made by Ms. Gooch as needed during construction. Mike Armato also suggested replacing the old rotted pressure treated decking with Ipe decking. Jared Gaylord was also present at the site meeting and was preparing an agreement letter for both parties to sign.

Let me know if you have any questions or concerns.

Mitch

On Dec 18, 2023, at 12:00 PM, Bill Whiteford <wcw@teamplaninc.com> wrote:

Hi Sam — it's a lot to review before the meeting on Thursday. Please summarize the changes in a memo and highlight any significant changes on the plans to expedite their review. Send the CAD file asap, we may need Gary Rager to review it again. Thanks, Bill

Bill Whiteford, PhD, AICP, LEED® BD+C & ND

<image001.png>

Principal, TEAM PLAN INC. o 561.630.6820 | c 561.706.2100 www.teamplaninc.com <image002.png>

From: Sam Miller <sam.miller@village-architects.com>

Sent: Friday, December 15, 2023 12:17 PM **To:** Bill Whiteford < wcw@teamplaninc.com

Cc: Mitch Miller <mitch.miller@village-architects.com>; Jensen, Tom (Tom.Jensen@kimley-horn.com)

<Tom.Jensen@kimley-horn.com>; Chuck Yannette <chuck@pydg.com>; Richard Clarke

<richard.clarke@village-architects.com>; Michael Armato <michael.mastercraft@gmail.com>; Matthew

Percy <matt.oceanichomes@gmail.com>; Chad Gruber <chad@gruberengineers.com>


Subject: RE: 4 Ocean Drive JIC_grading and drainage plan

Hi Bill,

Attached is our 4 Ocean JIC submittal set for the review meeting on the 21st. We're working on tracking down the finish floor elevation for 3 Ocean, we can forward that over as soon as we find out. Let me know if you need anything else for the review.

Thank you,


Sam

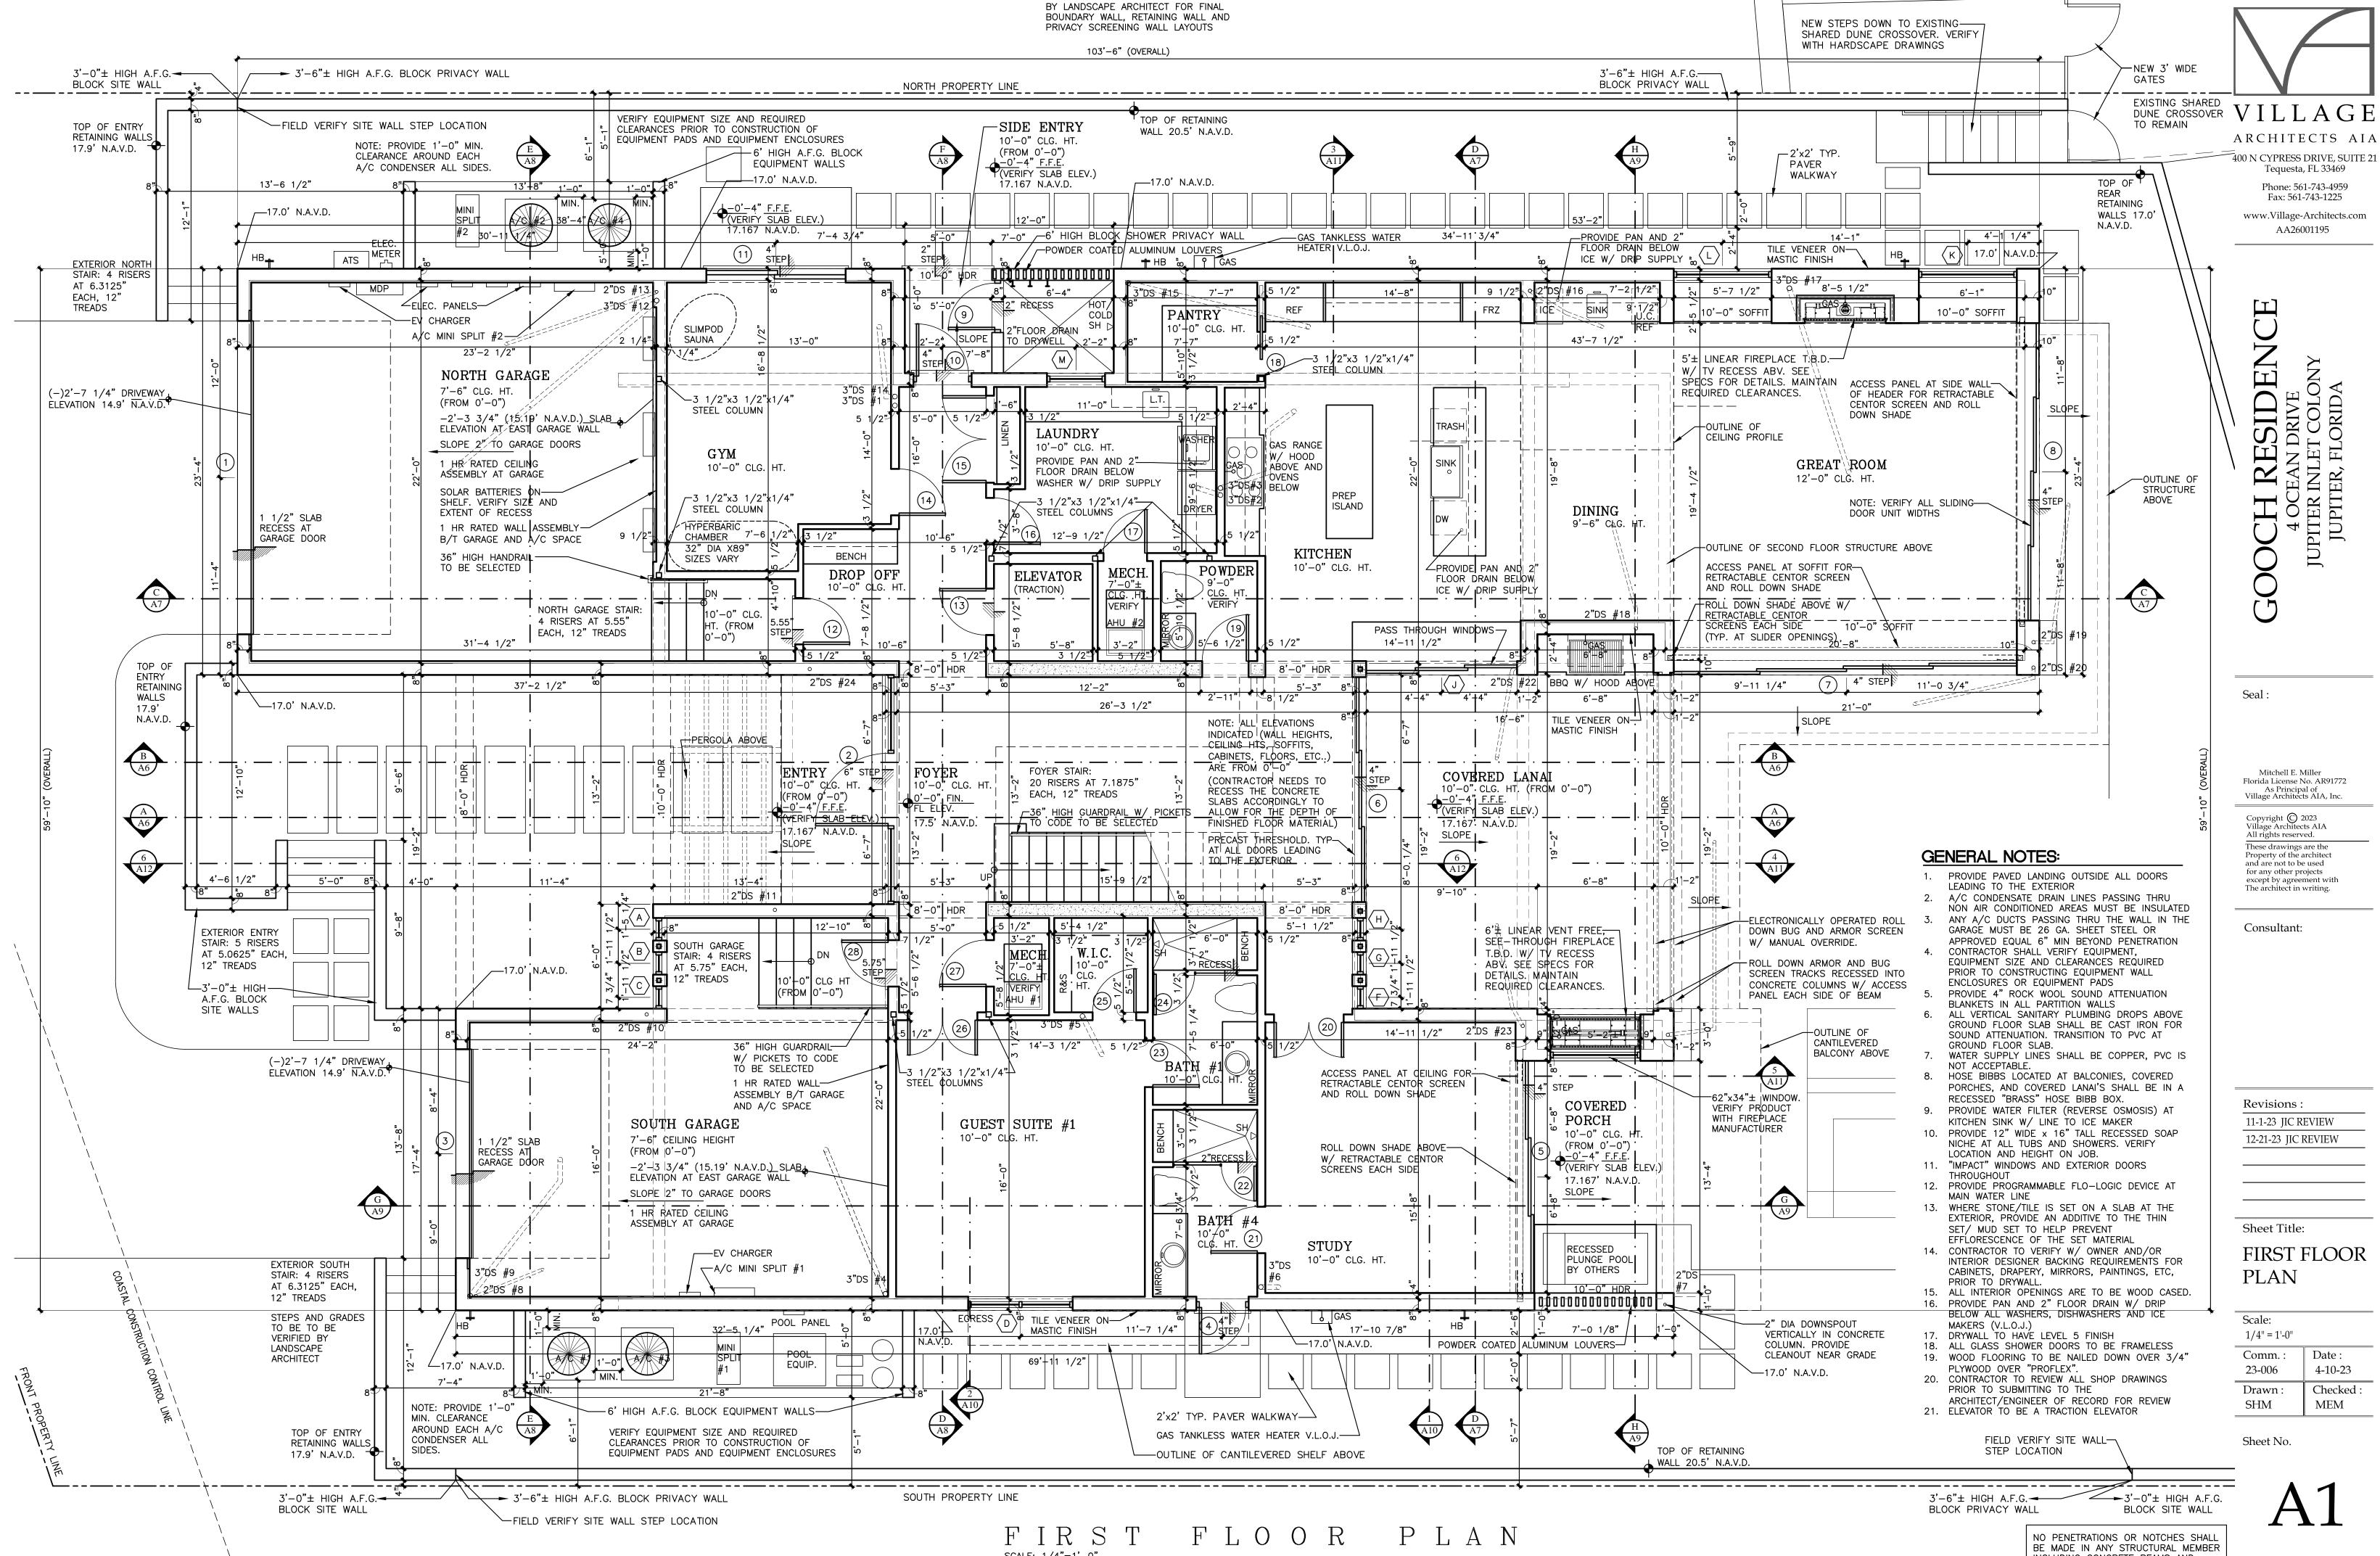

NOTE: REFER TO HARDSCAPE DRAWINGS

NOT FOR CONSTRUCTION

INCLUDING CONCRETE BEAMS AND COLUMNS, MASONRY BLOCK AND STEEL BEAMS WITHOUT WRITTEN APPROVAL BY | Print Date: 12-14-23 THE ENGINEER OF RECORD.

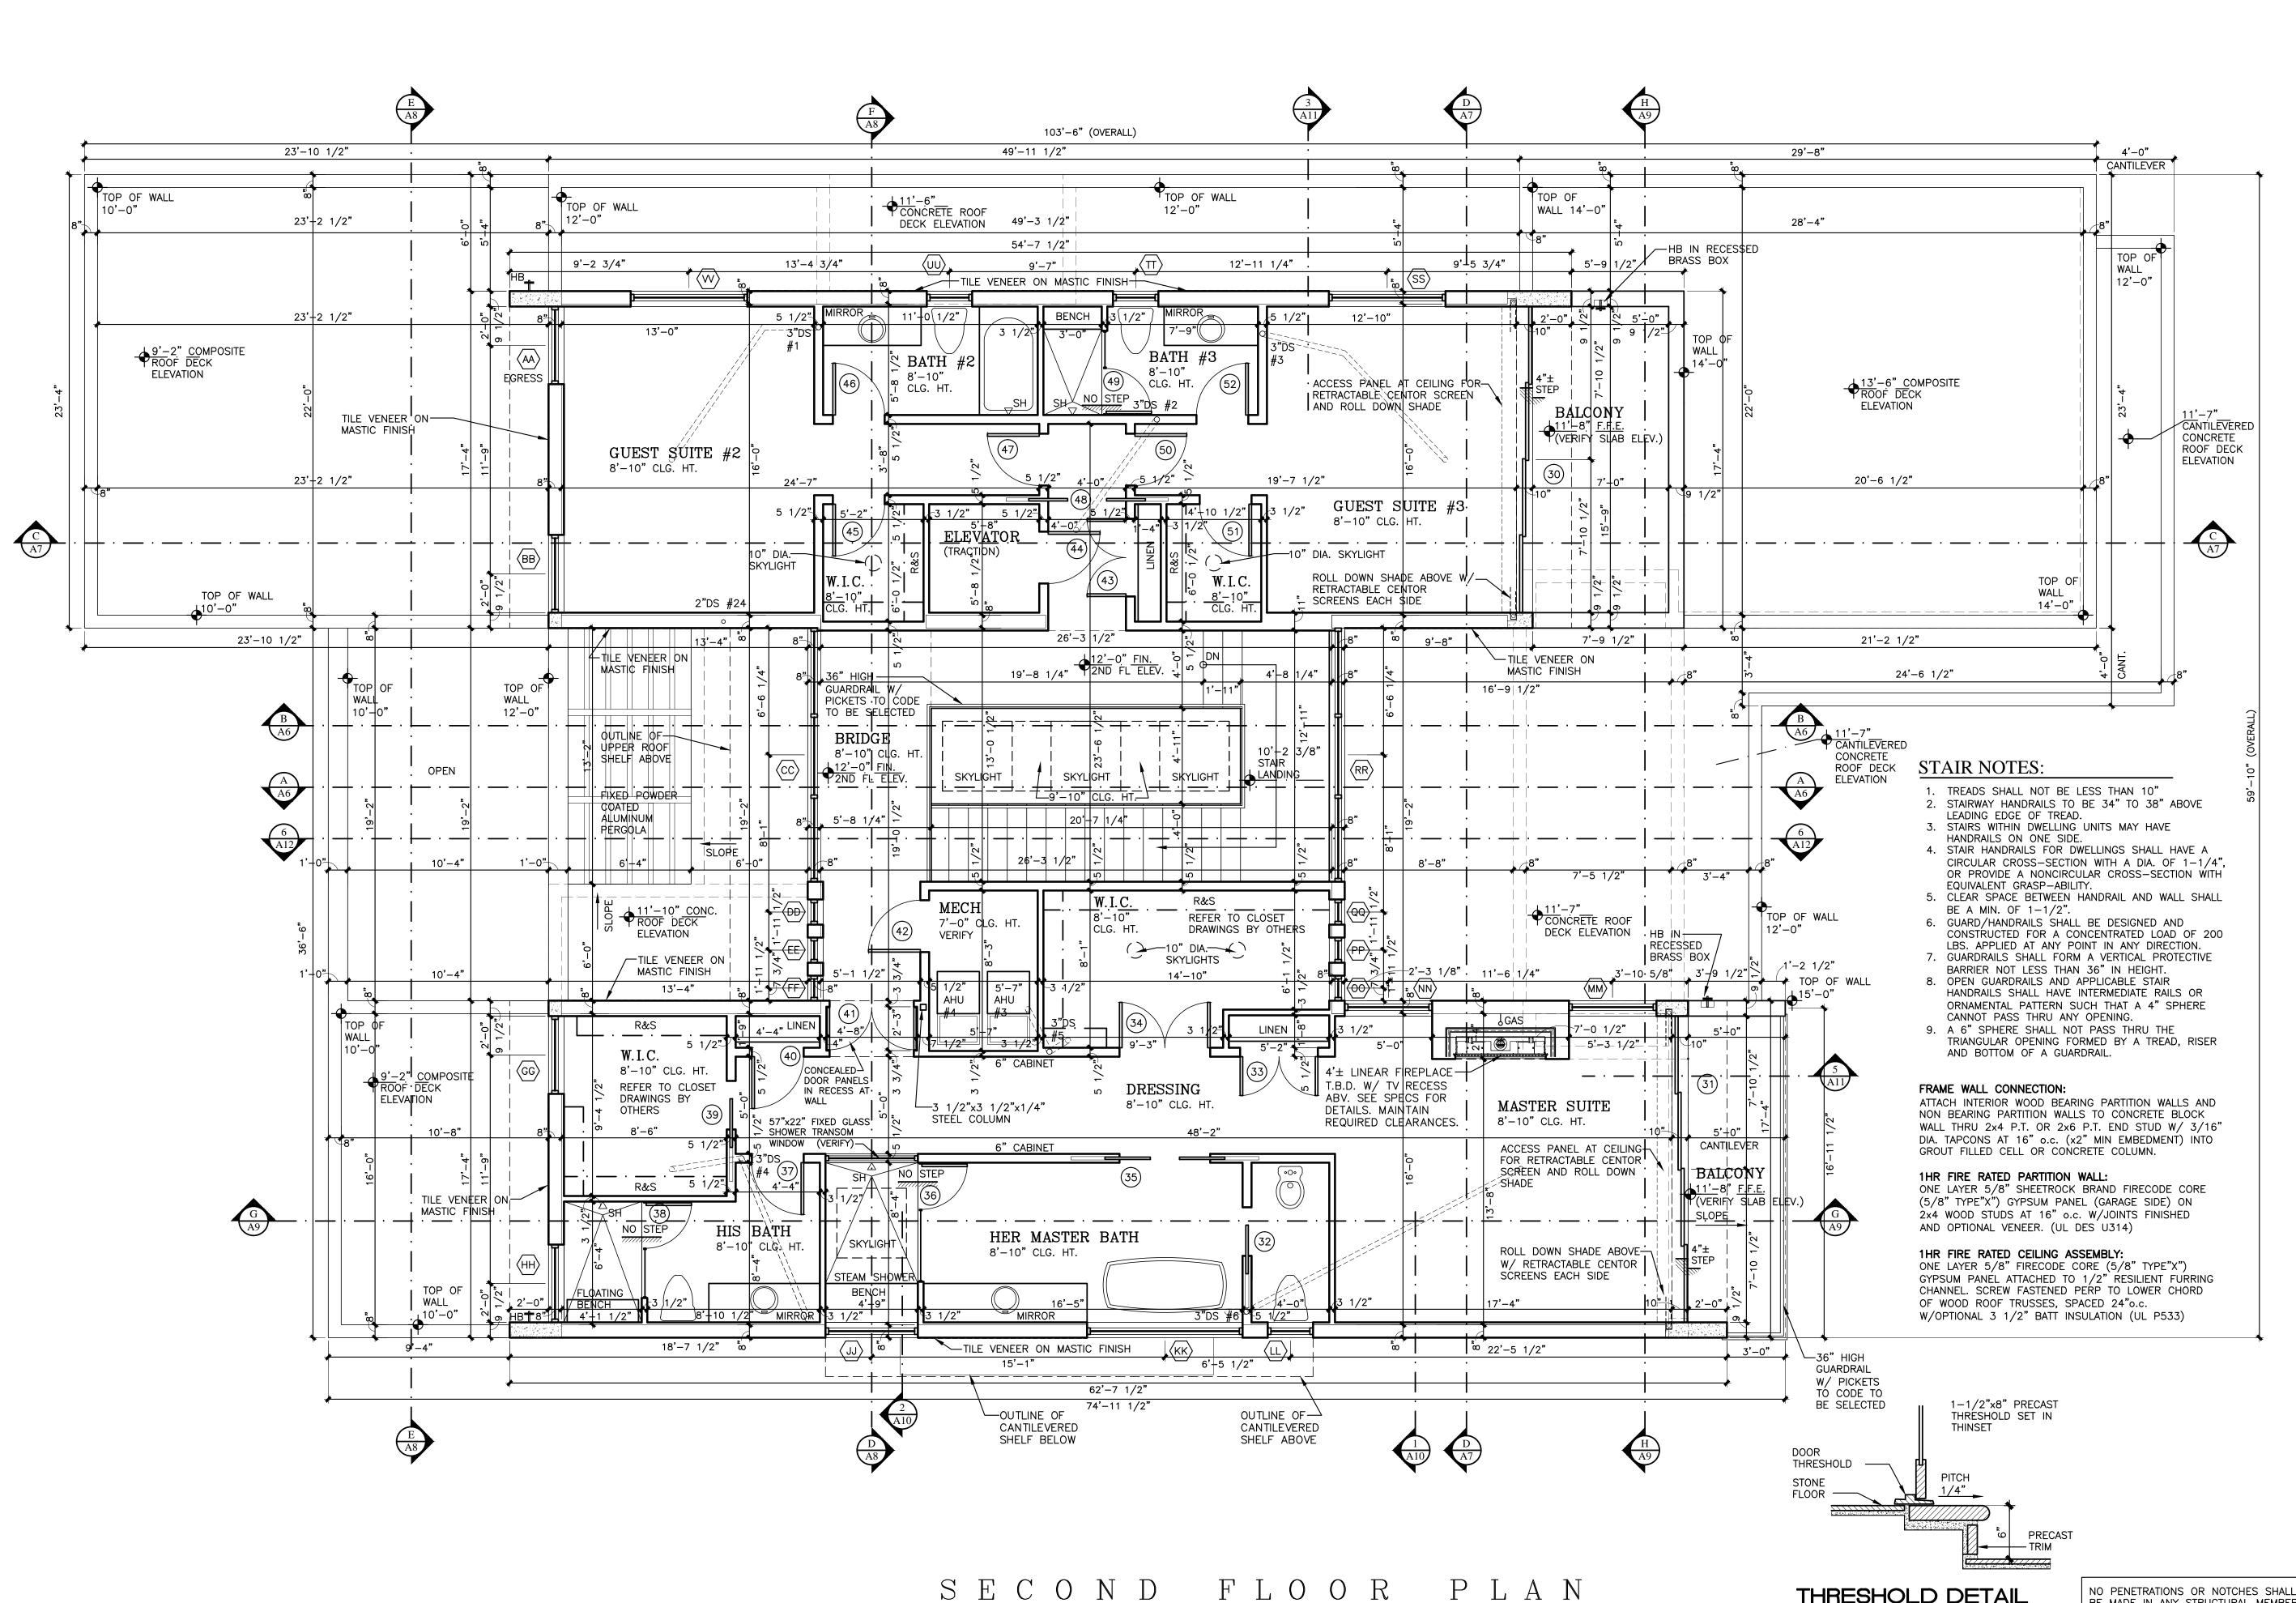

SCALE: 1/4"=1'-0"

ARCHITECTS AIA 400 N CYPRESS DRIVE, SUITE 21

Tequesta, FL 33469

Phone: 561-743-4959 Fax: 561-743-1225

www.Village-Architects.com AA26001195

Seal:

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for any other projects except by agreement with

The architect in writing.

Consultant:

Revisions:

11-1-23 JIC REVIEW 12-21-23 JIC REVIEW

Sheet Title:

SECOND FLOOR PLAN

Scale: 1/4" = 1'-0"

Comm.: 23-006 4-10-23 Drawn: Checked: SHM MEM


Sheet No.

NO PENETRATIONS OR NOTCHES SHALL BE MADE IN ANY STRUCTURAL MEMBER INCLUDING CONCRETE BEAMS AND COLUMNS, MASONRY BLOCK AND STEEL BEAMS WITHOUT WRITTEN APPROVAL BY THE ENGINEER OF RECORD.


Print Date: 12-14-23


THRESHOLD DETAIL

1-1/2"=1'-0"

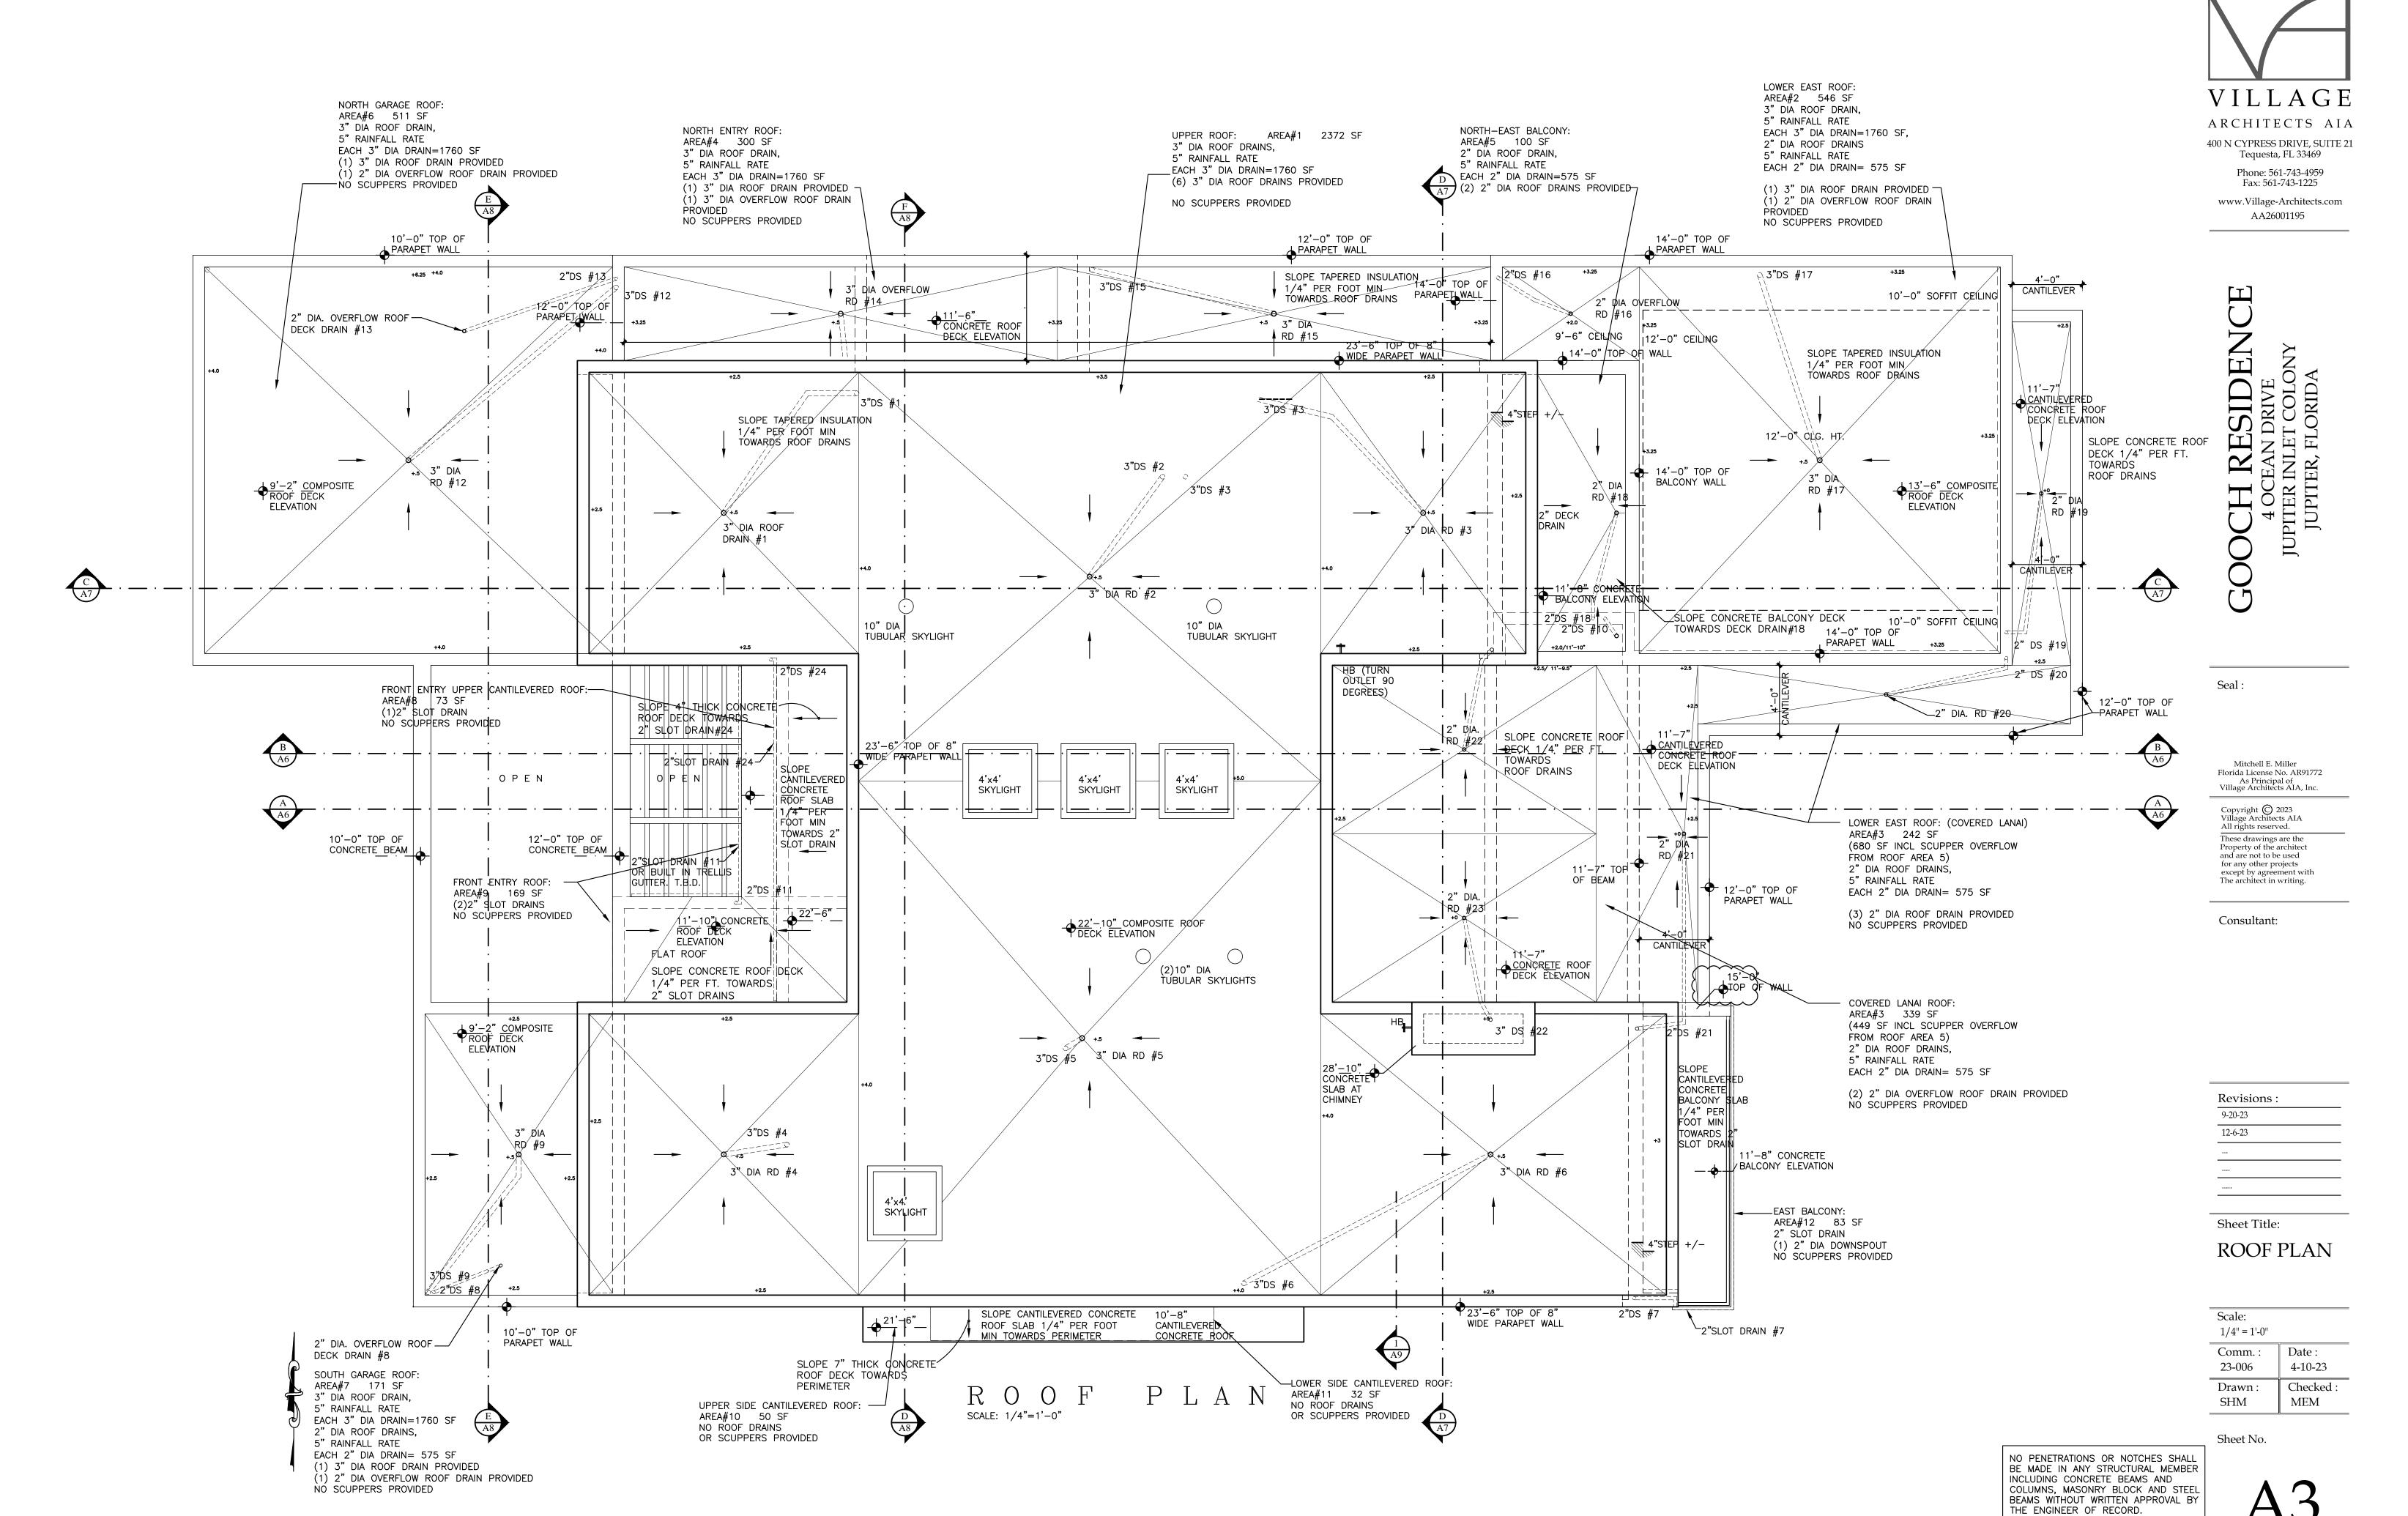

 $\Lambda \mathcal{J}$

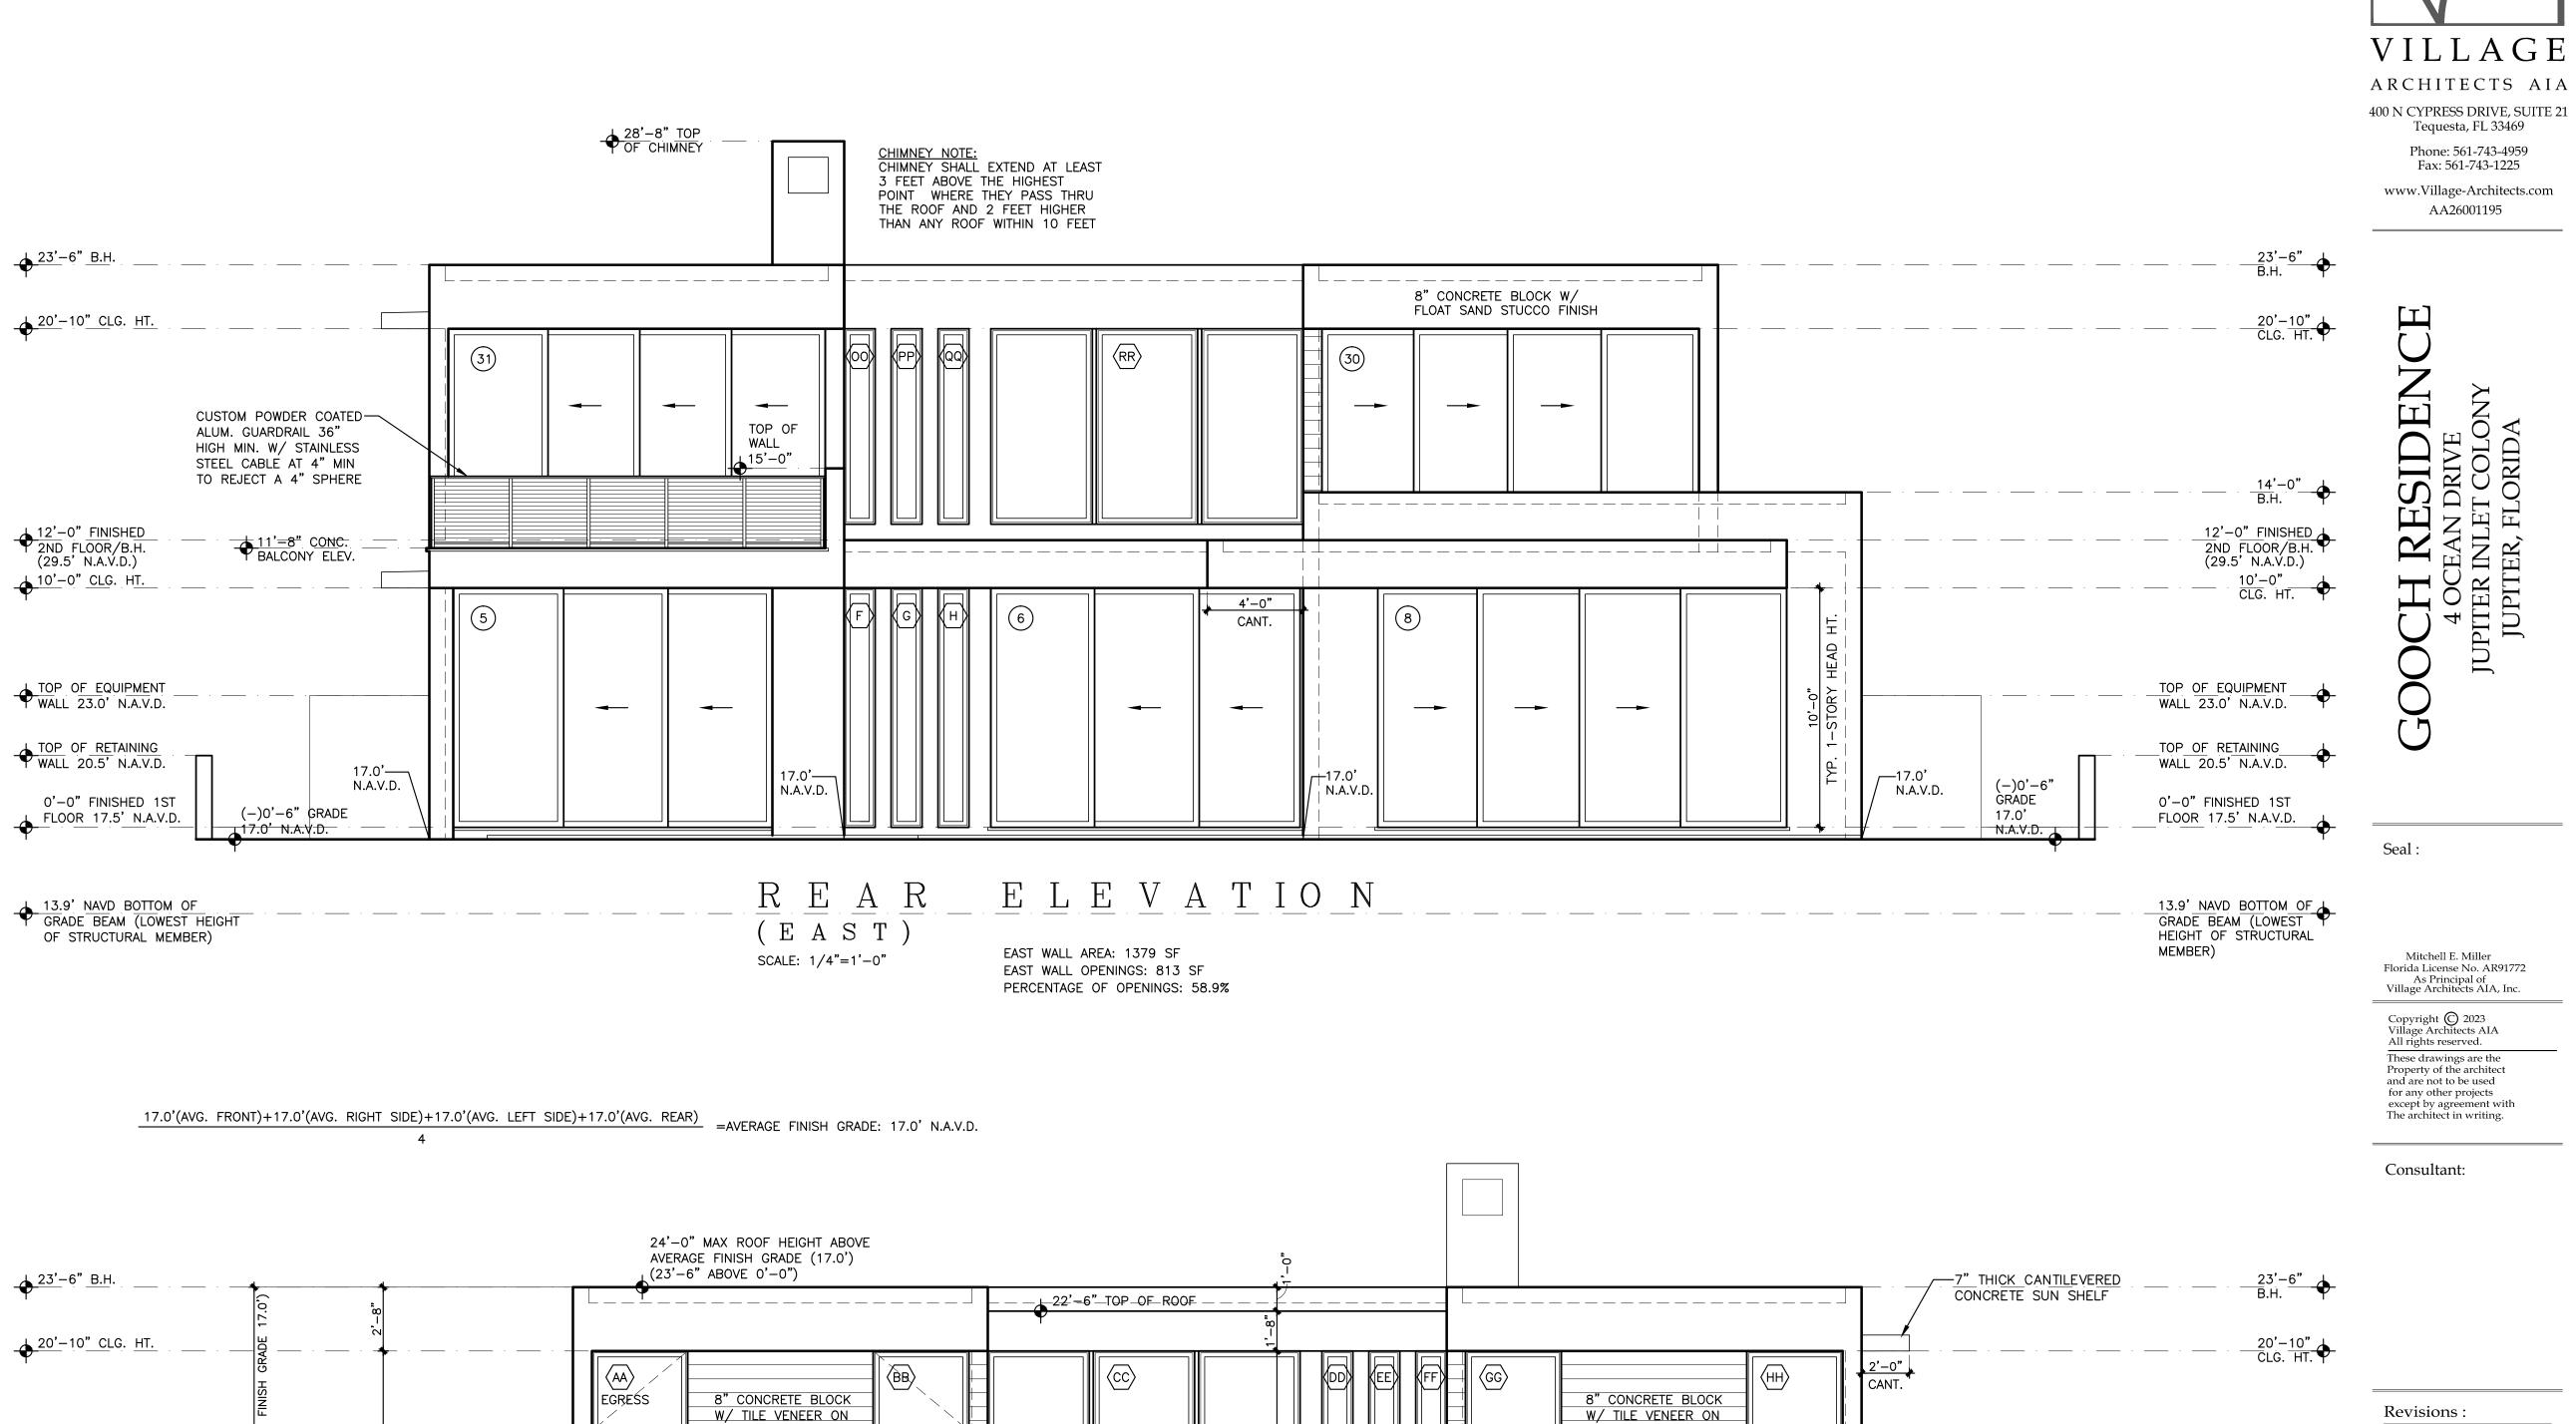

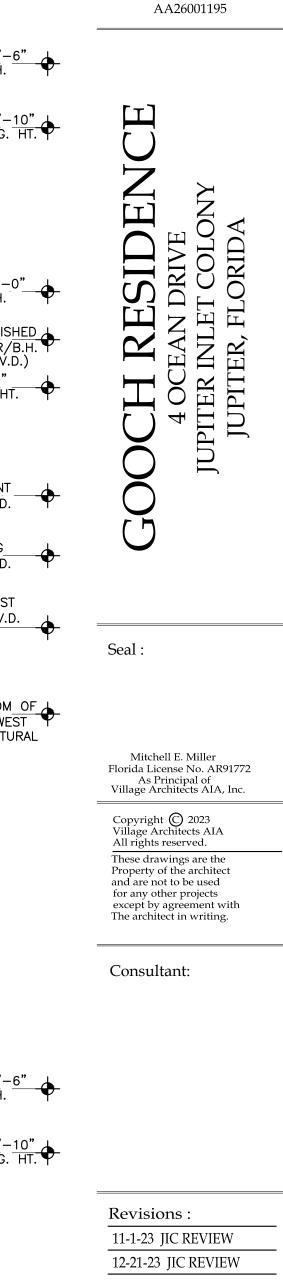

12'-0" FINISHED 2ND FLOOR/B.H. (29.5' N.A.V.D.)

TOP OF EQUIPMENT WALL 23.0' N.A.V.D.

TOP OF RETAINING

WALL 20.5' N.A.V.D.

0'-0" FINISHED 1ST

FLOOR 17.5' N.A.V.D.

13.9' NAVD BOTTOM OF GRADE BEAM (LOWEST

HEIGHT OF STRUCTURAL

MEMBER)

10'-0" B.H. /CLG. HT.

Sheet Title: **ELEVATIONS**

Scale: 1/4" = 1'-0" Comm.: Date: 23-006 4-10-23 Checked: Drawn:

Sheet No.

SHM

MEM

WEST WALL AREA: 1505 SF WEST WALL OPENINGS: 639 SF PERCENTAGE OF OPENINGS: 42.4%

(−)2'−7 1/4"\ENTRY GRADE 14.9' N.A.V.D.−

N.A.V.D.

E L E V A T I O N

WOOD VENEER

N.A.V.D.

(WEST)

SCALE: 1/4"=1'-0"

(-)0'-6" GRADE

BEYOND 17.0' N.A.V.D.

MASTIC FINISH

8" CONCRETE BLOCK

AZEK VENEER ON

GARAGE DOOR

W/ FLOAT SAND

SŤUCCO FINISH

-7" THICK CANTILEVERED

CONCRETE SUN SHELF

-6'-0" HIGH A.F.G. BLOCK

3'-6"± HIGH A.F.G.

BLOCK PRIVACY WALL

EQUIPMENT WALL

—17.0'

N.A.V.D.

TOP OF RETAINING

WALLS 17.9' N.A.V.D.

36" HIGH CONCRETE

BLOCK RETAINING WALLS

ALONG FRONT ELEVATION

MASTIC FINISH

AZEK VENEER ON

GARAGE DOOR

_ _ _ _ _ _ _ _

17.0'— N.A.V.D.

(-)0'-6" GRADE

BEYOND 17.0' N.A.V.D.

12'-0" FINISHED 2ND FLOOR/B.H. (29.5' N.A.V.D.)

10'-0" B.H./CLG. HT.

EQUIPMENT WALL

TOP OF EQUIPMENT 23.0' N.A.V.D.

TOP OF RETAINING WALL 20.5' N.A.V.D.

0'-0" FINISHED 1ST

13.9' NAVD BOTTOM OF
GRADE BEAM (LOWEST HEIGHT


OF STRUCTURAL MEMBER)

FLOOR 17.5' N.A.V.D.

3'-6" HIGH A.F.G.—

BLOCK PRIVACY WALL

6'-0" HIGH A.F.G. BLOCK-

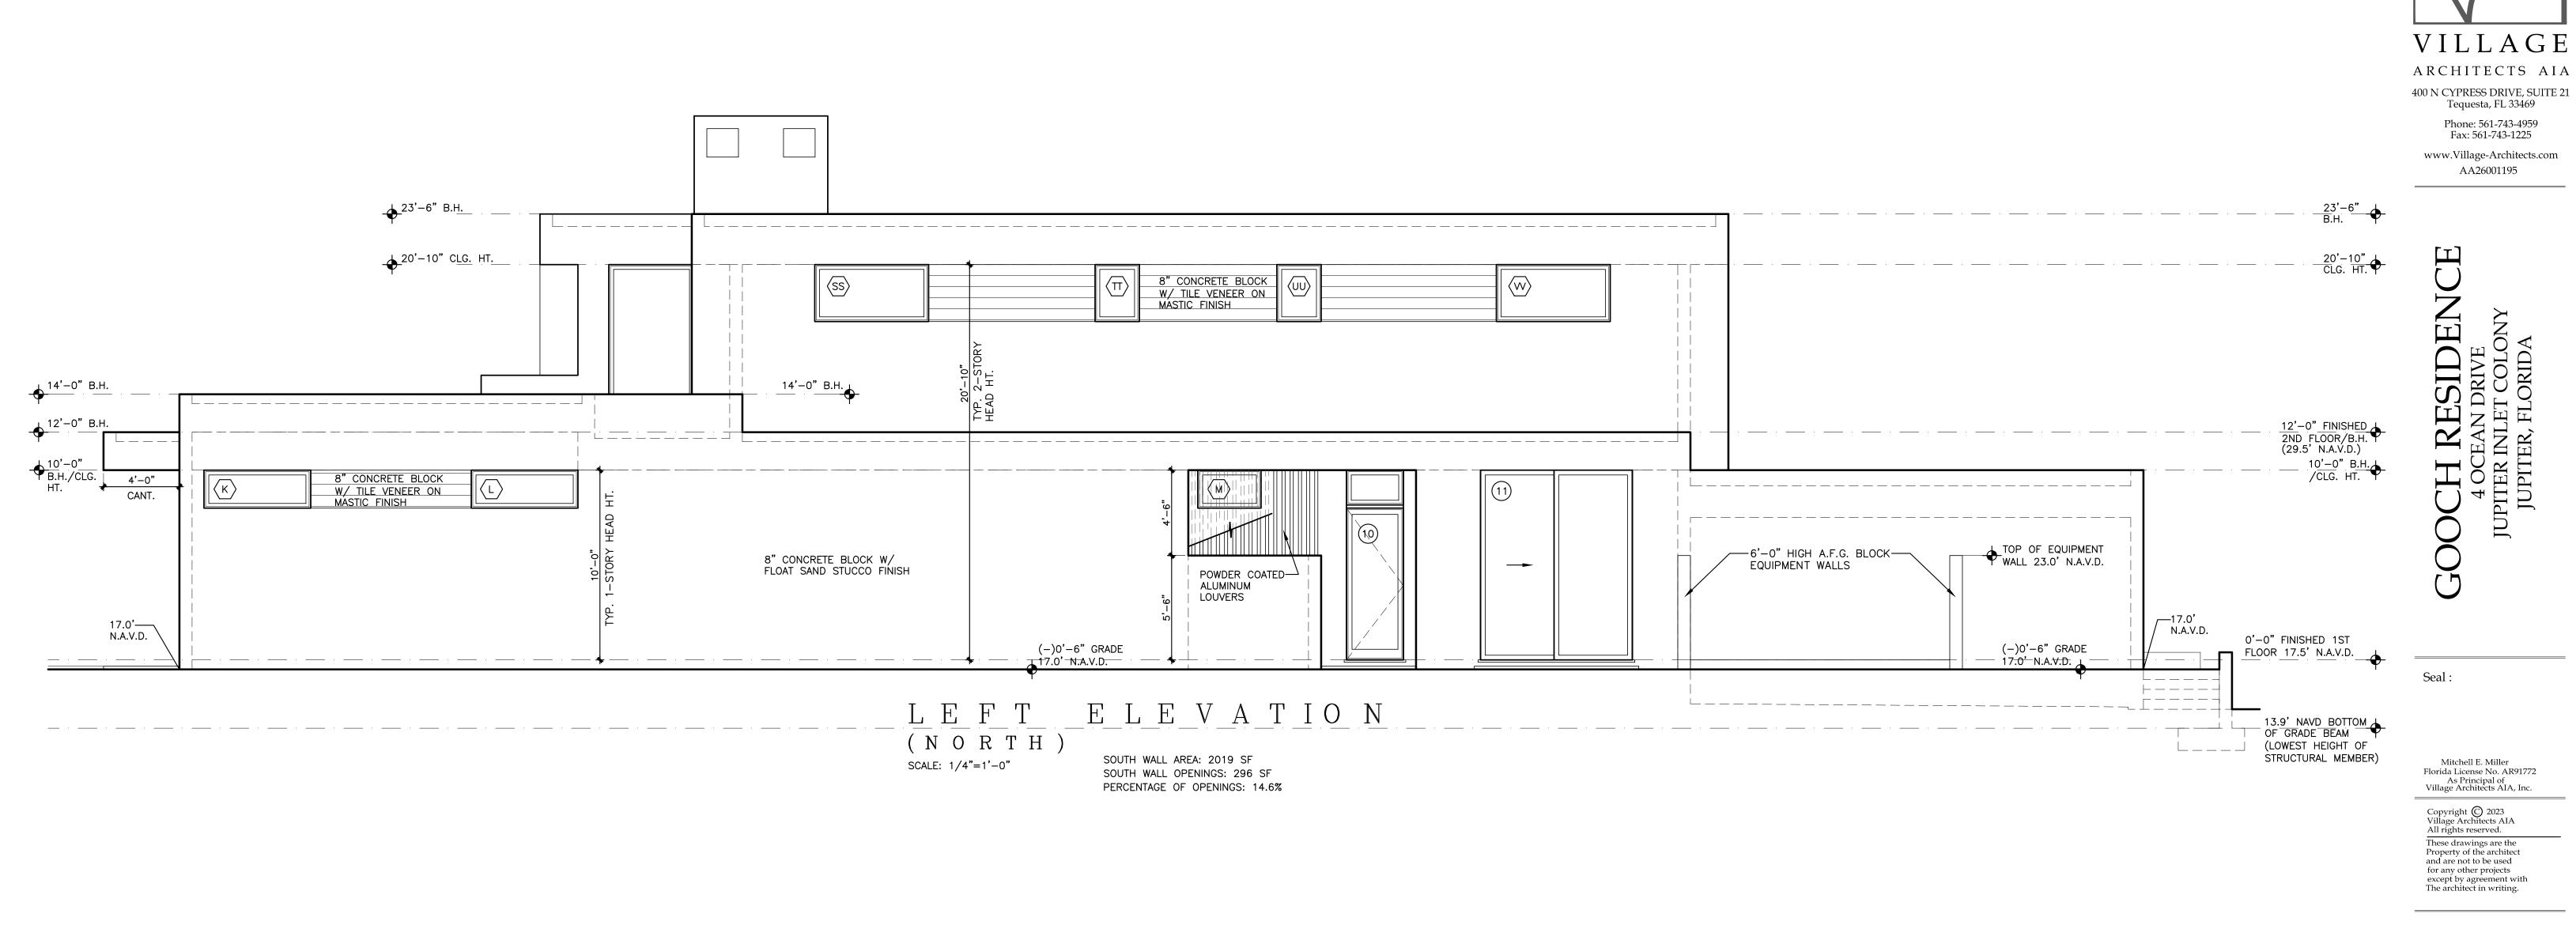

21'-6" TOP OF ROOF

⟨KK⟩

8" CONCRETE BLOCK
W/ TILE VENEER ON
MASTIC FINISH

SOUTH WALL AREA: 2019 SF

SOUTH WALL OPENINGS: 379 SF PERCENTAGE OF OPENINGS: 18.7%

E L E V A T I O N

8" CONCRETE BLOCK
W/ TILE VENEER ON
MASTIC FINISH


(-)0'-6" GRADE 17.0'-N.A.V.D.

||EGRESS

(SOUTH)

SCALE: 1/4"=1'-0"

8" CONCRETE BLOCK W/ FLOAT SAND STUCCO FINISH

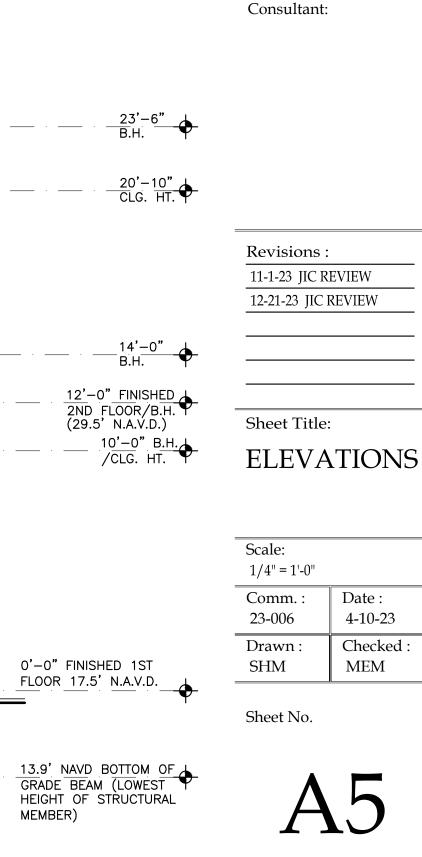

-CUSTOM POWDER COATED ALUM. GUARDRAIL 36" HIGH MIN. W/

STAINLESS STEEL CABLE AT 4"
MIN TO REJECT A 4" SPHERE

-

11'-8" CONC.

BALCONY ELEV.

•

CANT.

<u>__17.0'</u>

N.A.V.D.

POWDER COATED——ALUMINUM LOUVERS

-

4'-0" CANT.

7—17.0' N.A.V.D.

(-)2'-7|1/4" ENTRY GRADE

∟14.9'N.Á.V.D.

12'-0" FINISHED 2ND FLOOR/B.H. (29.5' N.A.V.D.)

10'-0" B.H./_

23'-6" B.H.

N.A.V.D.

- - - - - -

EXTERIOR ENTRY STAIR:

5 RISERS AT 5.0625"

EACH, 12" TREADS

20'-10" CLG. HT.

TOP OF EQUIPMENT WALL 23.0' N.A.V.D.

6'-0" HIGH A.F.G. BLOCK EQUIPMENT WALLS-

7" THICK CANTILEVERED—

7" THICK CANTILEVERED-


CONCRETE SUN SHELF

CONCRETE SUN SHELF



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AA26001195

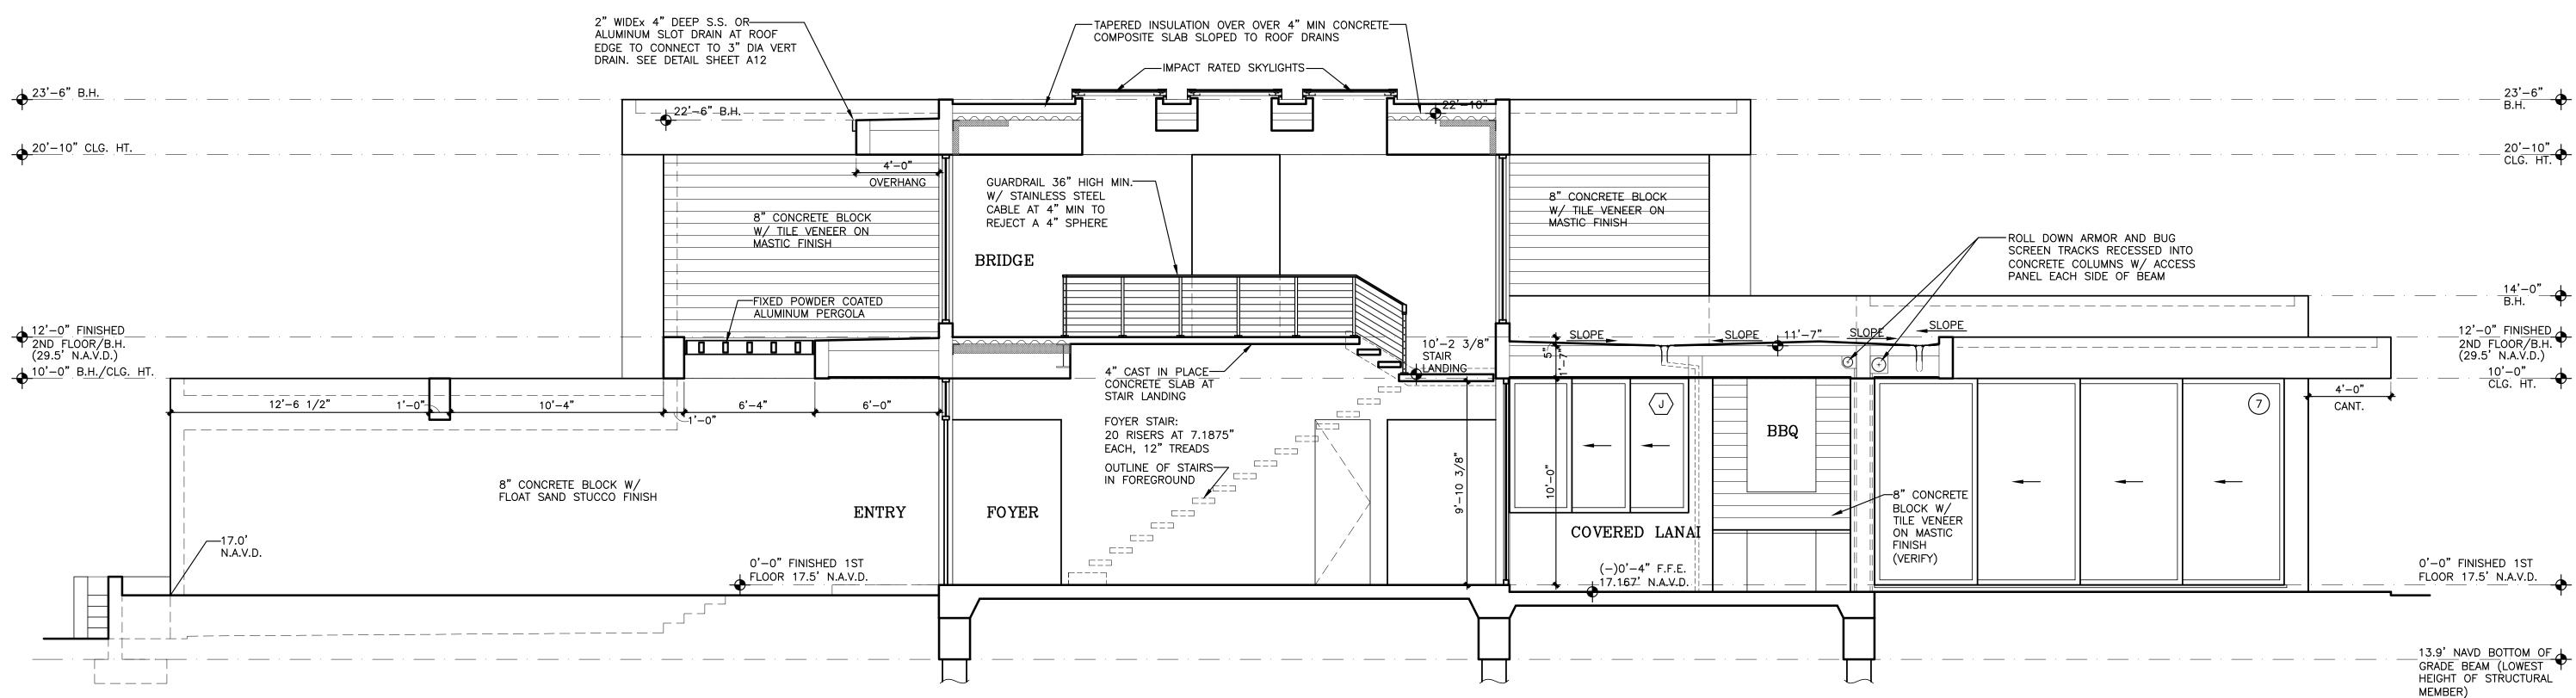

BUILDING SECTION — B

CHIMNEY NOTE: CHIMNEY SHALL EXTEND AT LEAST 3 FEET ABOVE THE HIGHEST POINT 8'-1 1/2" 7'-0 1/2" WHERE THEY PASS THRU THE ROOF AND 2 FEET HIGHER THAN ANY ROOF WITHIN 10 FEET TAPERED INSULATION OVER OVER 4" MIN CONCRETE— ___2" WIDEx 4" DEEP S.S. OR COMPOSITE SLAB SLOPED TO ROOF DRAINS ALUMINUM SLOT DRAIN AT ROOF EDGE TO CONNECT TO 3" DIA VERT —IMPACT RATED SKYLIGHTS— DRAIN. SEE DETAIL SHEET A12 _ _ _ _ _ _ _ _ _ _ 4'-0" $\langle MM \rangle$ $\langle NN \rangle$ OVERHANG 8" CONCRETE BLOCK DECK. EXTEND INSULATION TO BEAM. W/ TILE VENEER ON MÁSTIC FINISH BRIDGE -GUARDRAIL 36" HIGH MIN.--W/ STAINLESS STEEL CABLE AT 4" MIN TO REJECT A 4" SPHERE FIXED POWDER COATED— ALUMINUM PERGOLA 12'-0" FINISHED 2ND FLOOR/B.H. (29.5' N.A.V.D.) 12'-0" FINISHED 2ND FLOOR/B.H. (29.5' N.A.V.D.) 11'-10" 10'-2 3/8" STAIR LANDING--0 0 0 0 10'-0" CLG. HT. OPEN CELL SPRAY FOAM—
INSULATION AT BOTTOM 10'-0" B.H. /CLG. HT. 4'-0" / 16'-9 1/2" ROLL DOWN ARMOR AND BUG SCREEN TRACKS RECESSED INTO 8" CONCRETE BLOCK W/ COVERED FLOAT SAND STUCCO FINISH CONCRETE COLUMNS W/ ACCESS LANAI PANEL EACH SIDE OF BEAM FOYER ENTRY LINEAR VENT-FREE FIREPLACE T.B.D. N.A.V.D. 0'-0" FINISHED 1ST 0'-0" FINISHED 1ST (-)0'-4" F.F.E. 17.<u>167</u>' N.<u>A.V.</u>D. 0 – 0 FINSTILE -FLOOR 17.5' N.A.V.D. FLOOR 17.5' N.A.V.D. \vdash - - - - -13.9' NAVD BOTTOM OF
GRADE BEAM (LOWEST HEIGHT 13.9' NAVD BOTTOM OF GRADE BEAM (LOWEST OF STRUCTURAL MEMBER) HEIGHT OF STRUCTURAL

BUILDING SECTION—A

GOOCH RESIDENCI
4 OCEAN DRIVE
JUPITER INLET COLONY

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11-1-23 JIC REVIEW
12-21-23 JIC REVIEW

Sheet Title:

BUILDING SECTIONS

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1/4" = 1'-0"

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23-006 4-10-23


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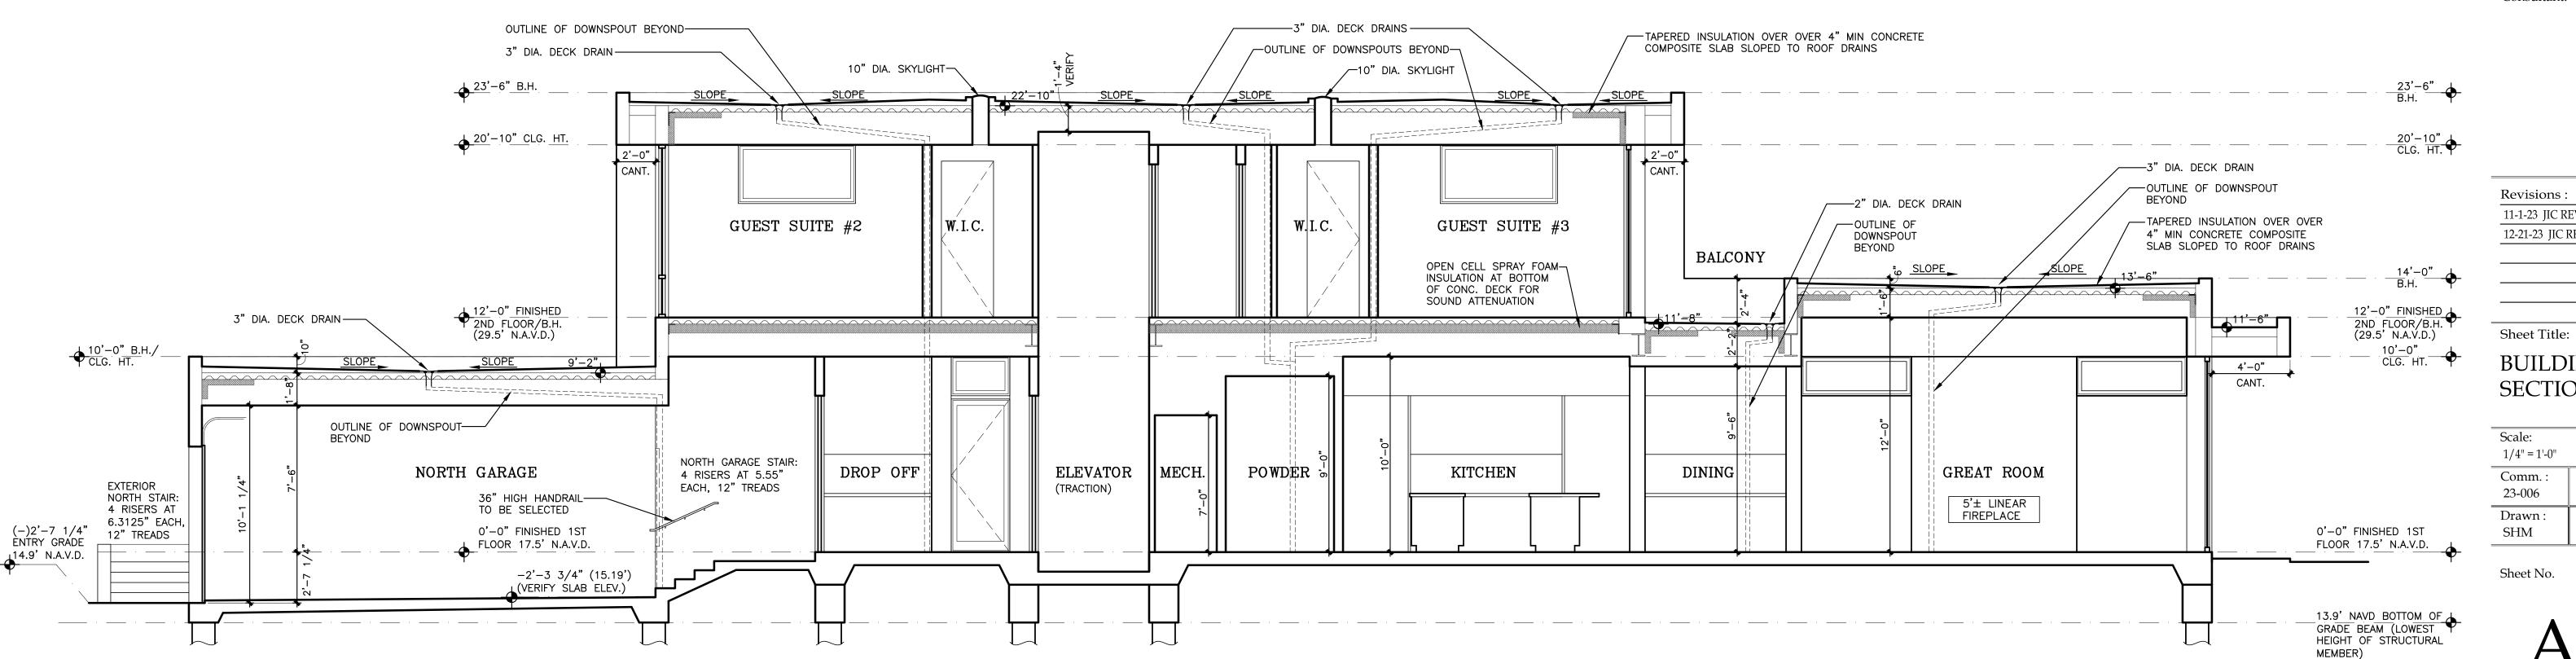
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MEMBER)

A6





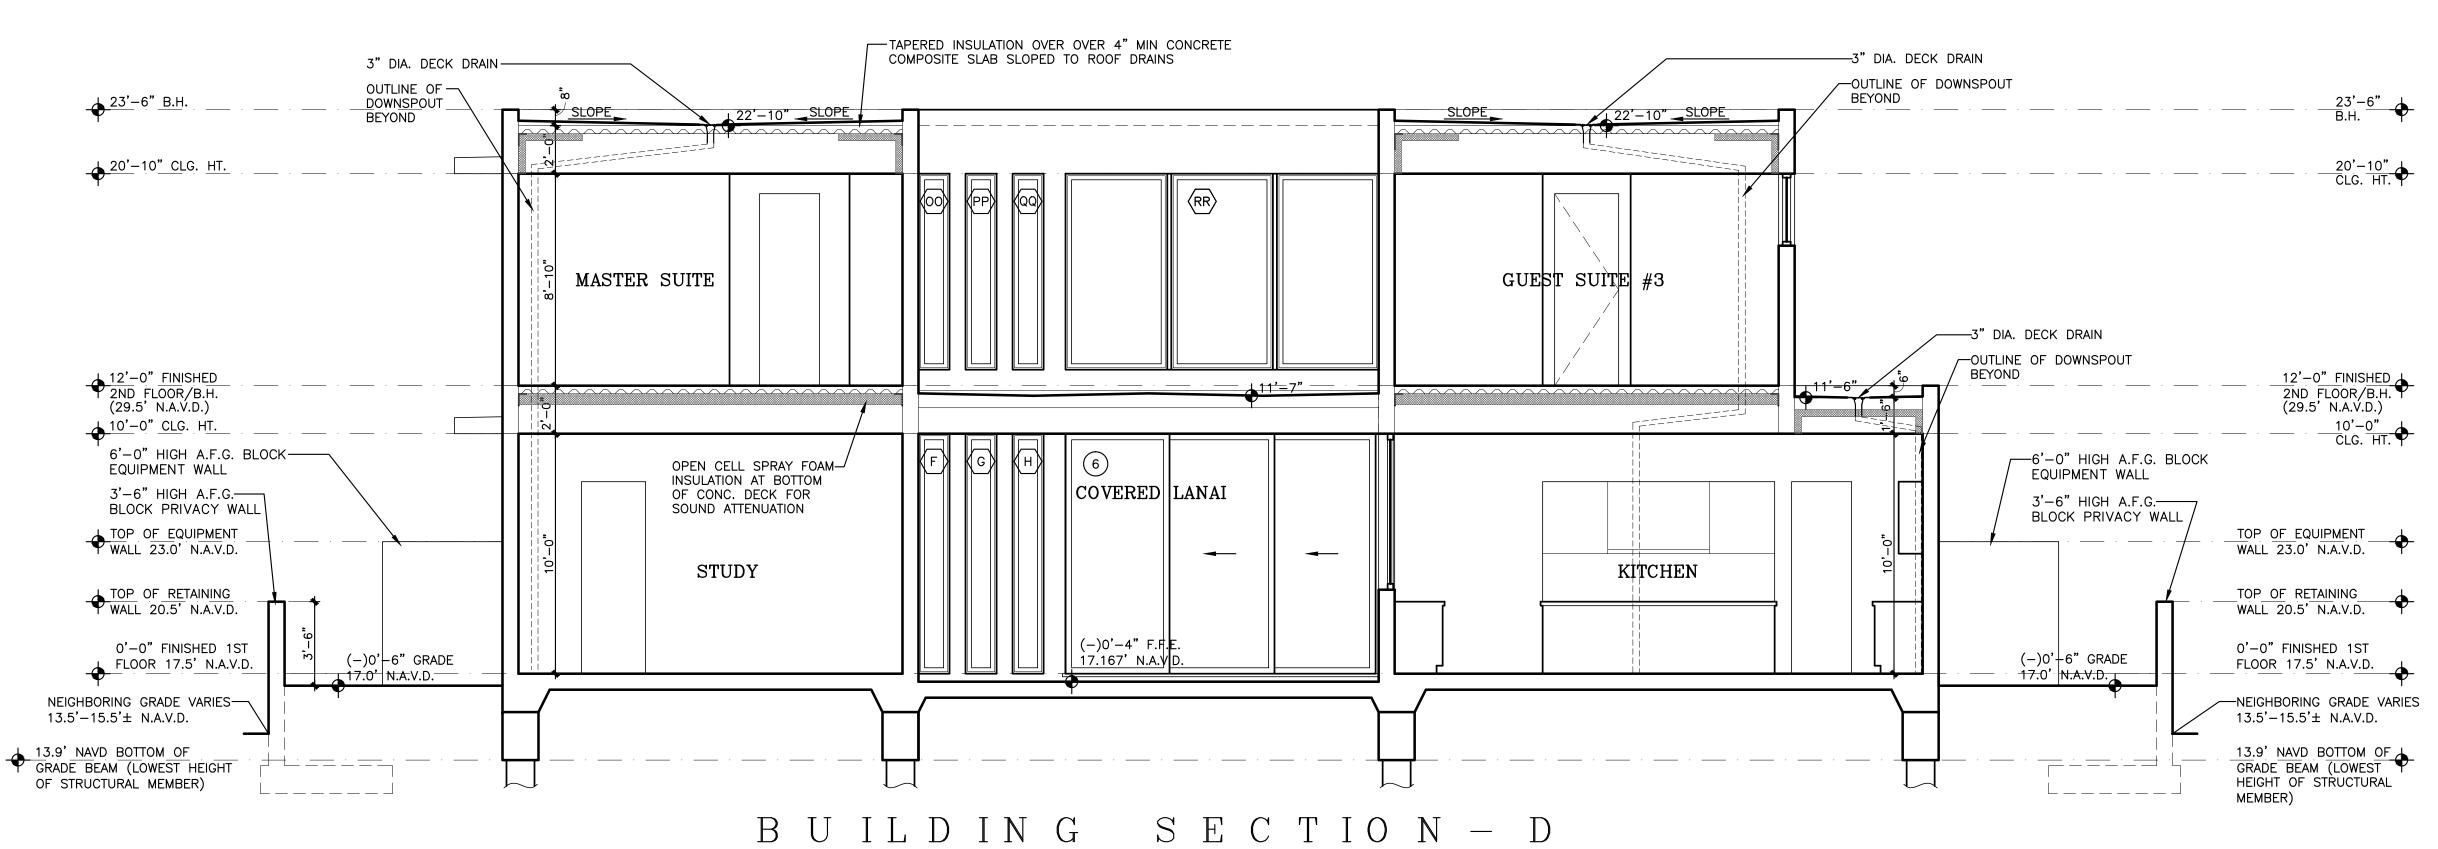

SCALE: 1/4"=1'-0"

BUILDING SECTION - C SCALE: 1/4"=1'-0"

ARCHITECTS AIA 400 N CYPRESS DRIVE, SUITE 21

Tequesta, FL 33469 Phone: 561-743-4959 Fax: 561-743-1225

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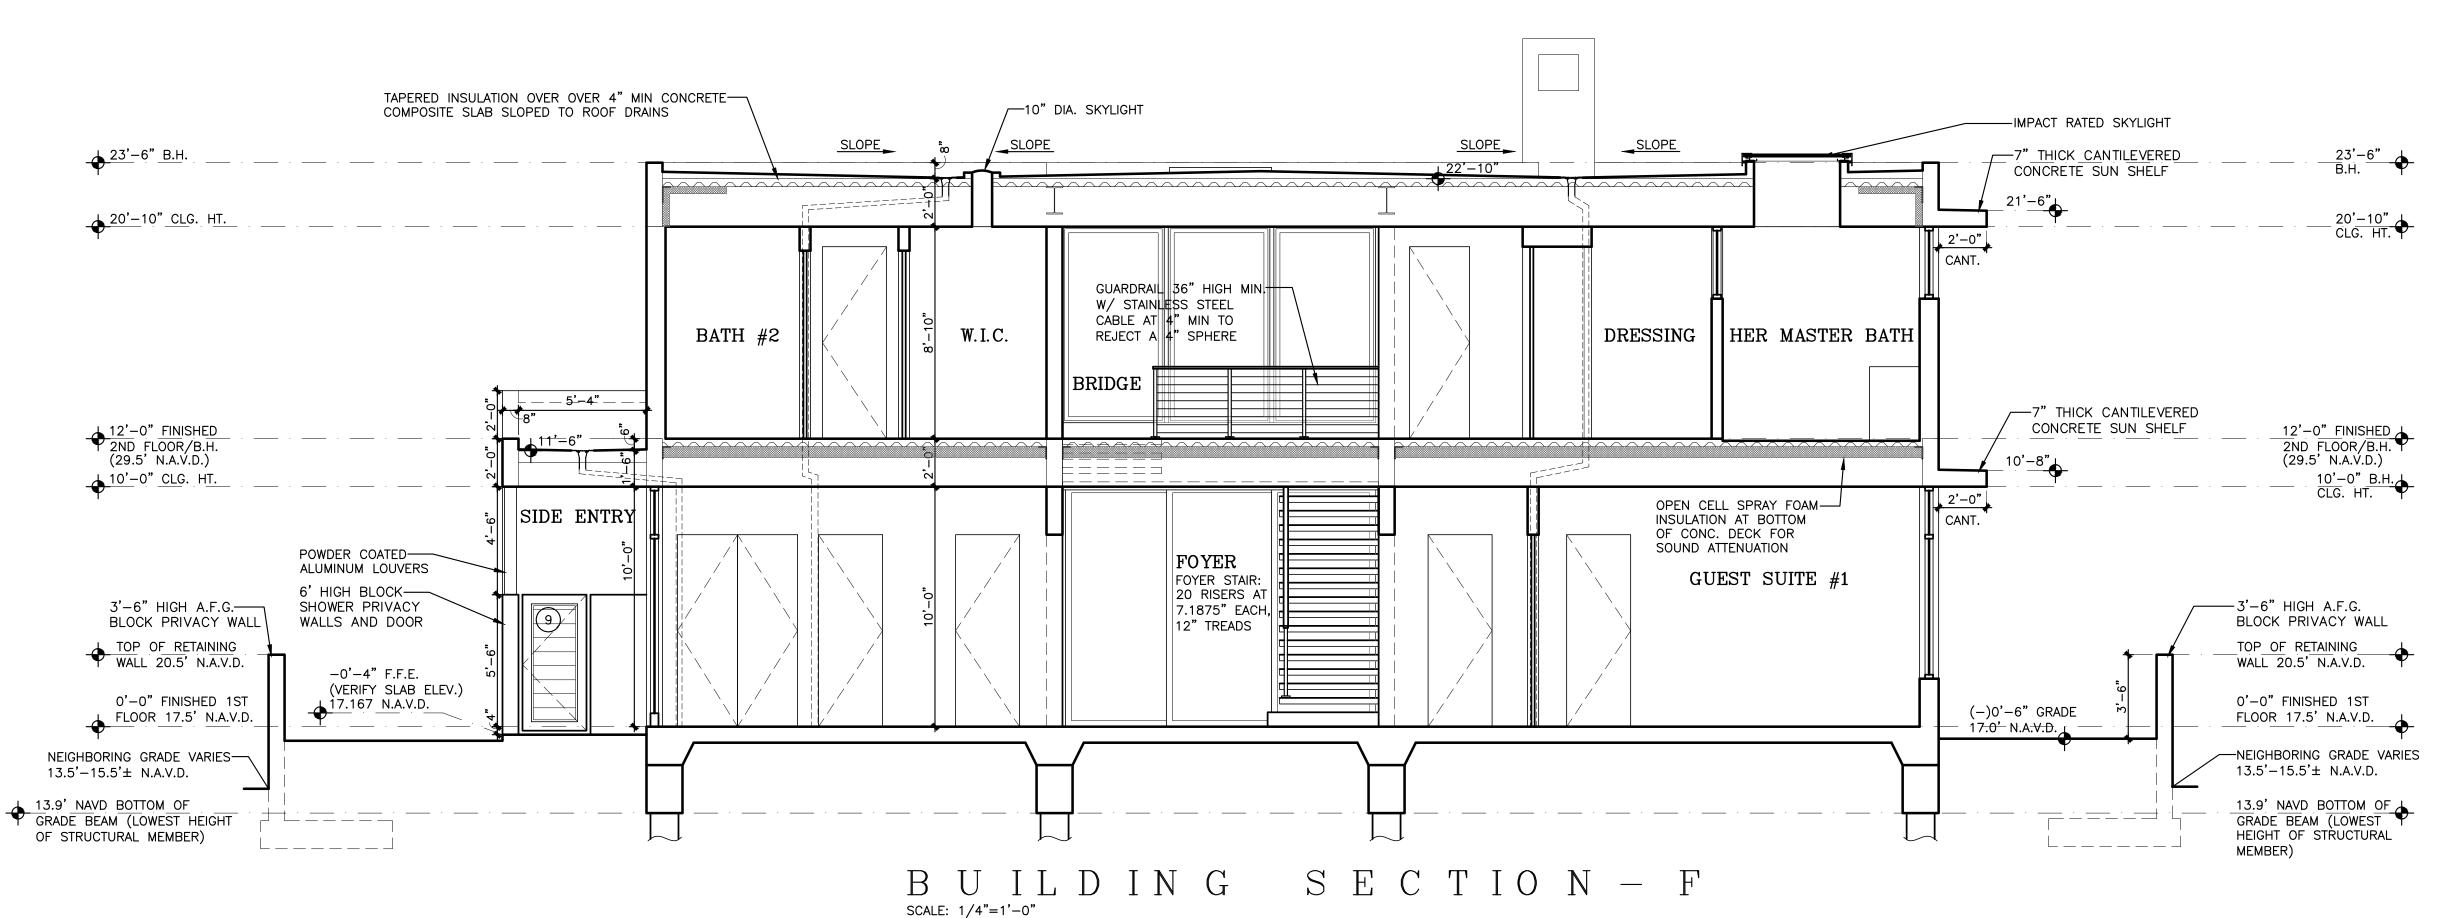
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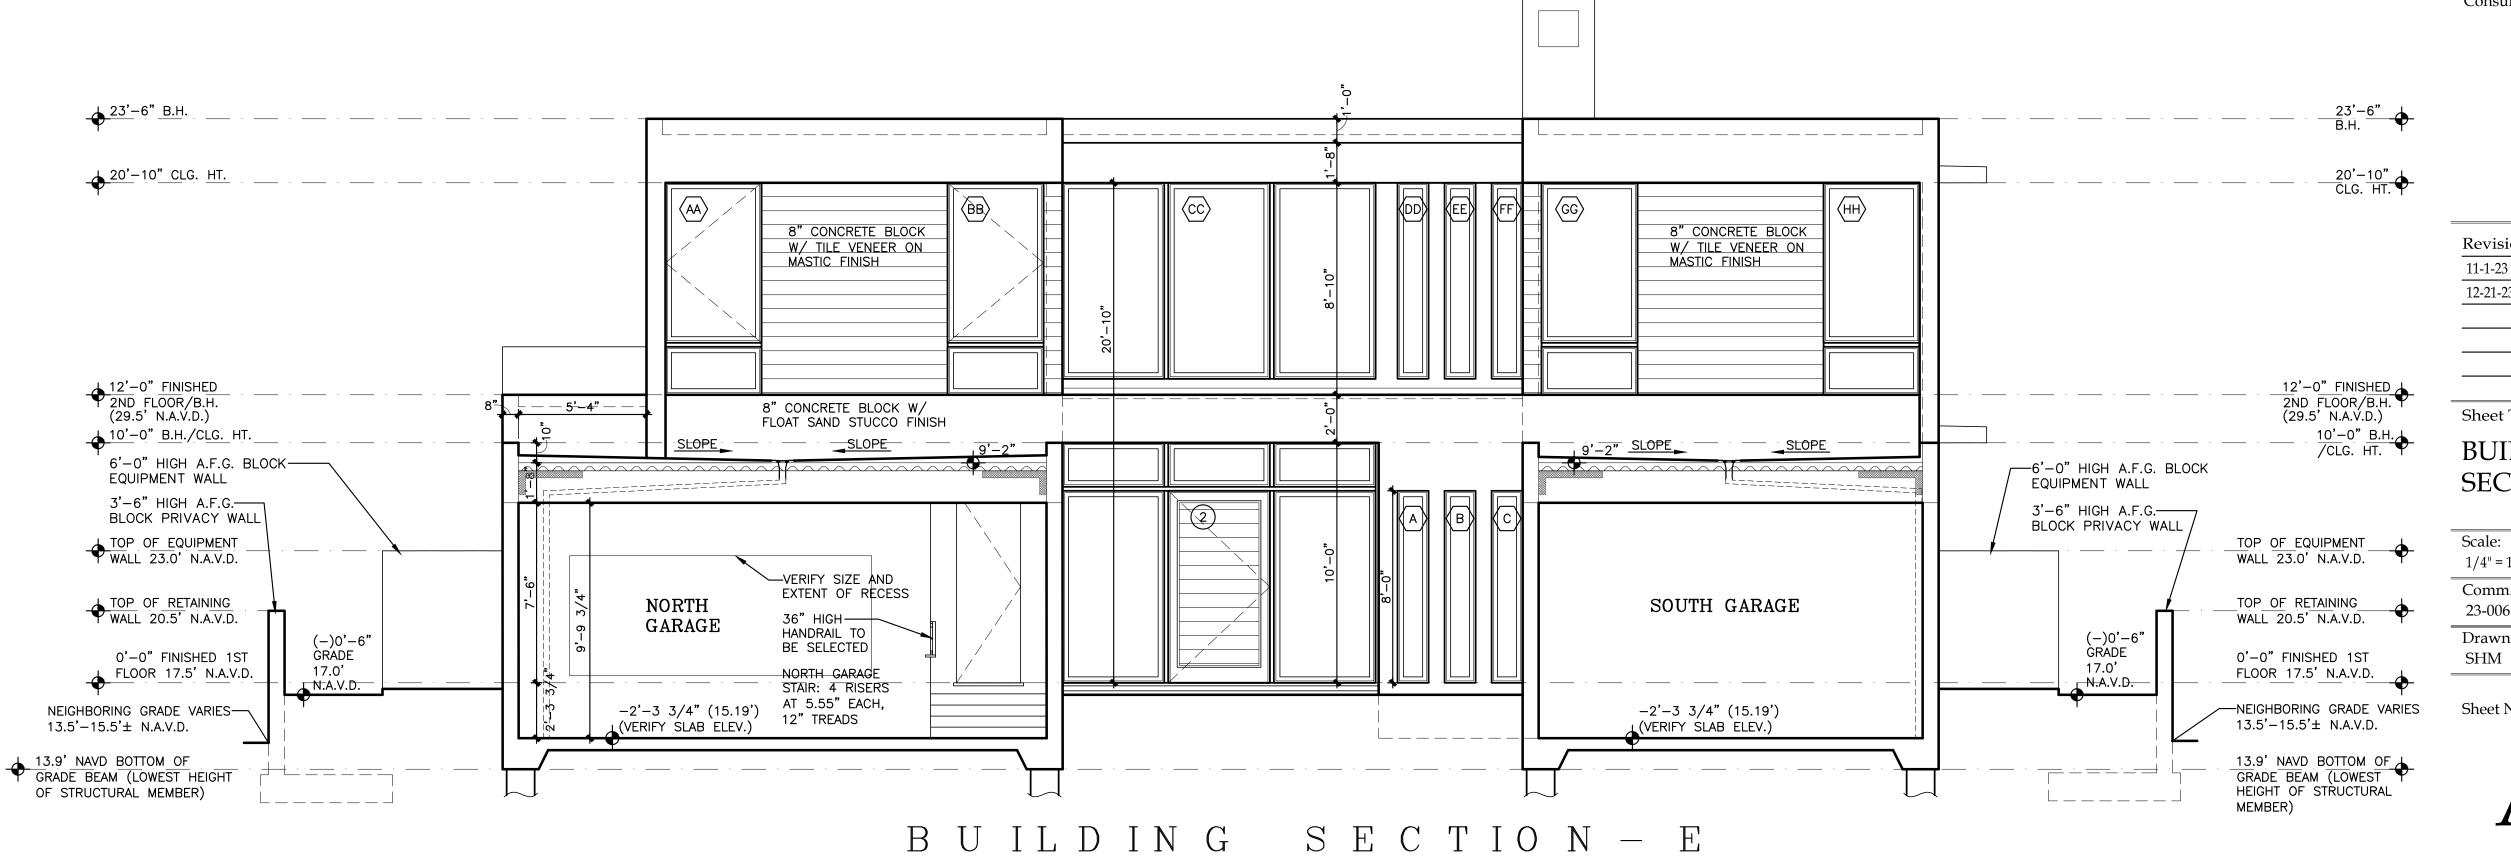
Revisions: 11-1-23 JIC REVIEW 12-21-23 JIC REVIEW

BUILDING **SECTIONS**

Scale: 1/4" = 1'-0" Comm.: 23-006 4-10-23 Drawn: Checked: SHM **MEM**

Sheet No.





SCALE: 1/4"=1'-0"

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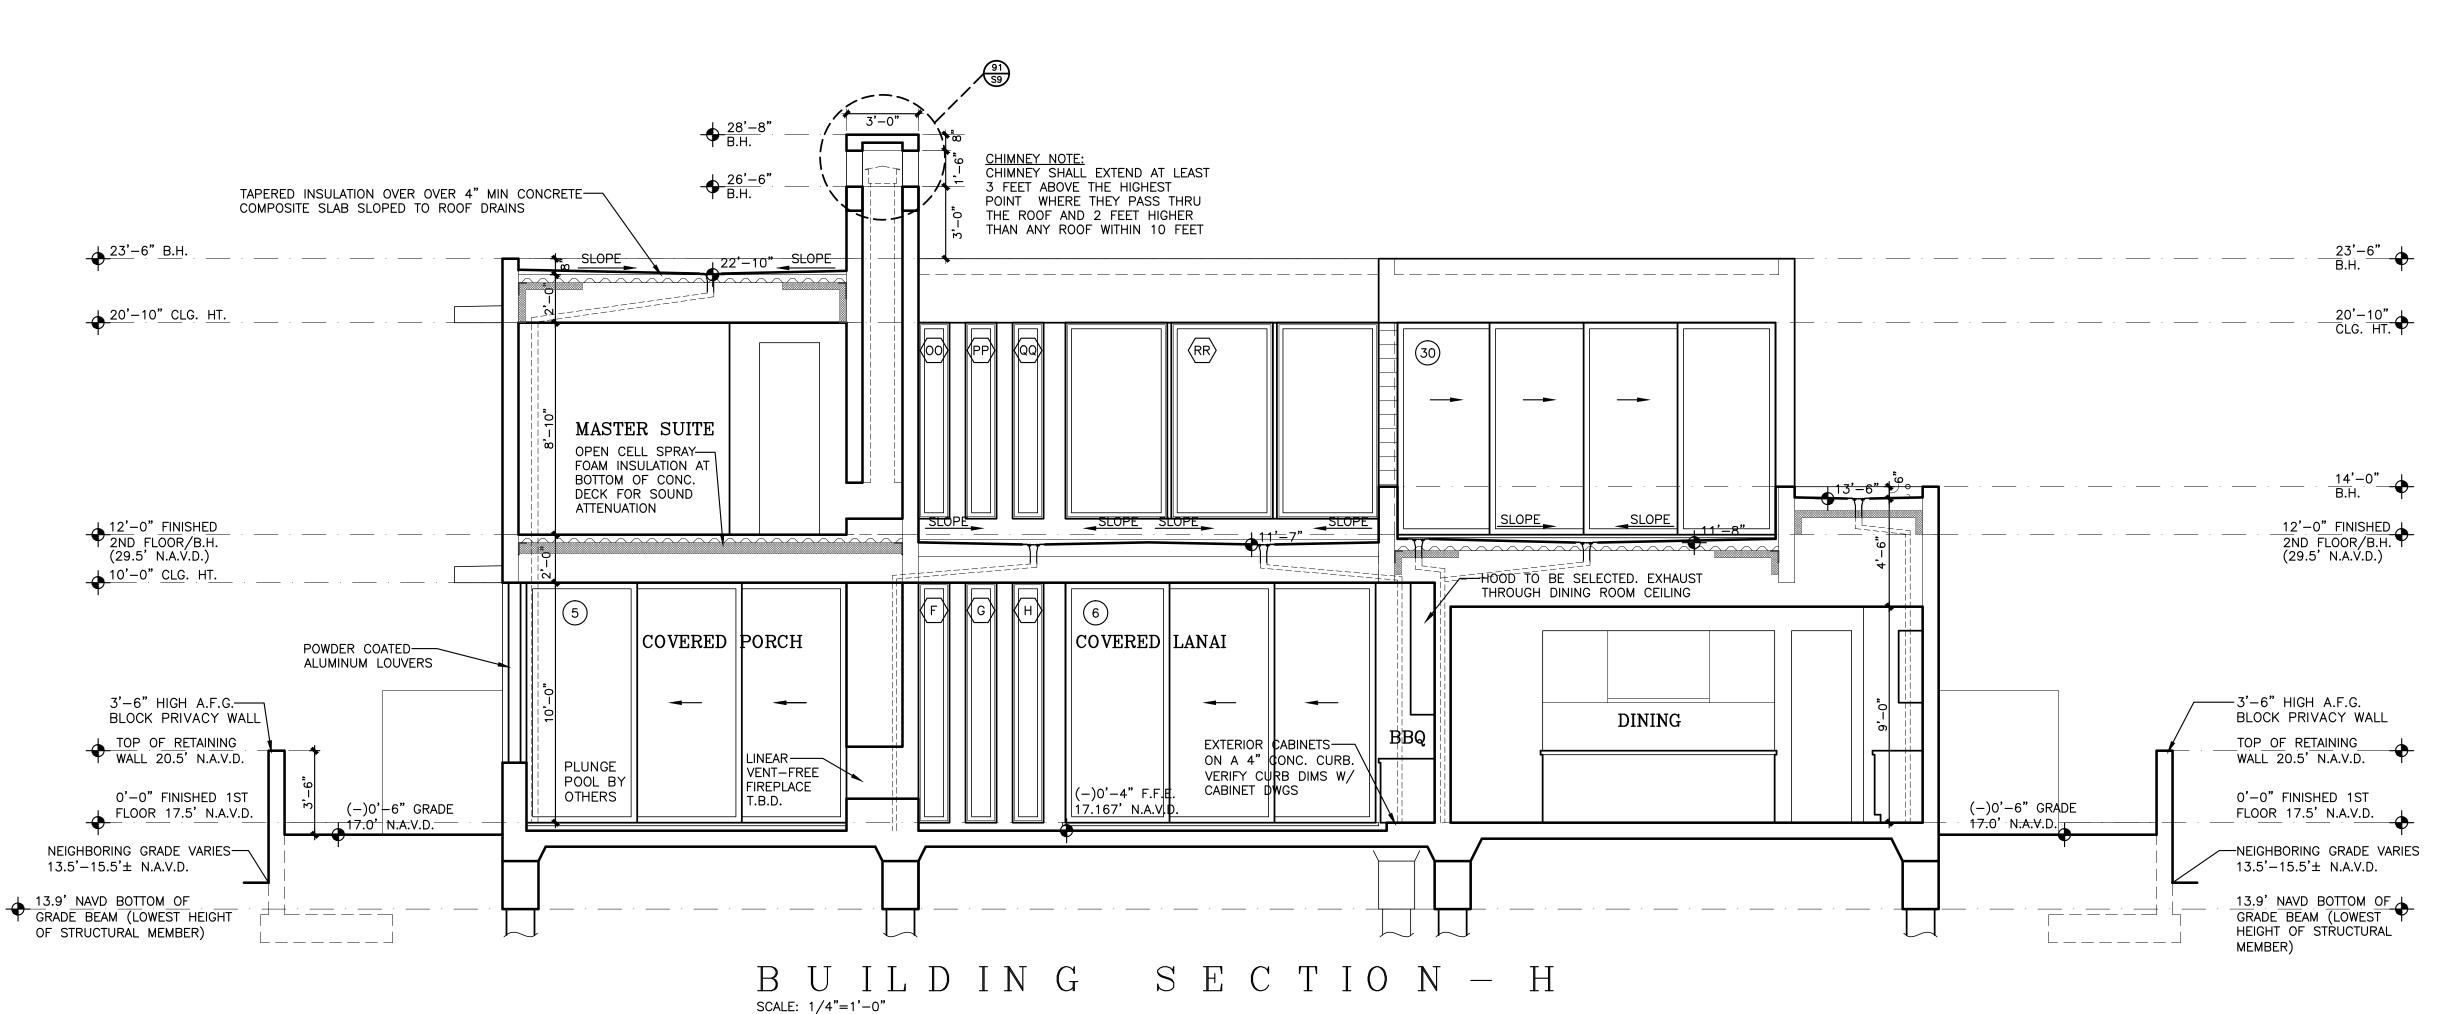
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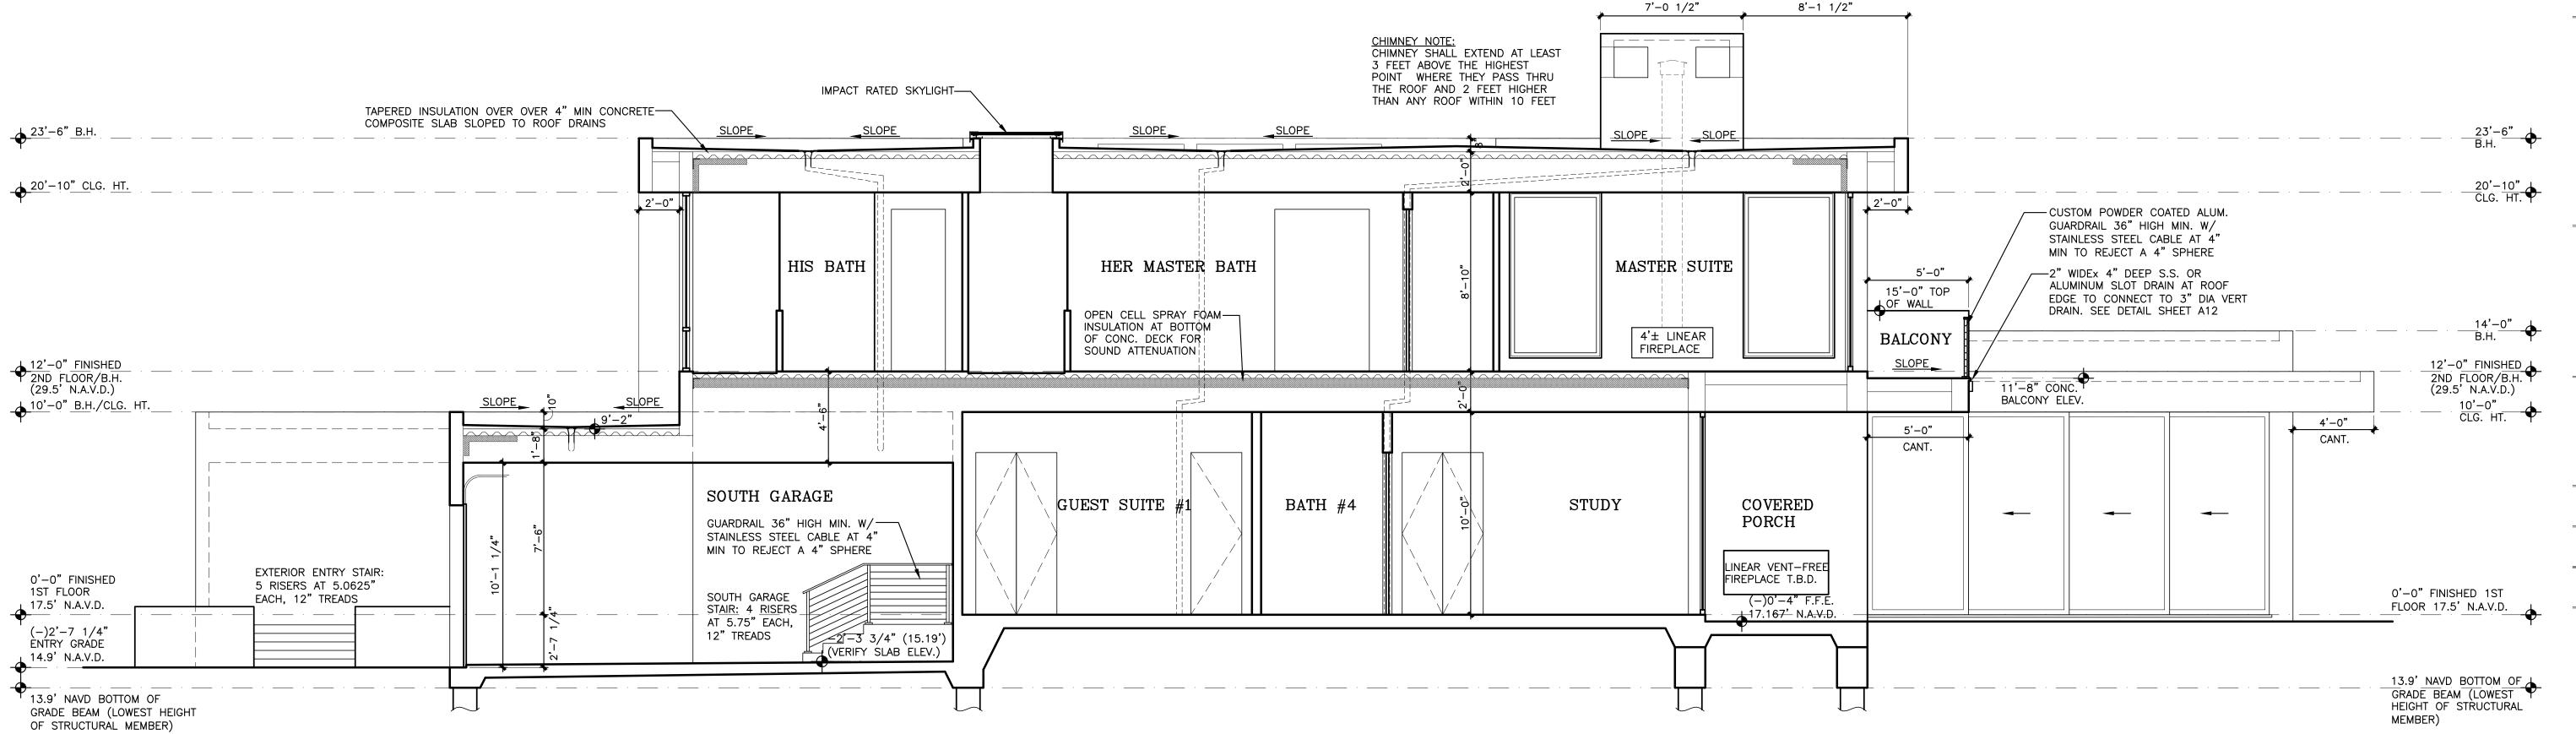
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BUILDING **SECTIONS**

Scale: 1/4" = 1'-0" Comm.: Date: 23-006 4-10-23 Checked: Drawn: MEM

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Sheet Title:
BUILDING

SECTIONS

Scale:
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 Date :

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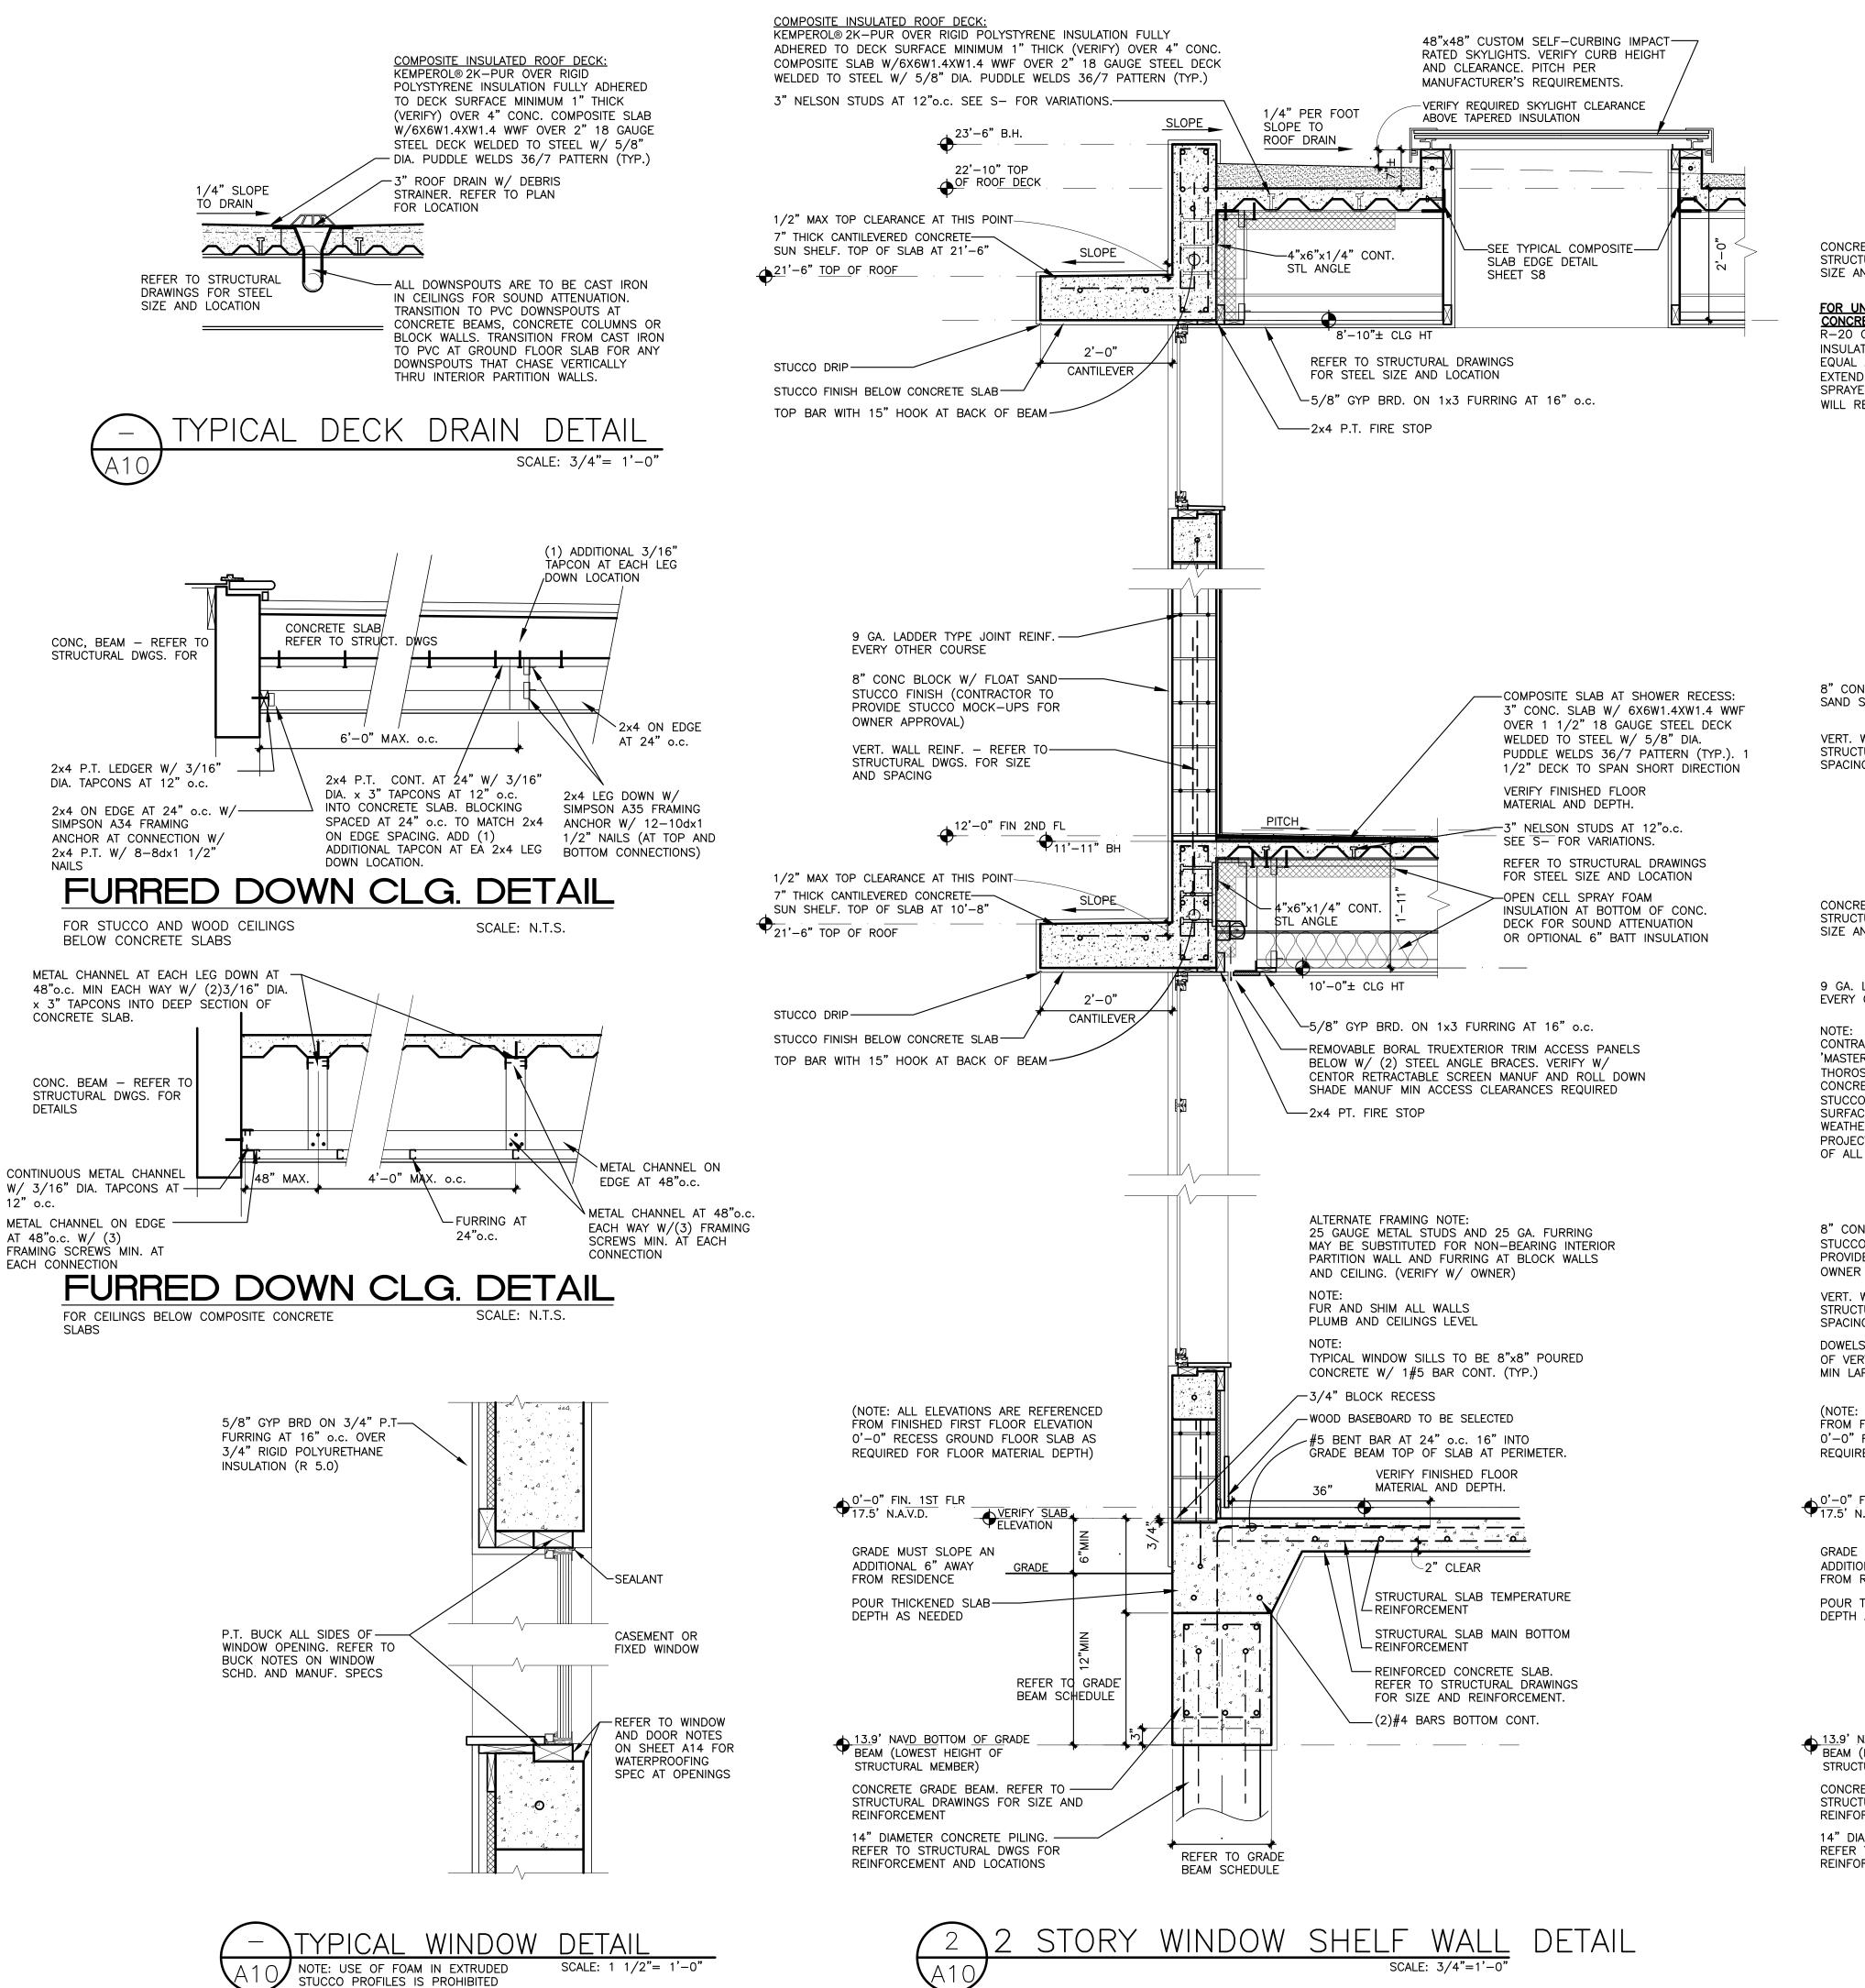
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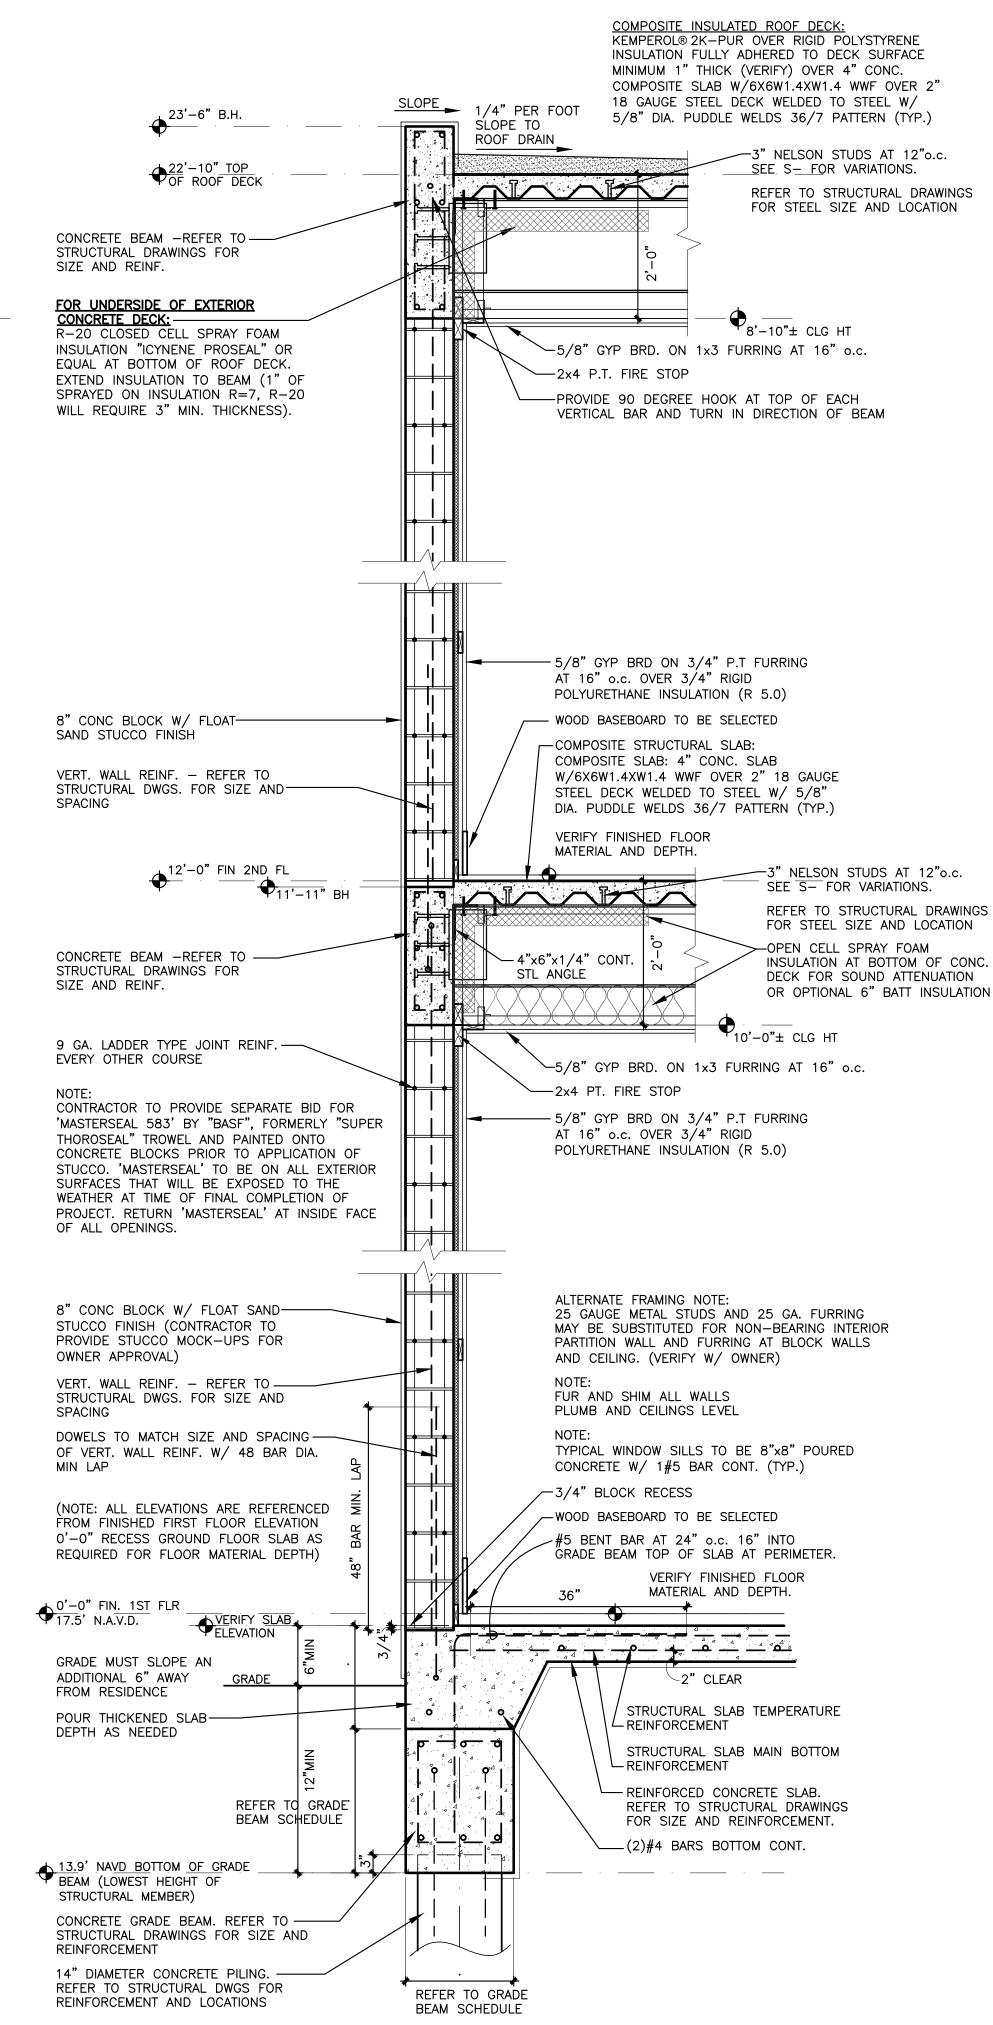
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BUILDING SECTION—G





2 STORY WALL

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MICHAEL BABER FLORIDA PROFESSIONAL ENGINEER, 5257 (FOR STRUCTURE ONLY)

Revisions: 11-1-23 JIC REVIEW 12-21-23 JIC REVIEW


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DETAILS

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Consultant:

MICHAEL BABER

Palm Beach Gardens, FL 33410

PH: (561) 863-3393

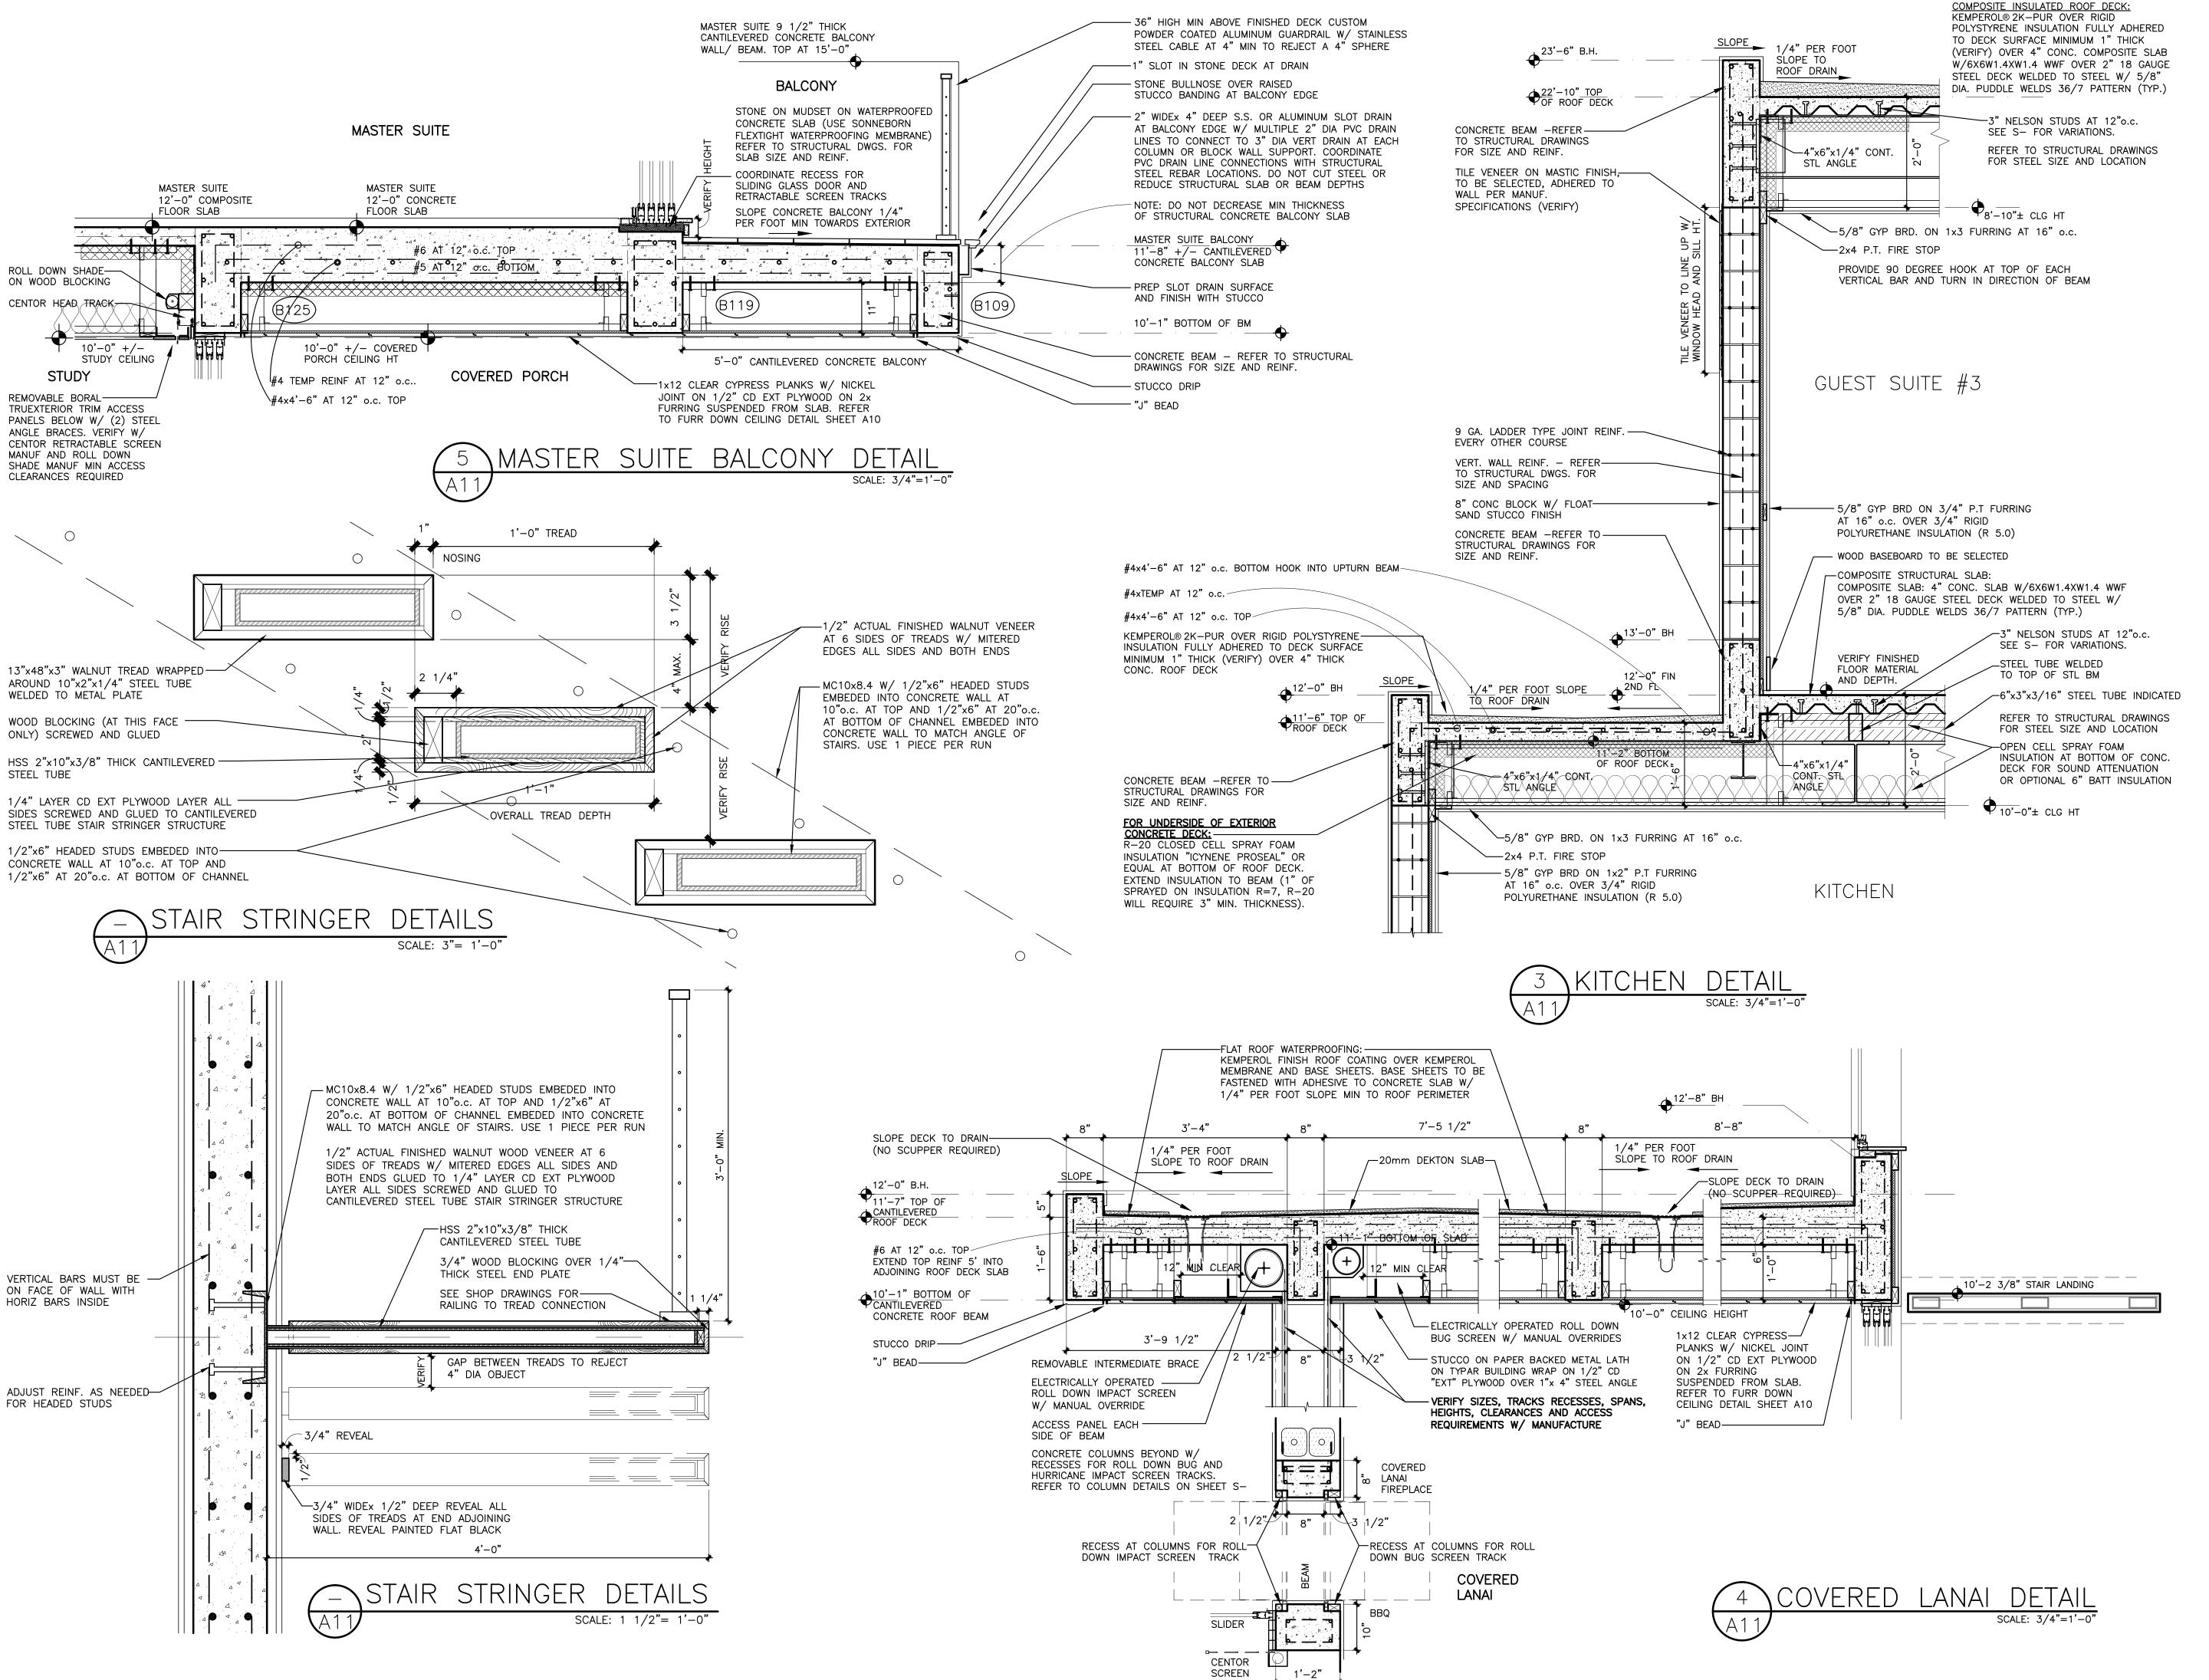FLORIDA PROFESSIONAL ENGINEER, 5257:
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DETAILS

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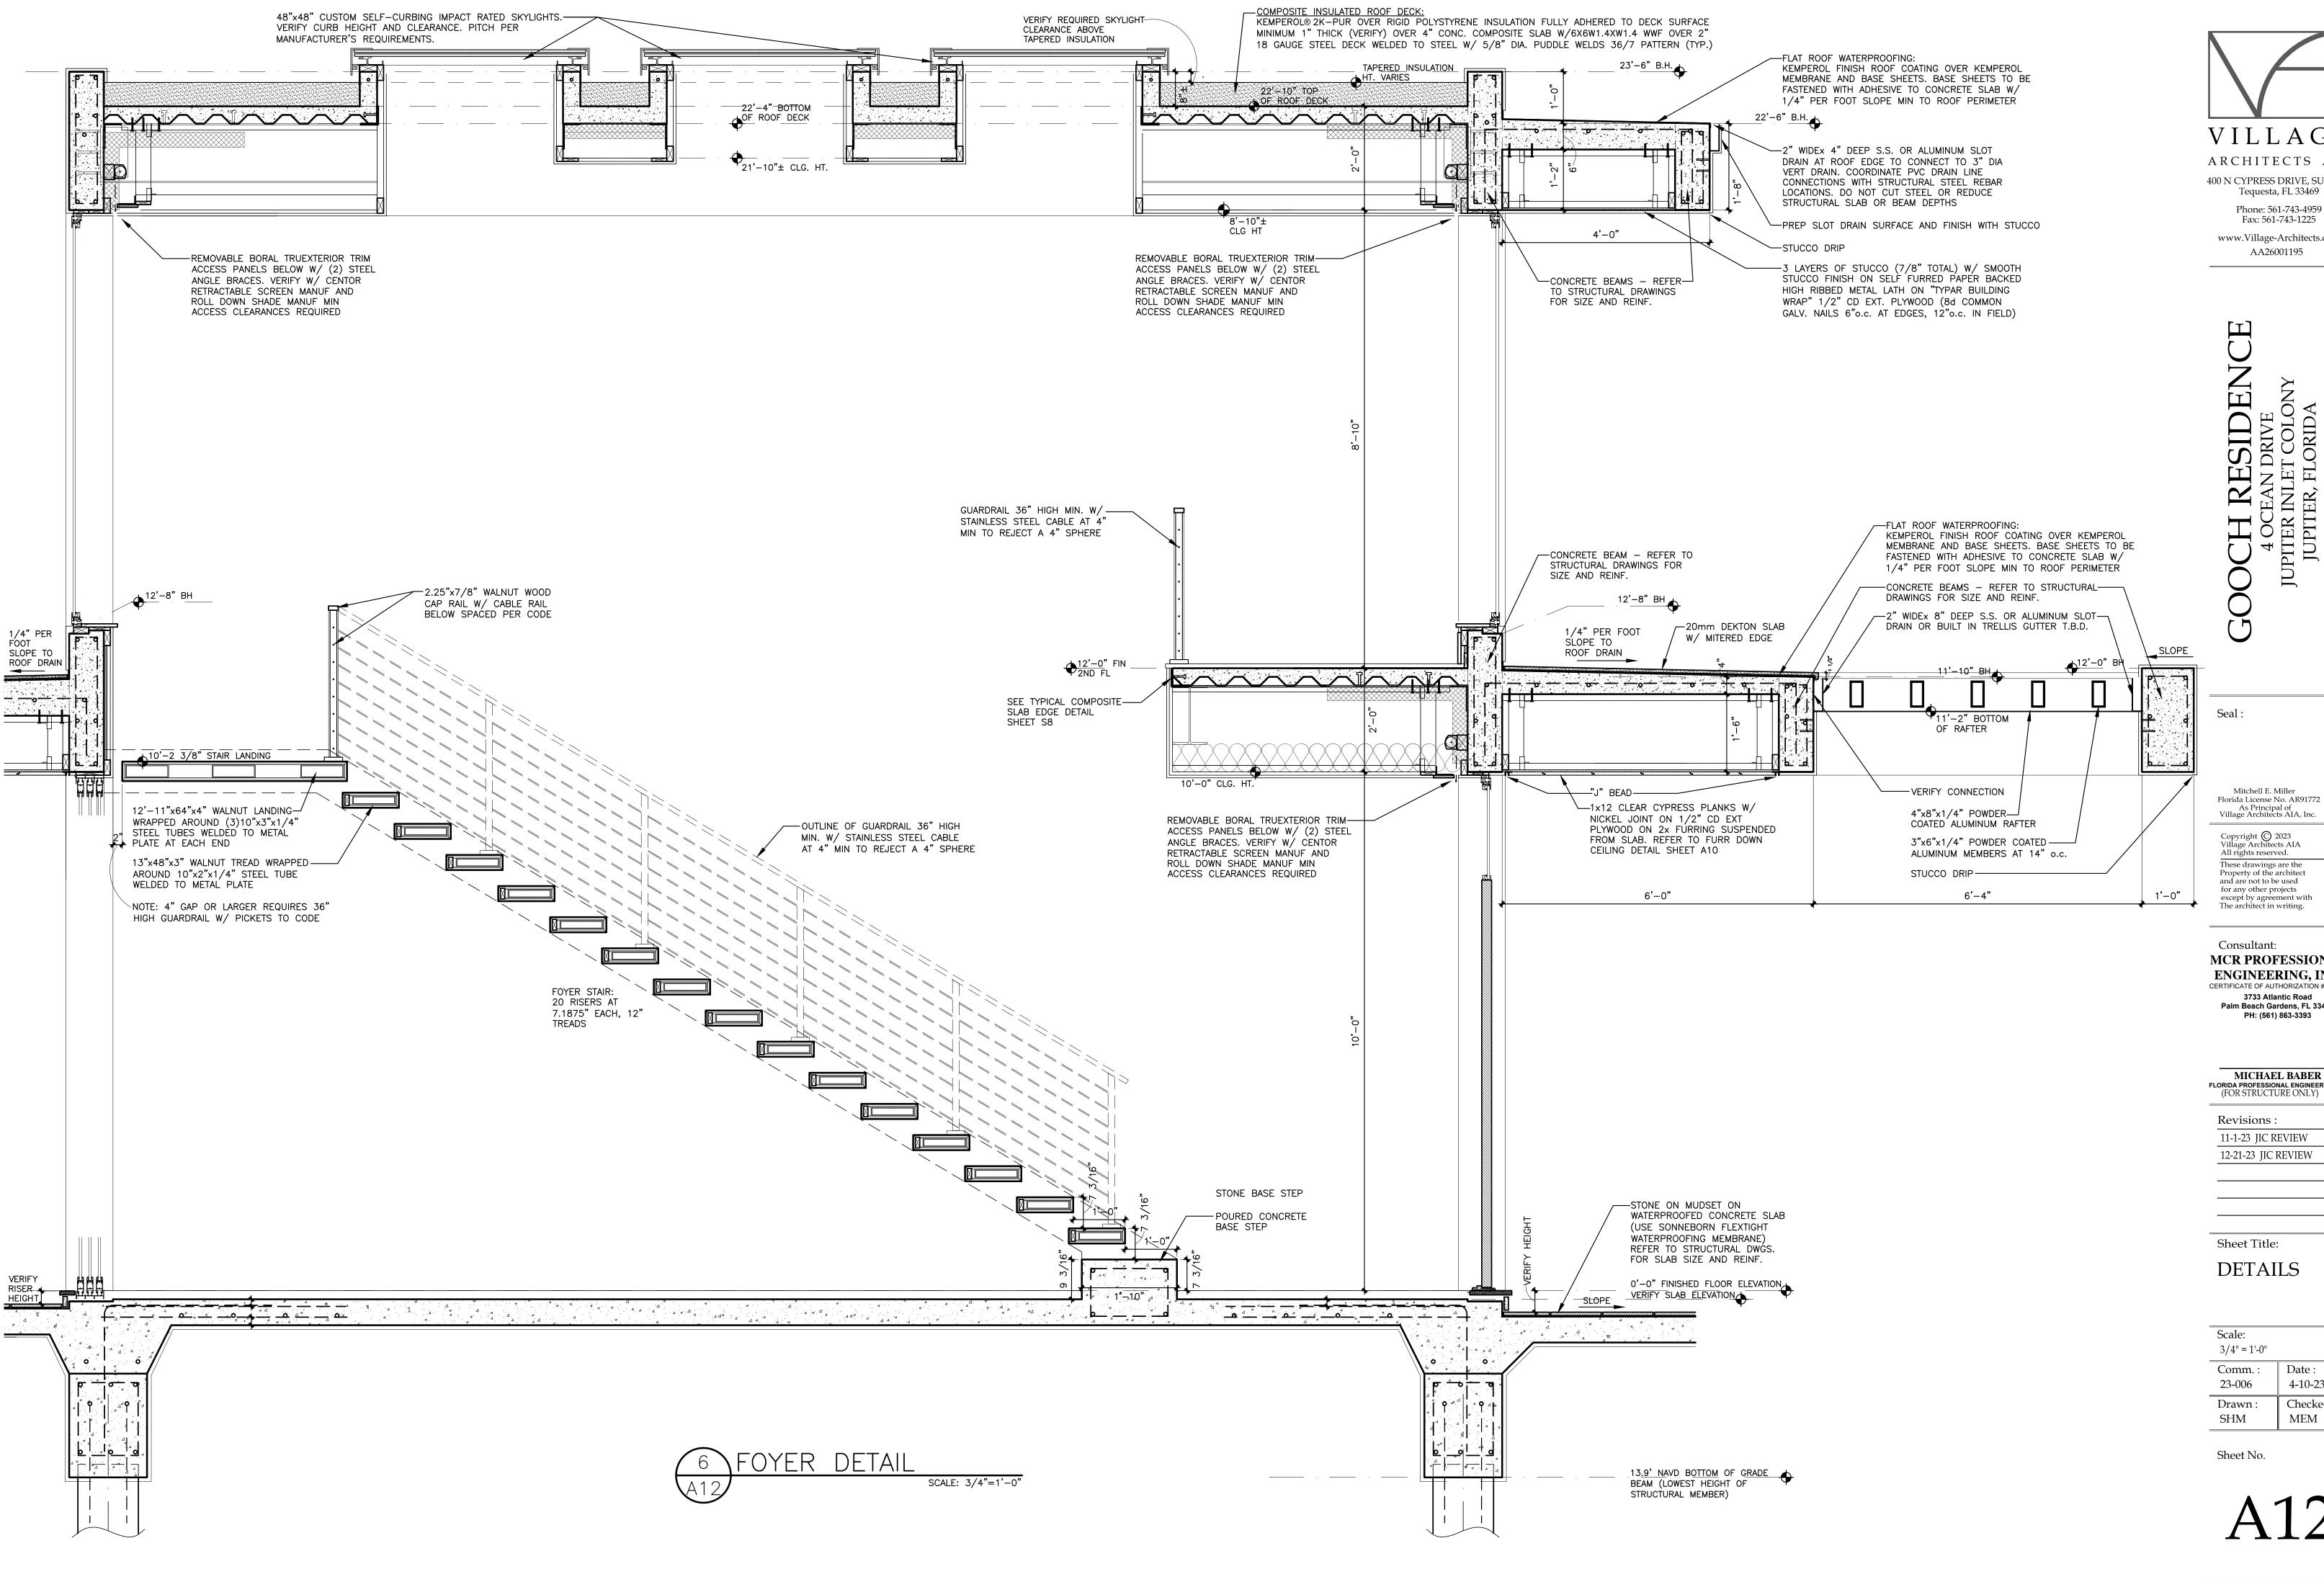
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VILLAGE

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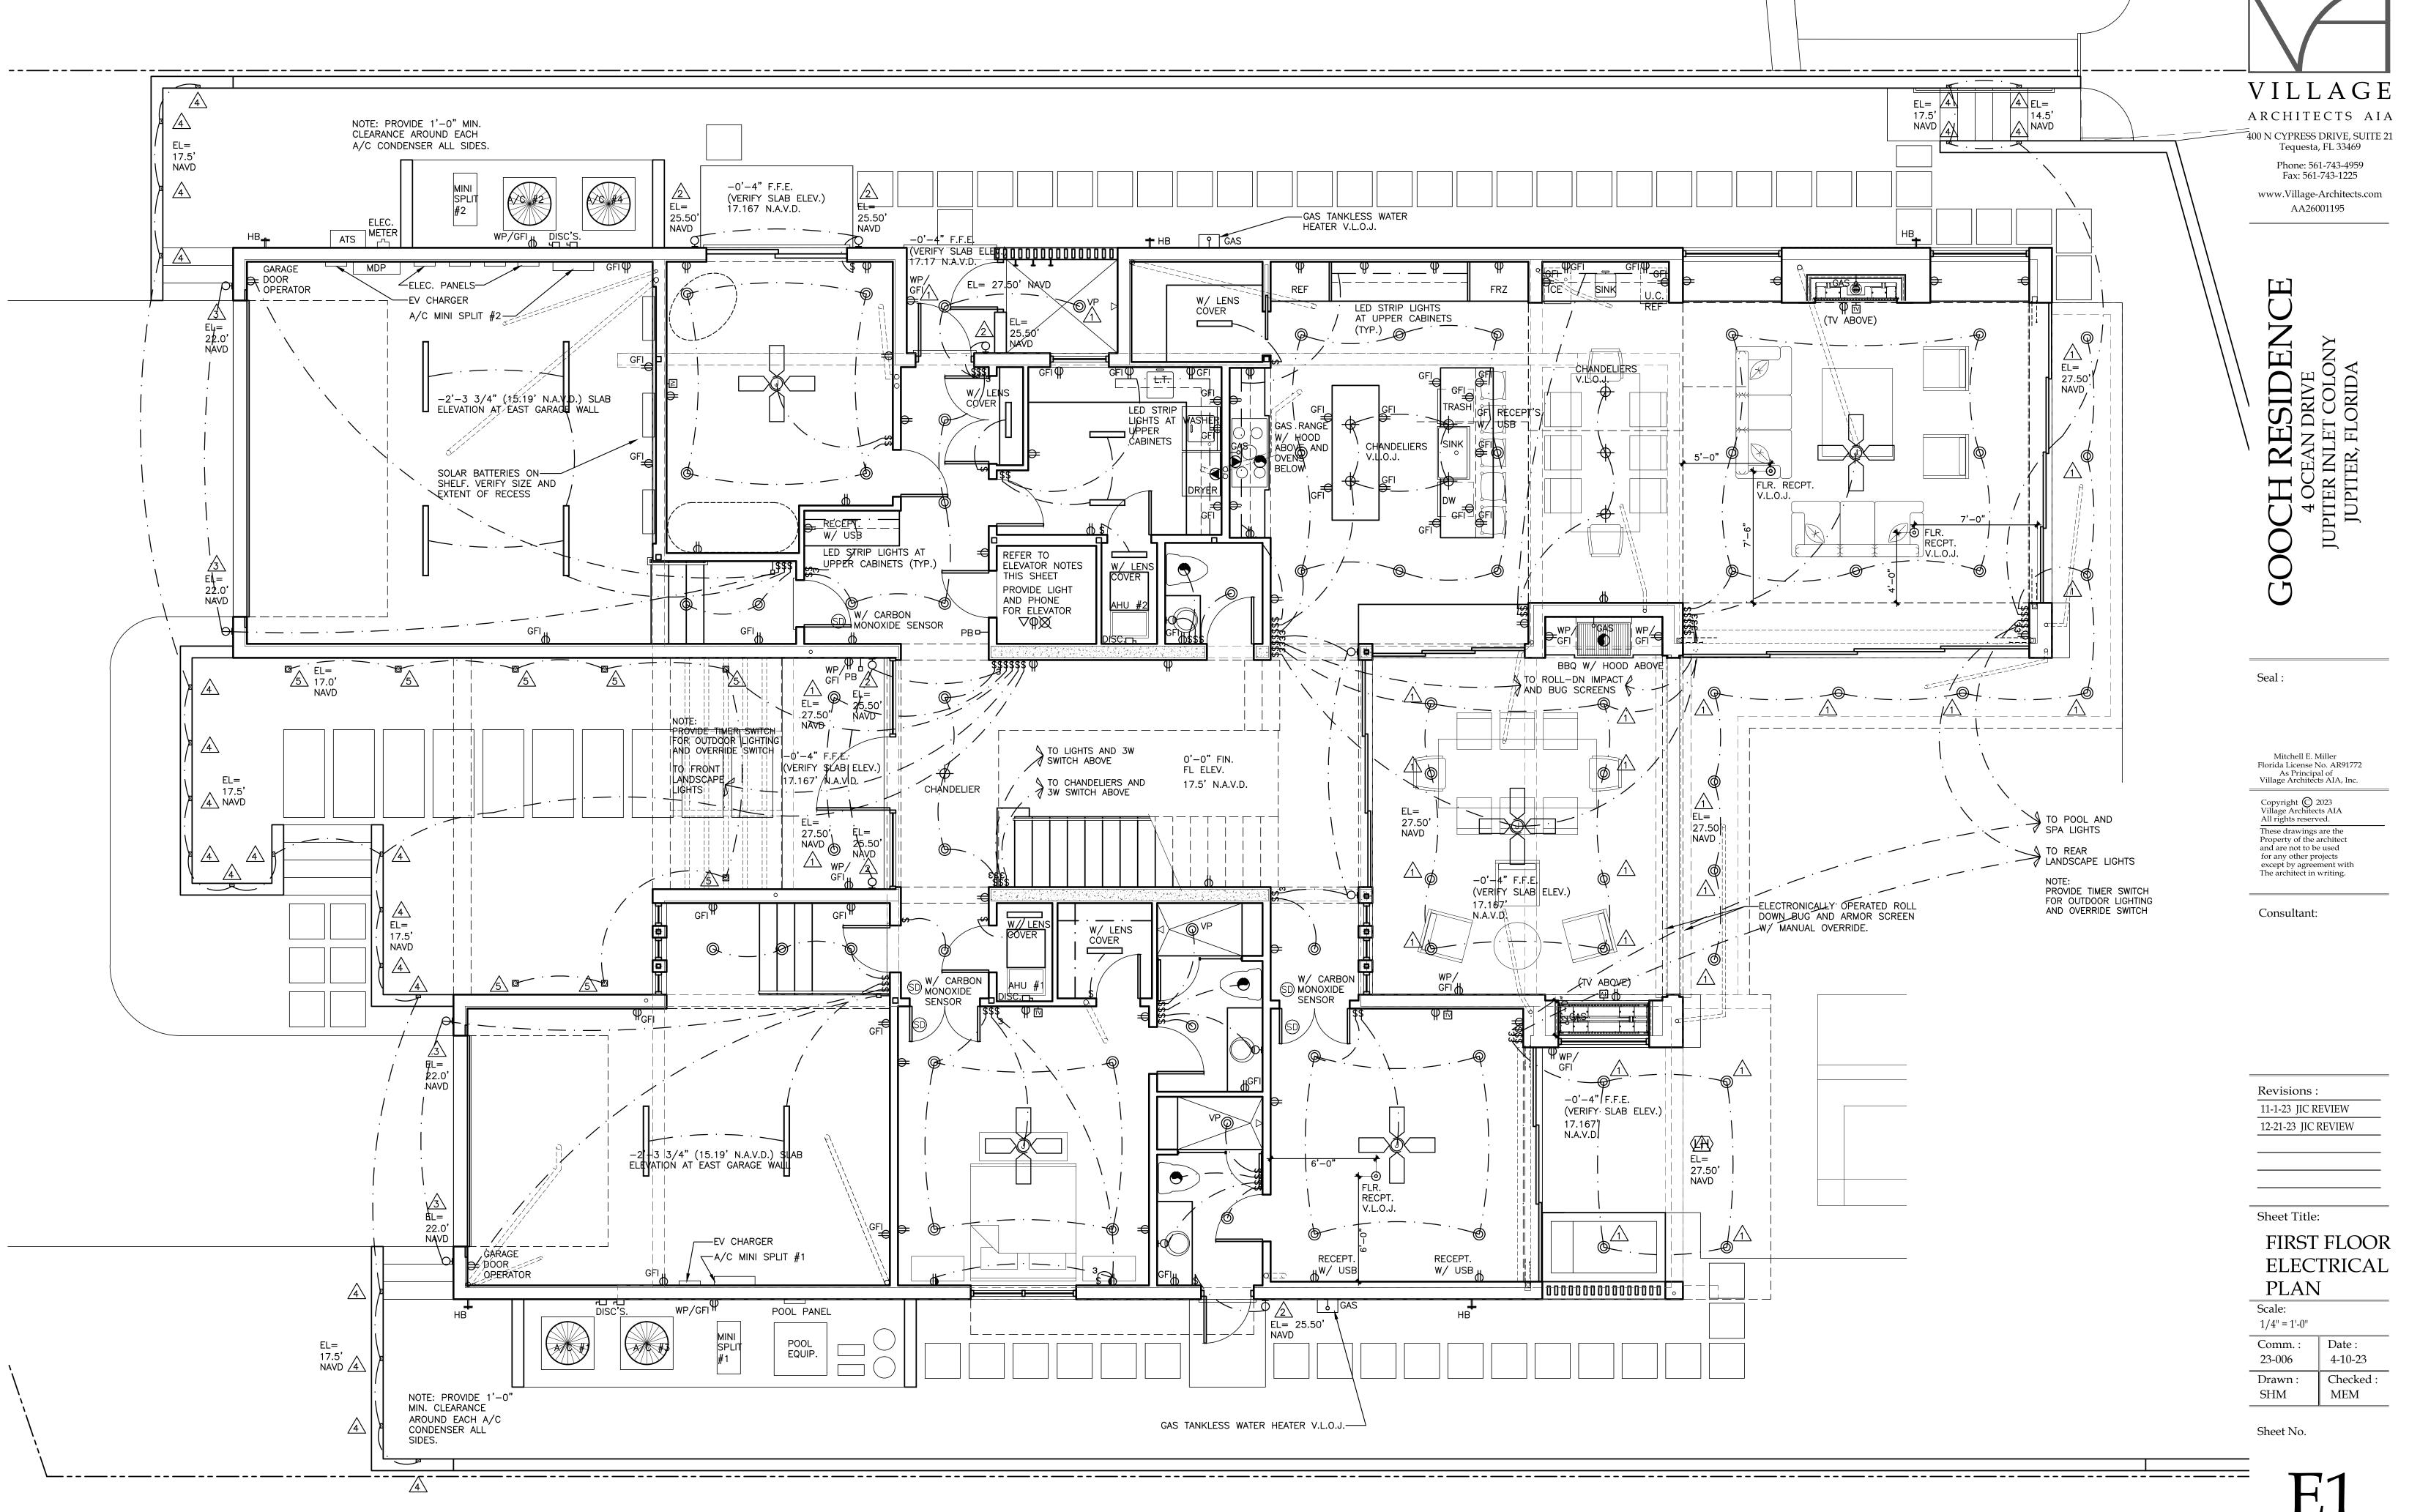
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4-10-23 Checked: MEM

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FIRST FLOOR ELECTRICAL PLAN

NO PENETRATIONS OR NOTCHES SHALL BE MADE IN ANY STRUCTURAL MEMBER INCLUDING CONCRETE BEAMS AND COLUMNS, MASONRY BLOCK AND STEEL BEAMS WITHOUT WRITTEN APPROVAL BY Print Date: 12-14-23 THE ENGINEER OF RECORD.


MANUFACTURER: BEACHSIDE LIGHTING LITON LIGHTING

NOTES: ALL WINDOWS AND DOORS TO HAVE TURTLE TINTED GLASS (45% MAX LIGHT TRANSMITTANCE).

EXTERIOR LIGHT SCHEDULE									
SYMBOL	FIXTURE MFGR	TOTAL	BULB, WATTAGE AND LAMP	TYPE OF MOUNT	MOUNT HT ABOVE FINISH GRADE				
<u>^</u>	CH410-4" COMMERCIAL DOWNLIGHT-1000LM "LITON"	30	10W AMBER (1500K)	RECESSED CEILING LT.	10'-6" A.F.G. (27.50' N.A.V.D.), 21'-4" A.F.G. (38.33' N.A.V.D.)				
2	L-014 "BEACHSIDE"	6	5W-A-NFL AMBER (1500K)	WALL MOUNT DOWN LT	8'-6" A.F.G. (25.50' N.A.V.D.)				
<u>3</u>	L-013-S "BEACHSIDE"	4	7W-A-NFL AMBER (1500K)	WALL MOUNT UP/DOWN LT	7'-1" A.F.G. (22.0' N.A.V.D.)				
4	E3-SQL "BEACHSIDE"	30	2W-A-FL AMBER (1500K)	RECESSED STEP LIGHT	(-)2'-6" A.F.G. (14.5' N.A.V.D.), 0'-6" A.F.G. (17.50' N.A.V.D.), 13'-2" A.F.G. (30.17' N.A.V.D.)				
<u></u>	E3-SQ "BEACHSIDE"	8	2W-A-NFL AMBER (1500K)	IN GRADE UP LIGHT	0'-0" A.F.G. (17.0' N.A.V.D.)				



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GOOCH RESIDENCE
4 OCEAN DRIVE
JUPITER INLET COLONY
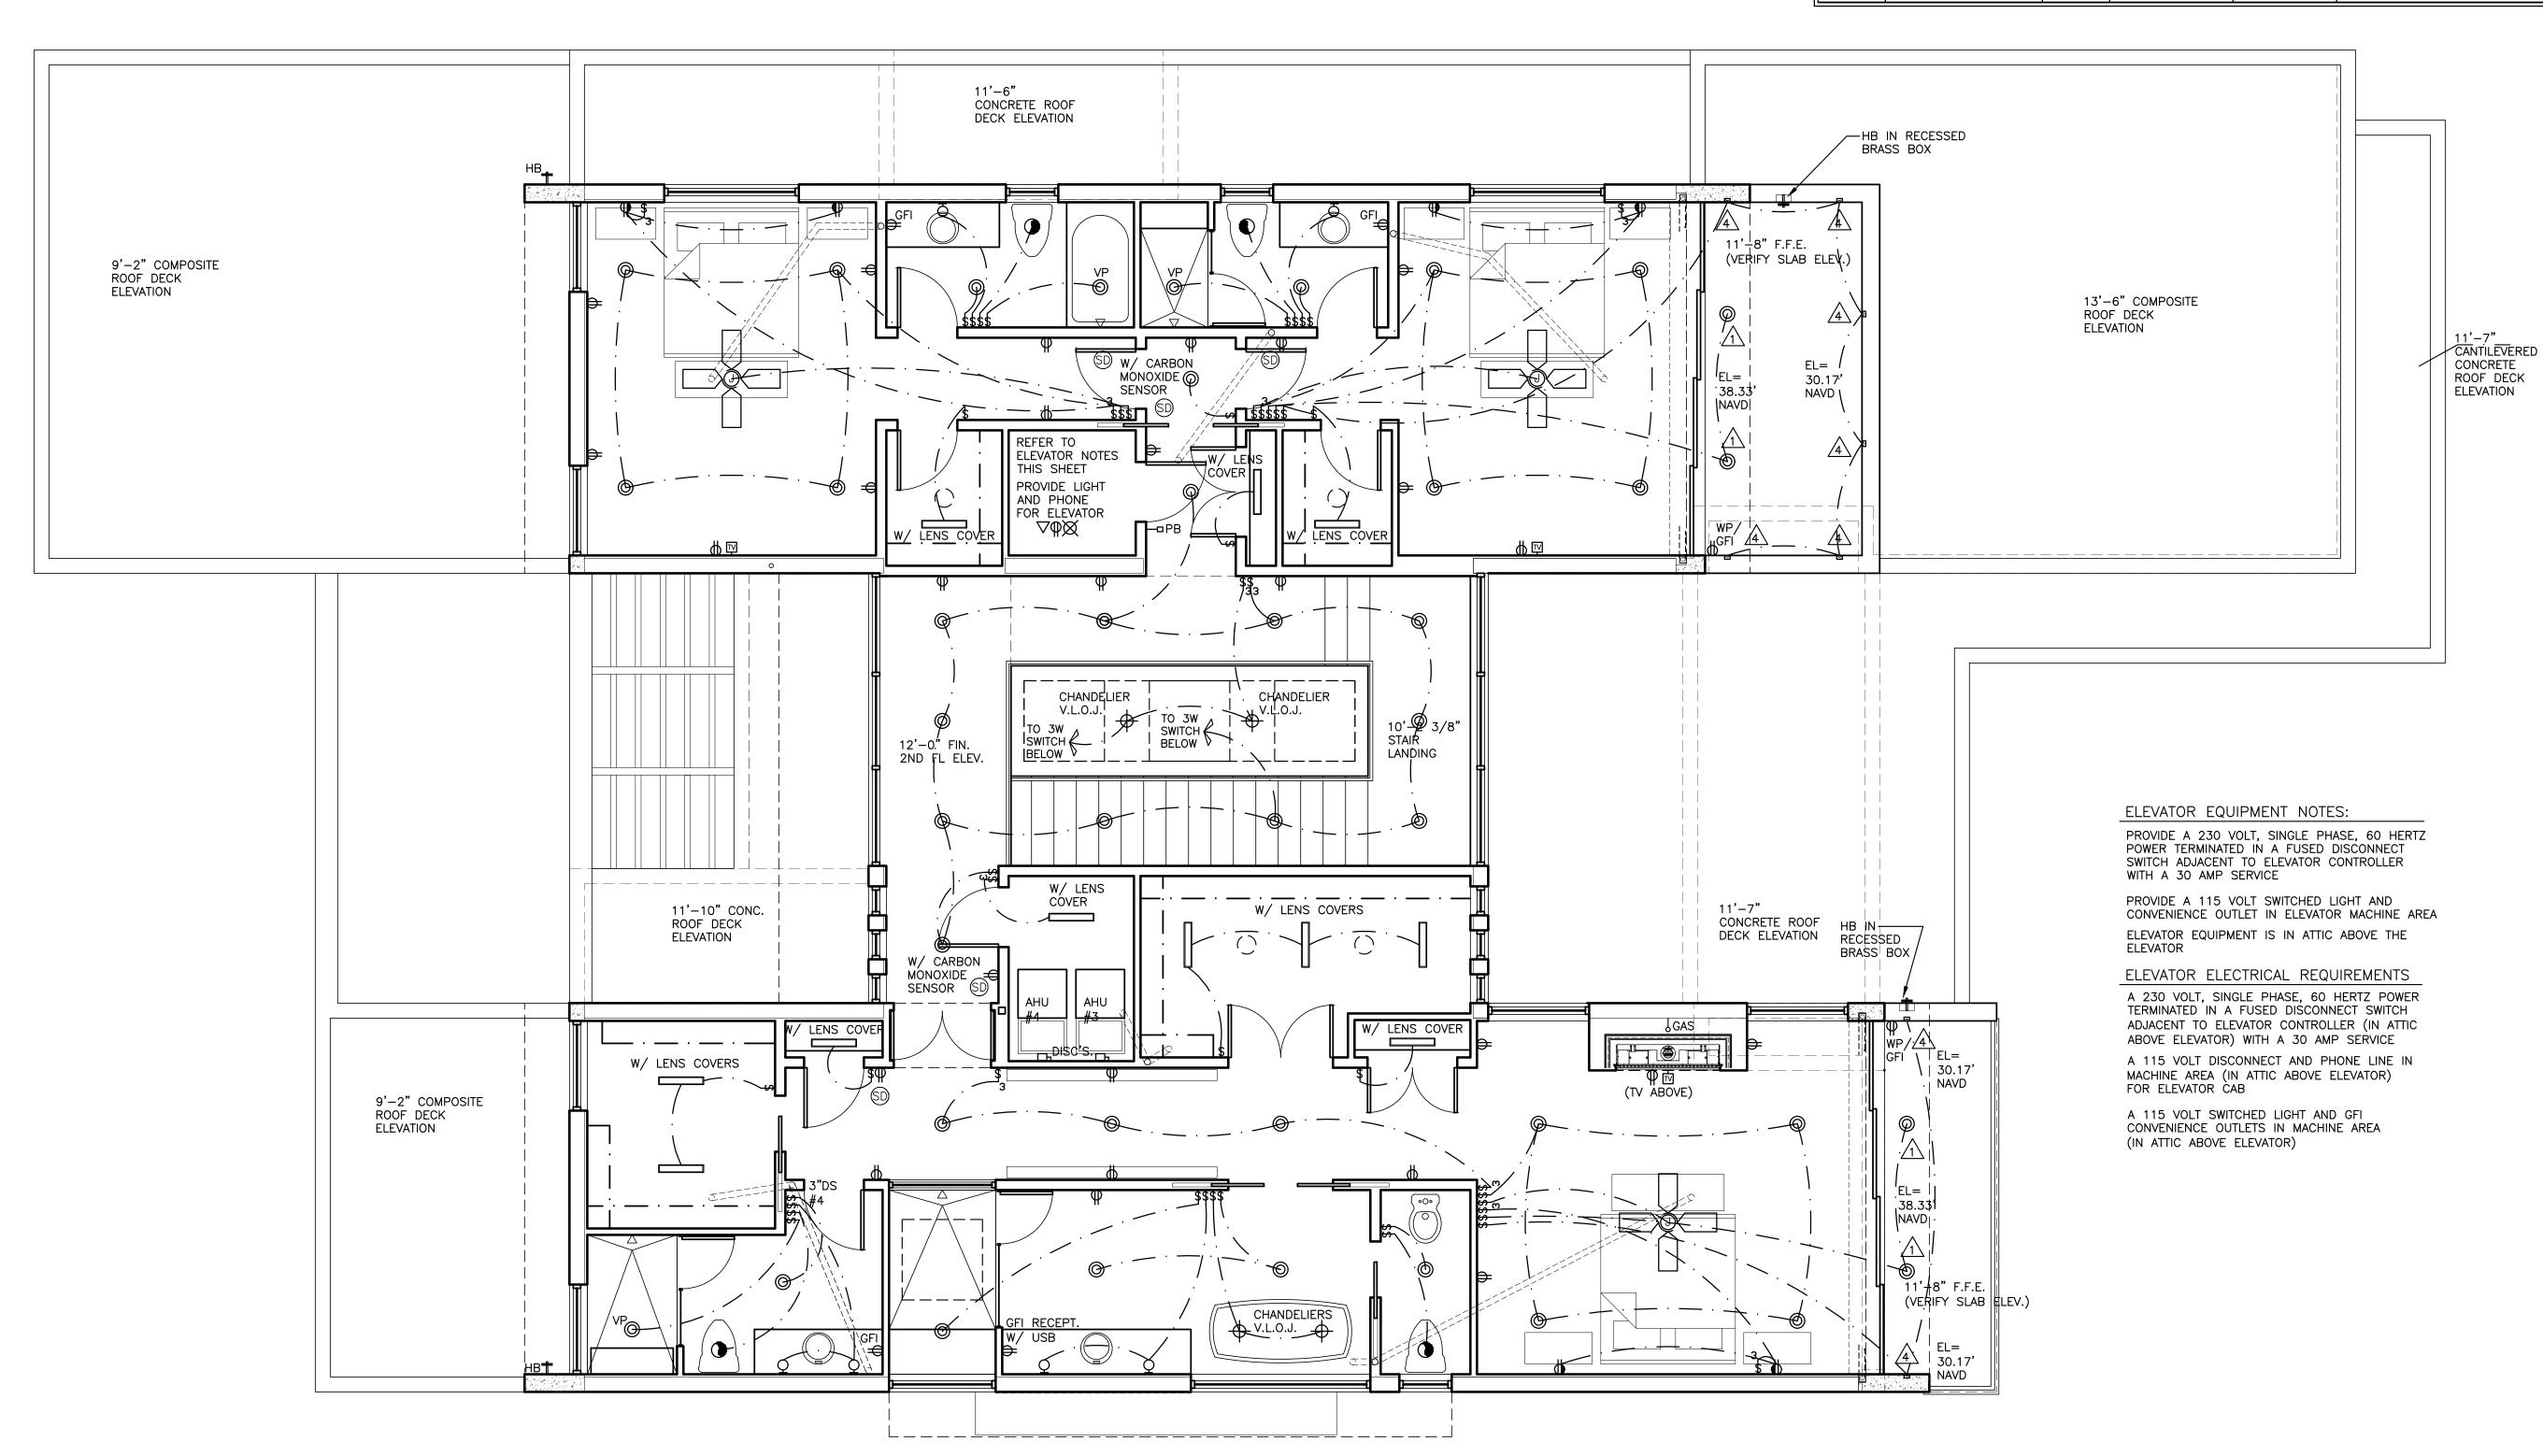
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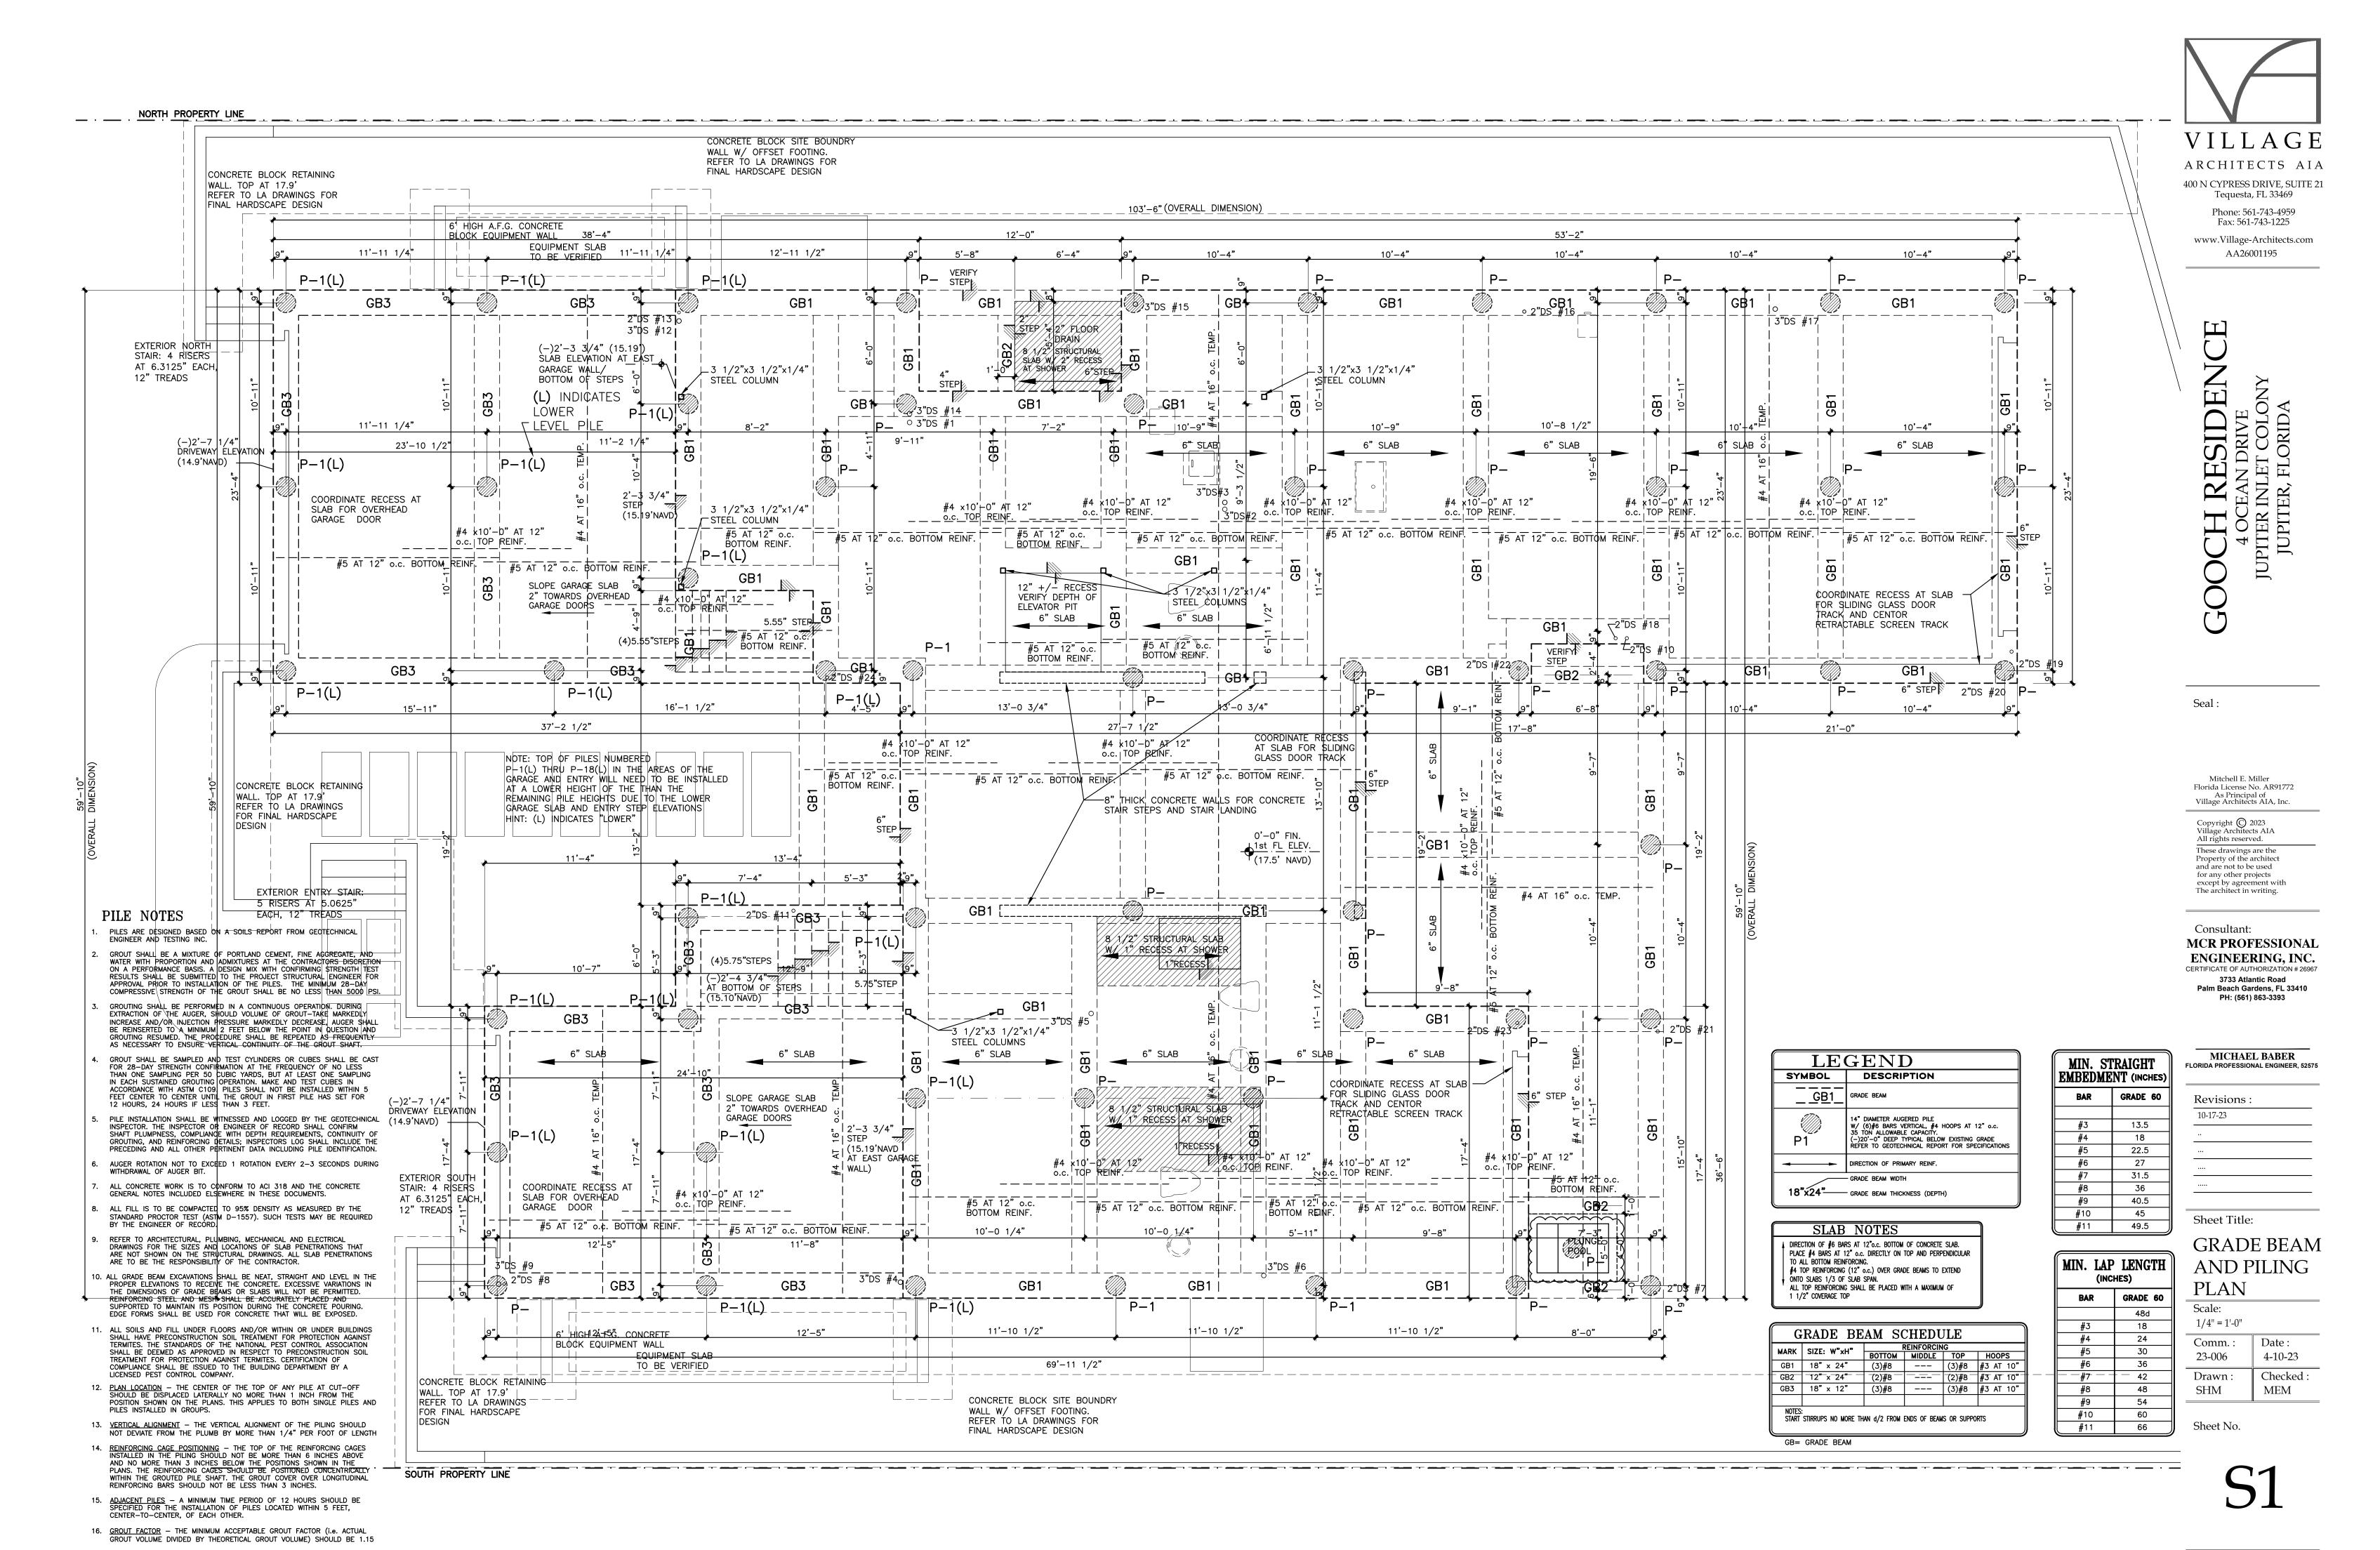
SECOND FLR ELECTRICAL PLAN

Scale: 1/4" = 1'-0"

Comm. : 23-006	Date : 4-10-23
Drawn :	Checked
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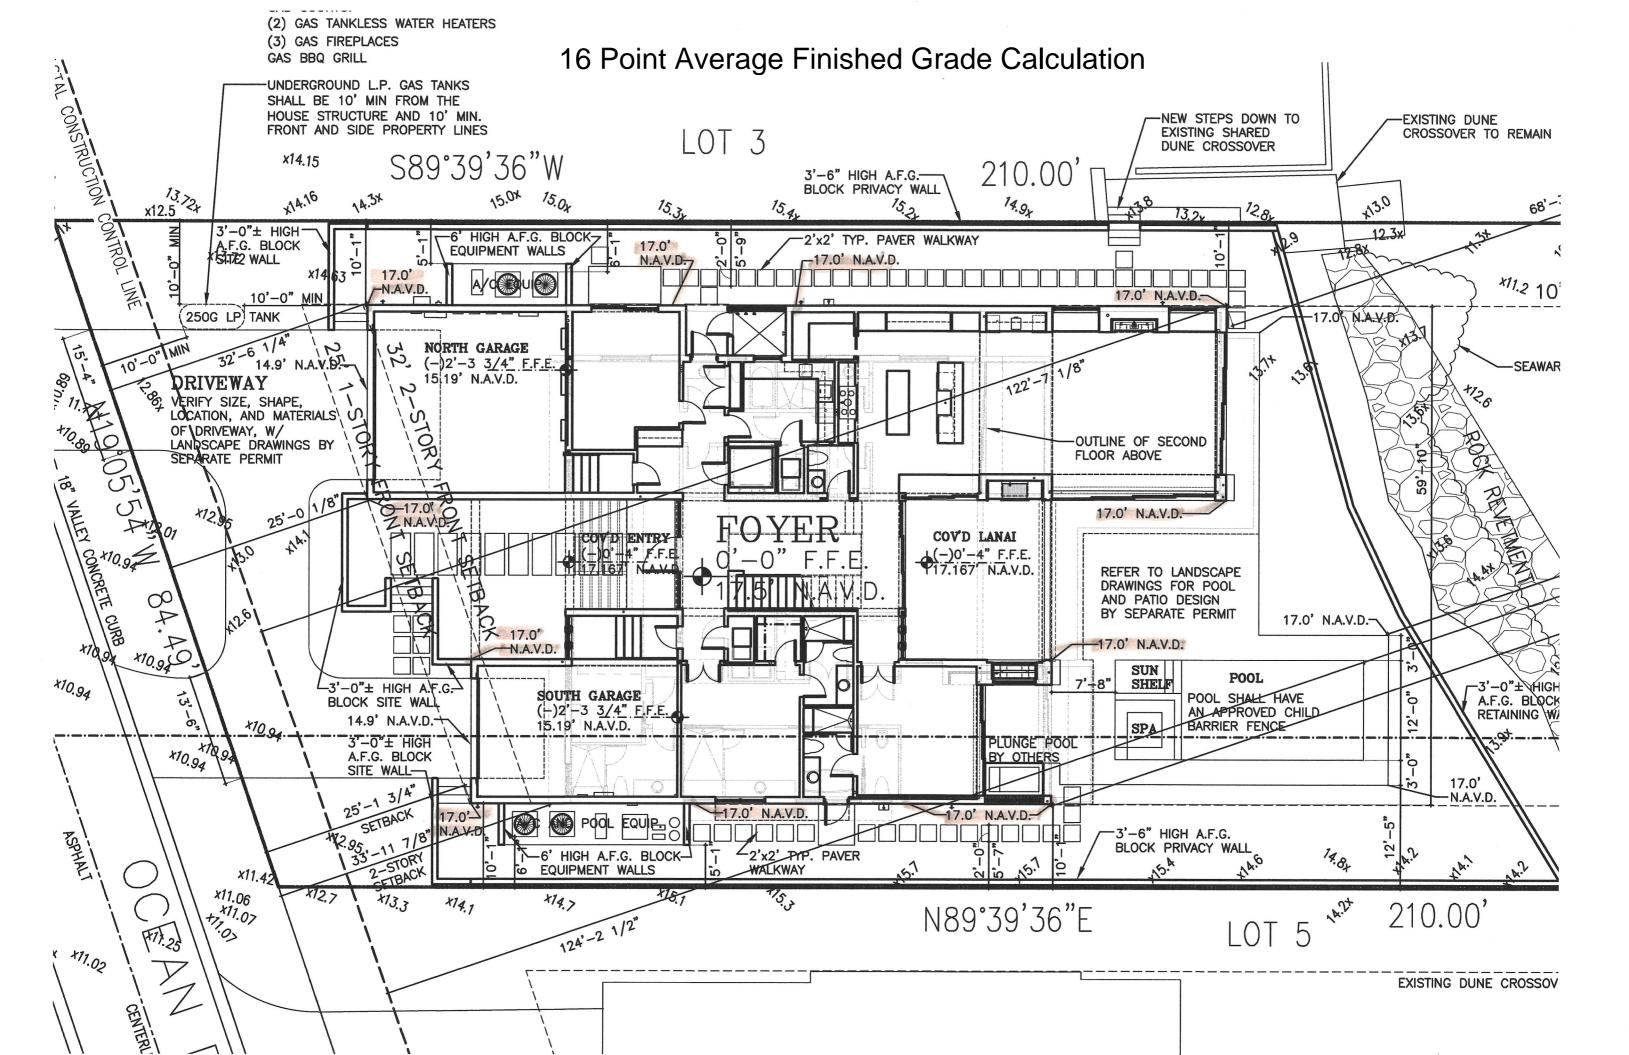
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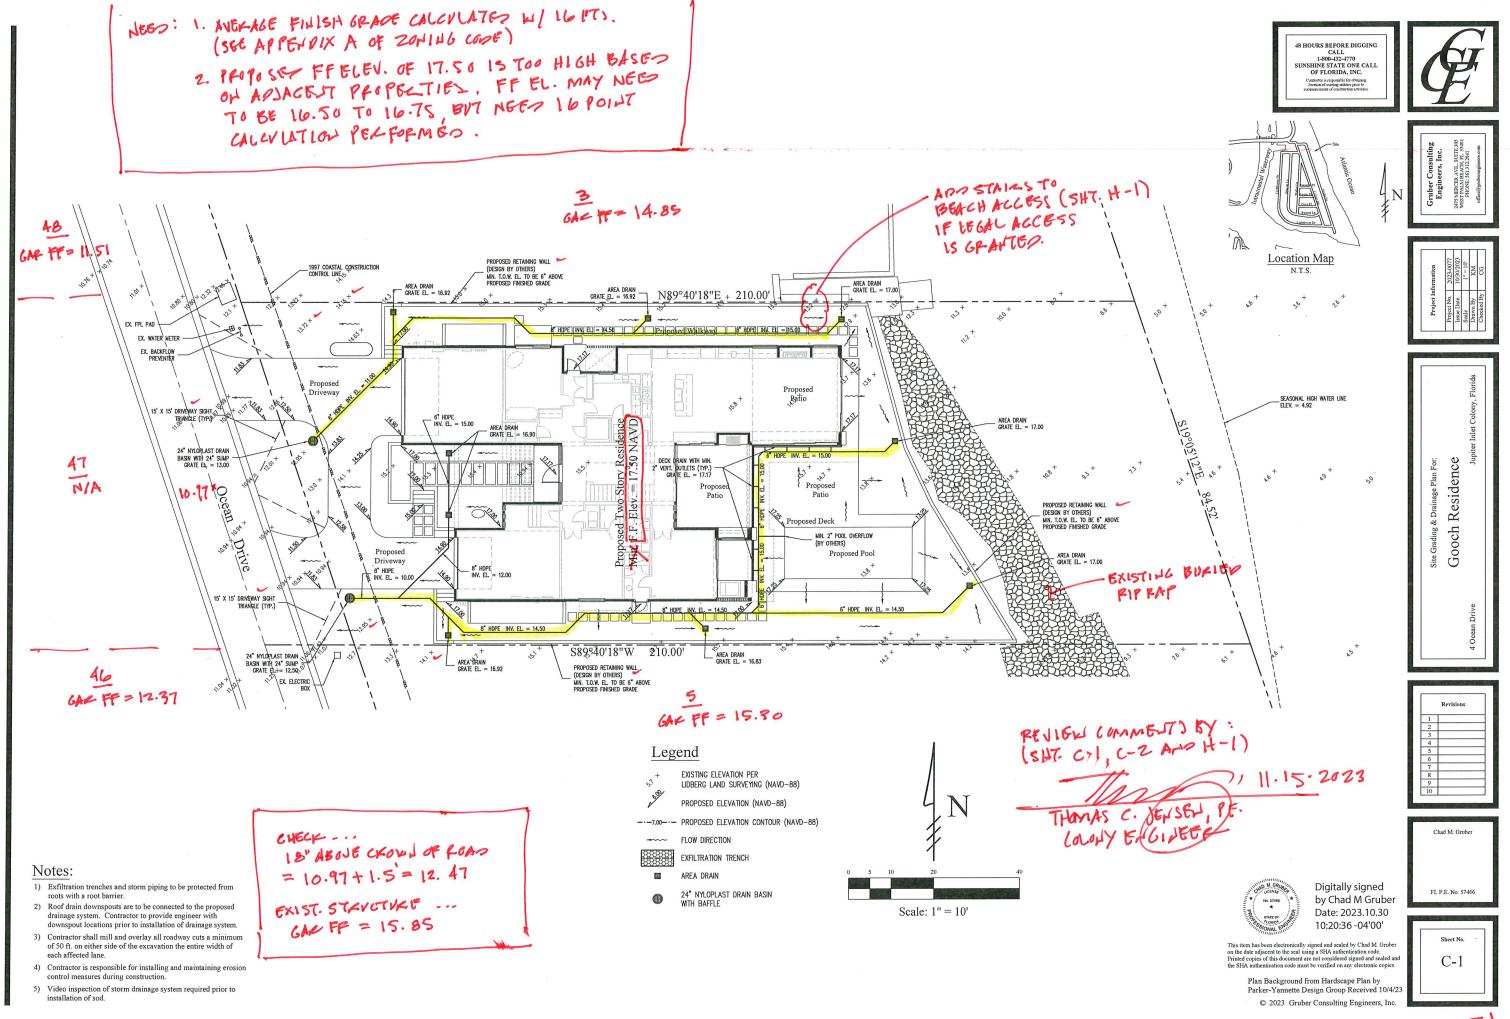
 E_2




NOT FOR CONSTRUCTION

Print Date: -





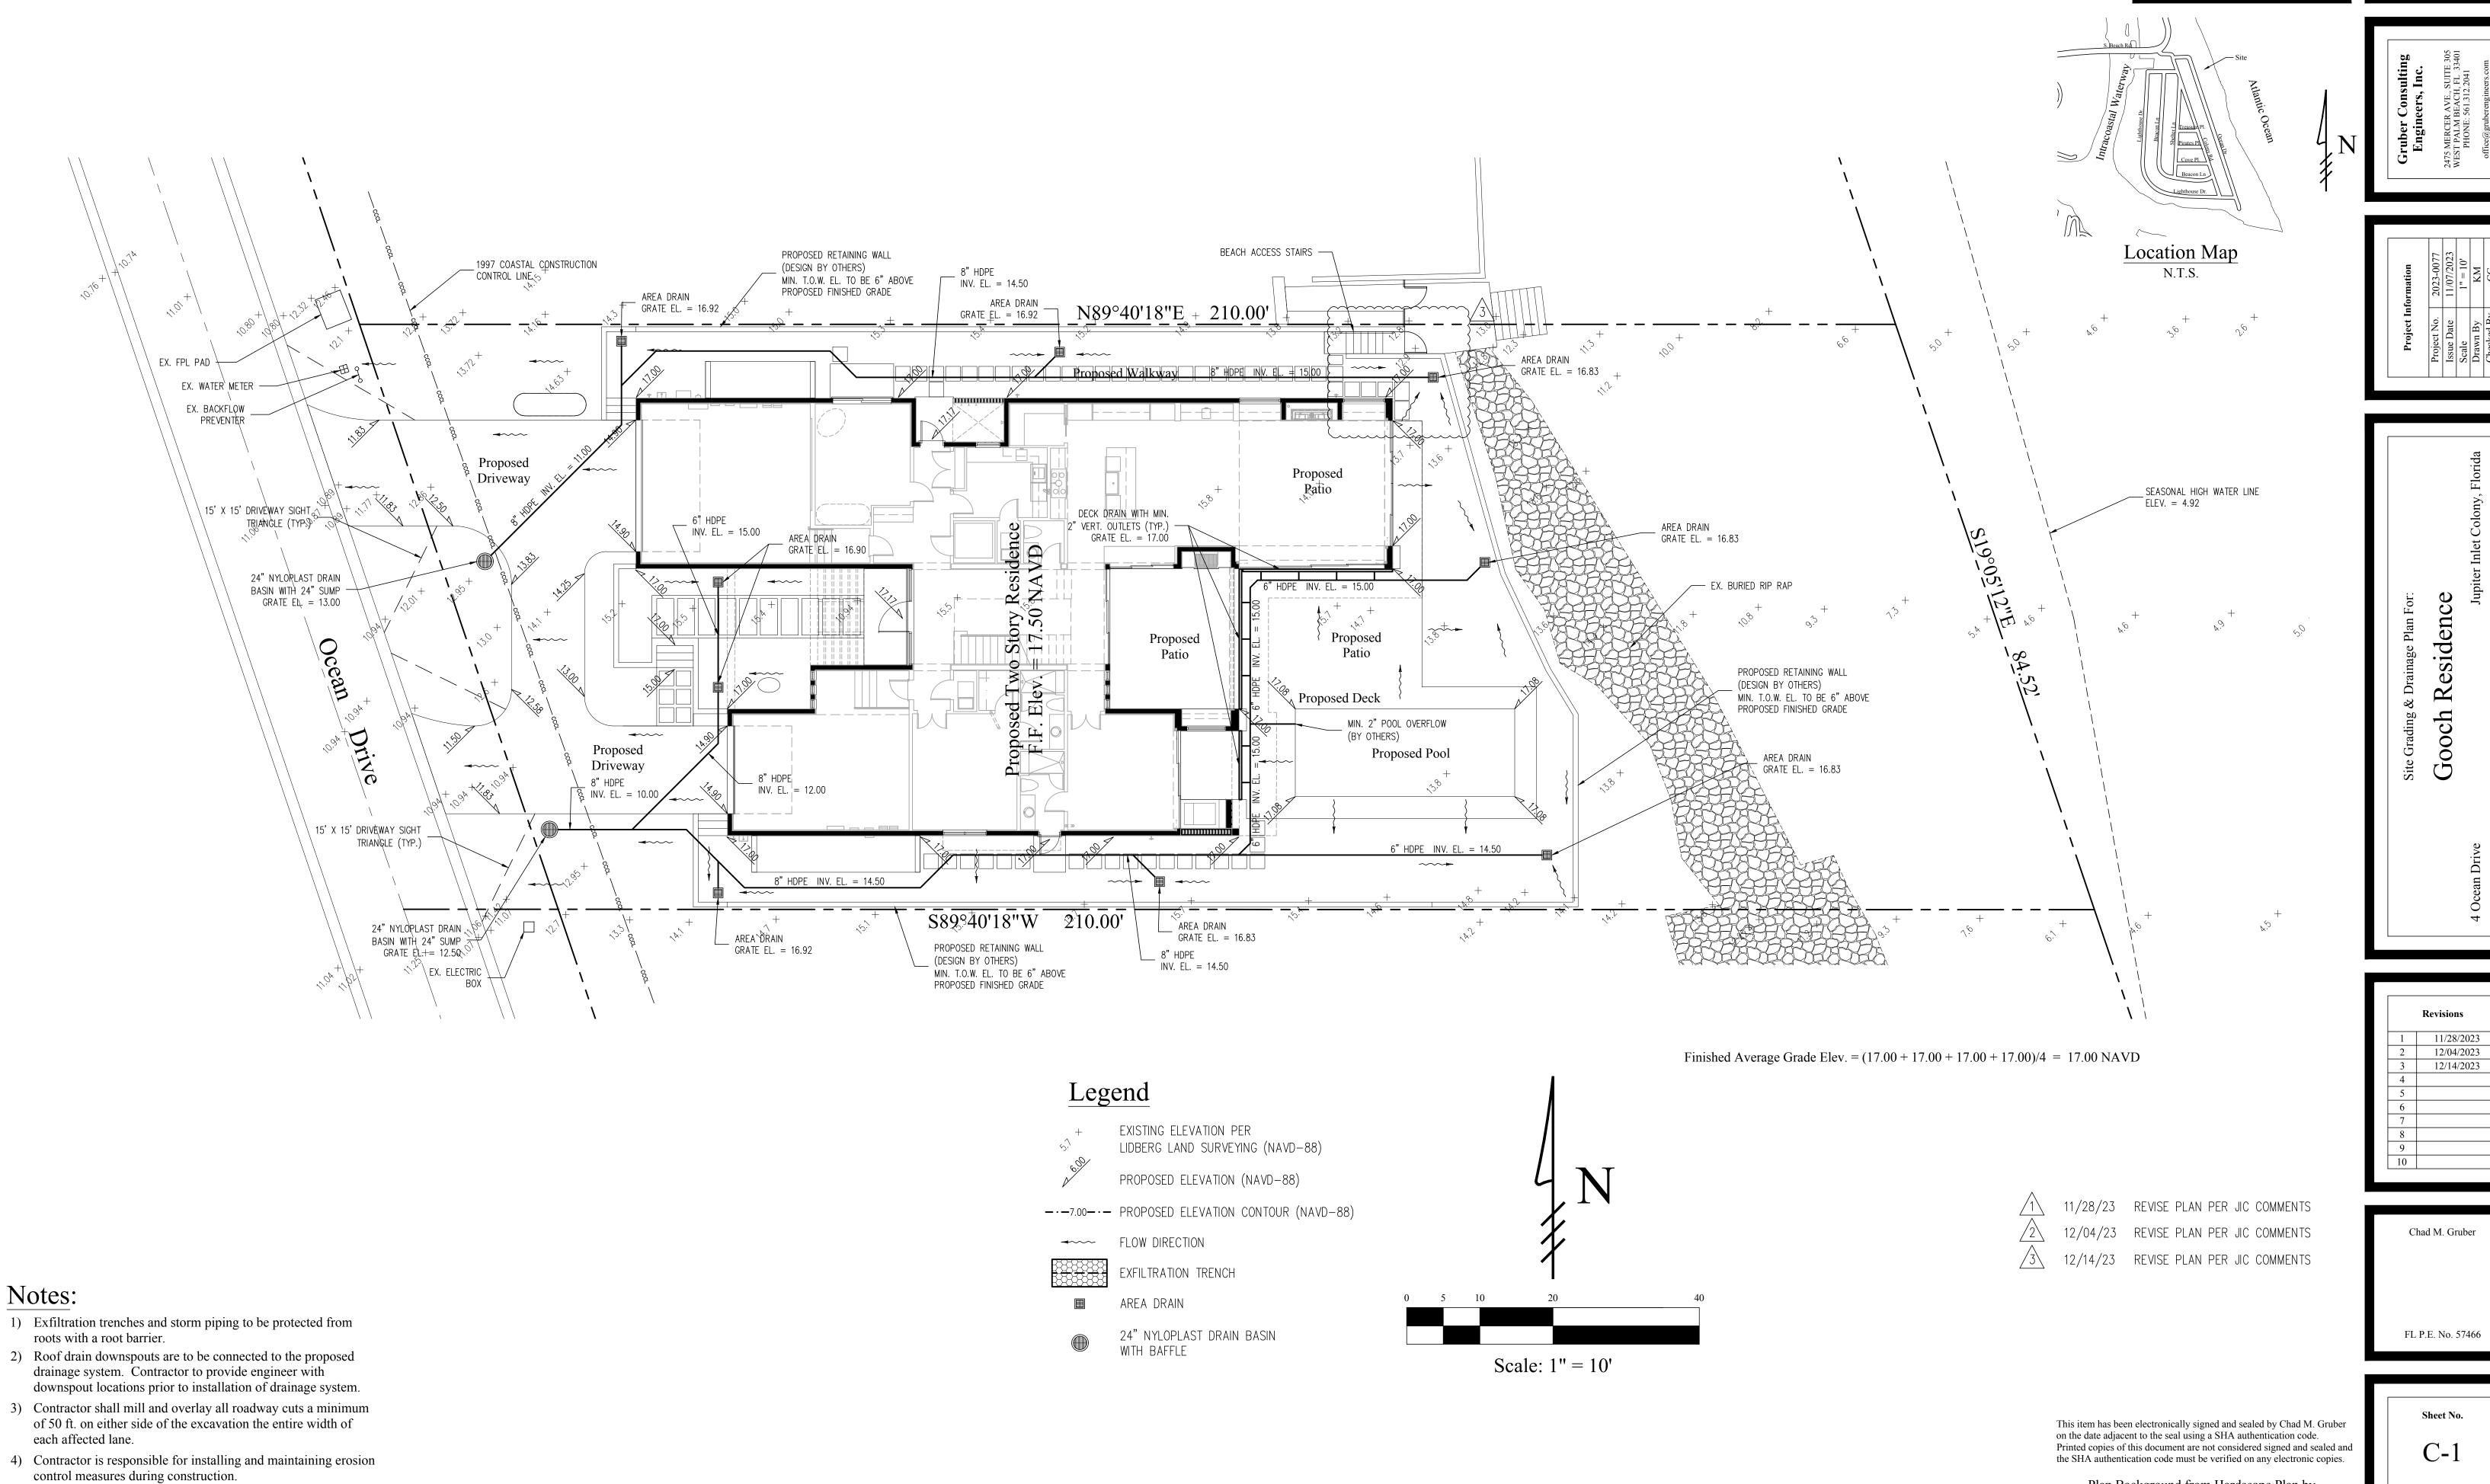


5) Video inspection of storm drainage system required prior to

installation of sod.

48 HOURS BEFORE DIGGING CALL 1-800-432-4770 SUNSHINE STATE ONE CALL OF FLORIDA, INC. Contractor is responsible for obtaining location of existing utilities prior to commencement of construction activities

Plan Background from Hardscape Plan by Parker-Yannette Design Group Received 12/14/23 © 2023 Gruber Consulting Engineers, Inc.

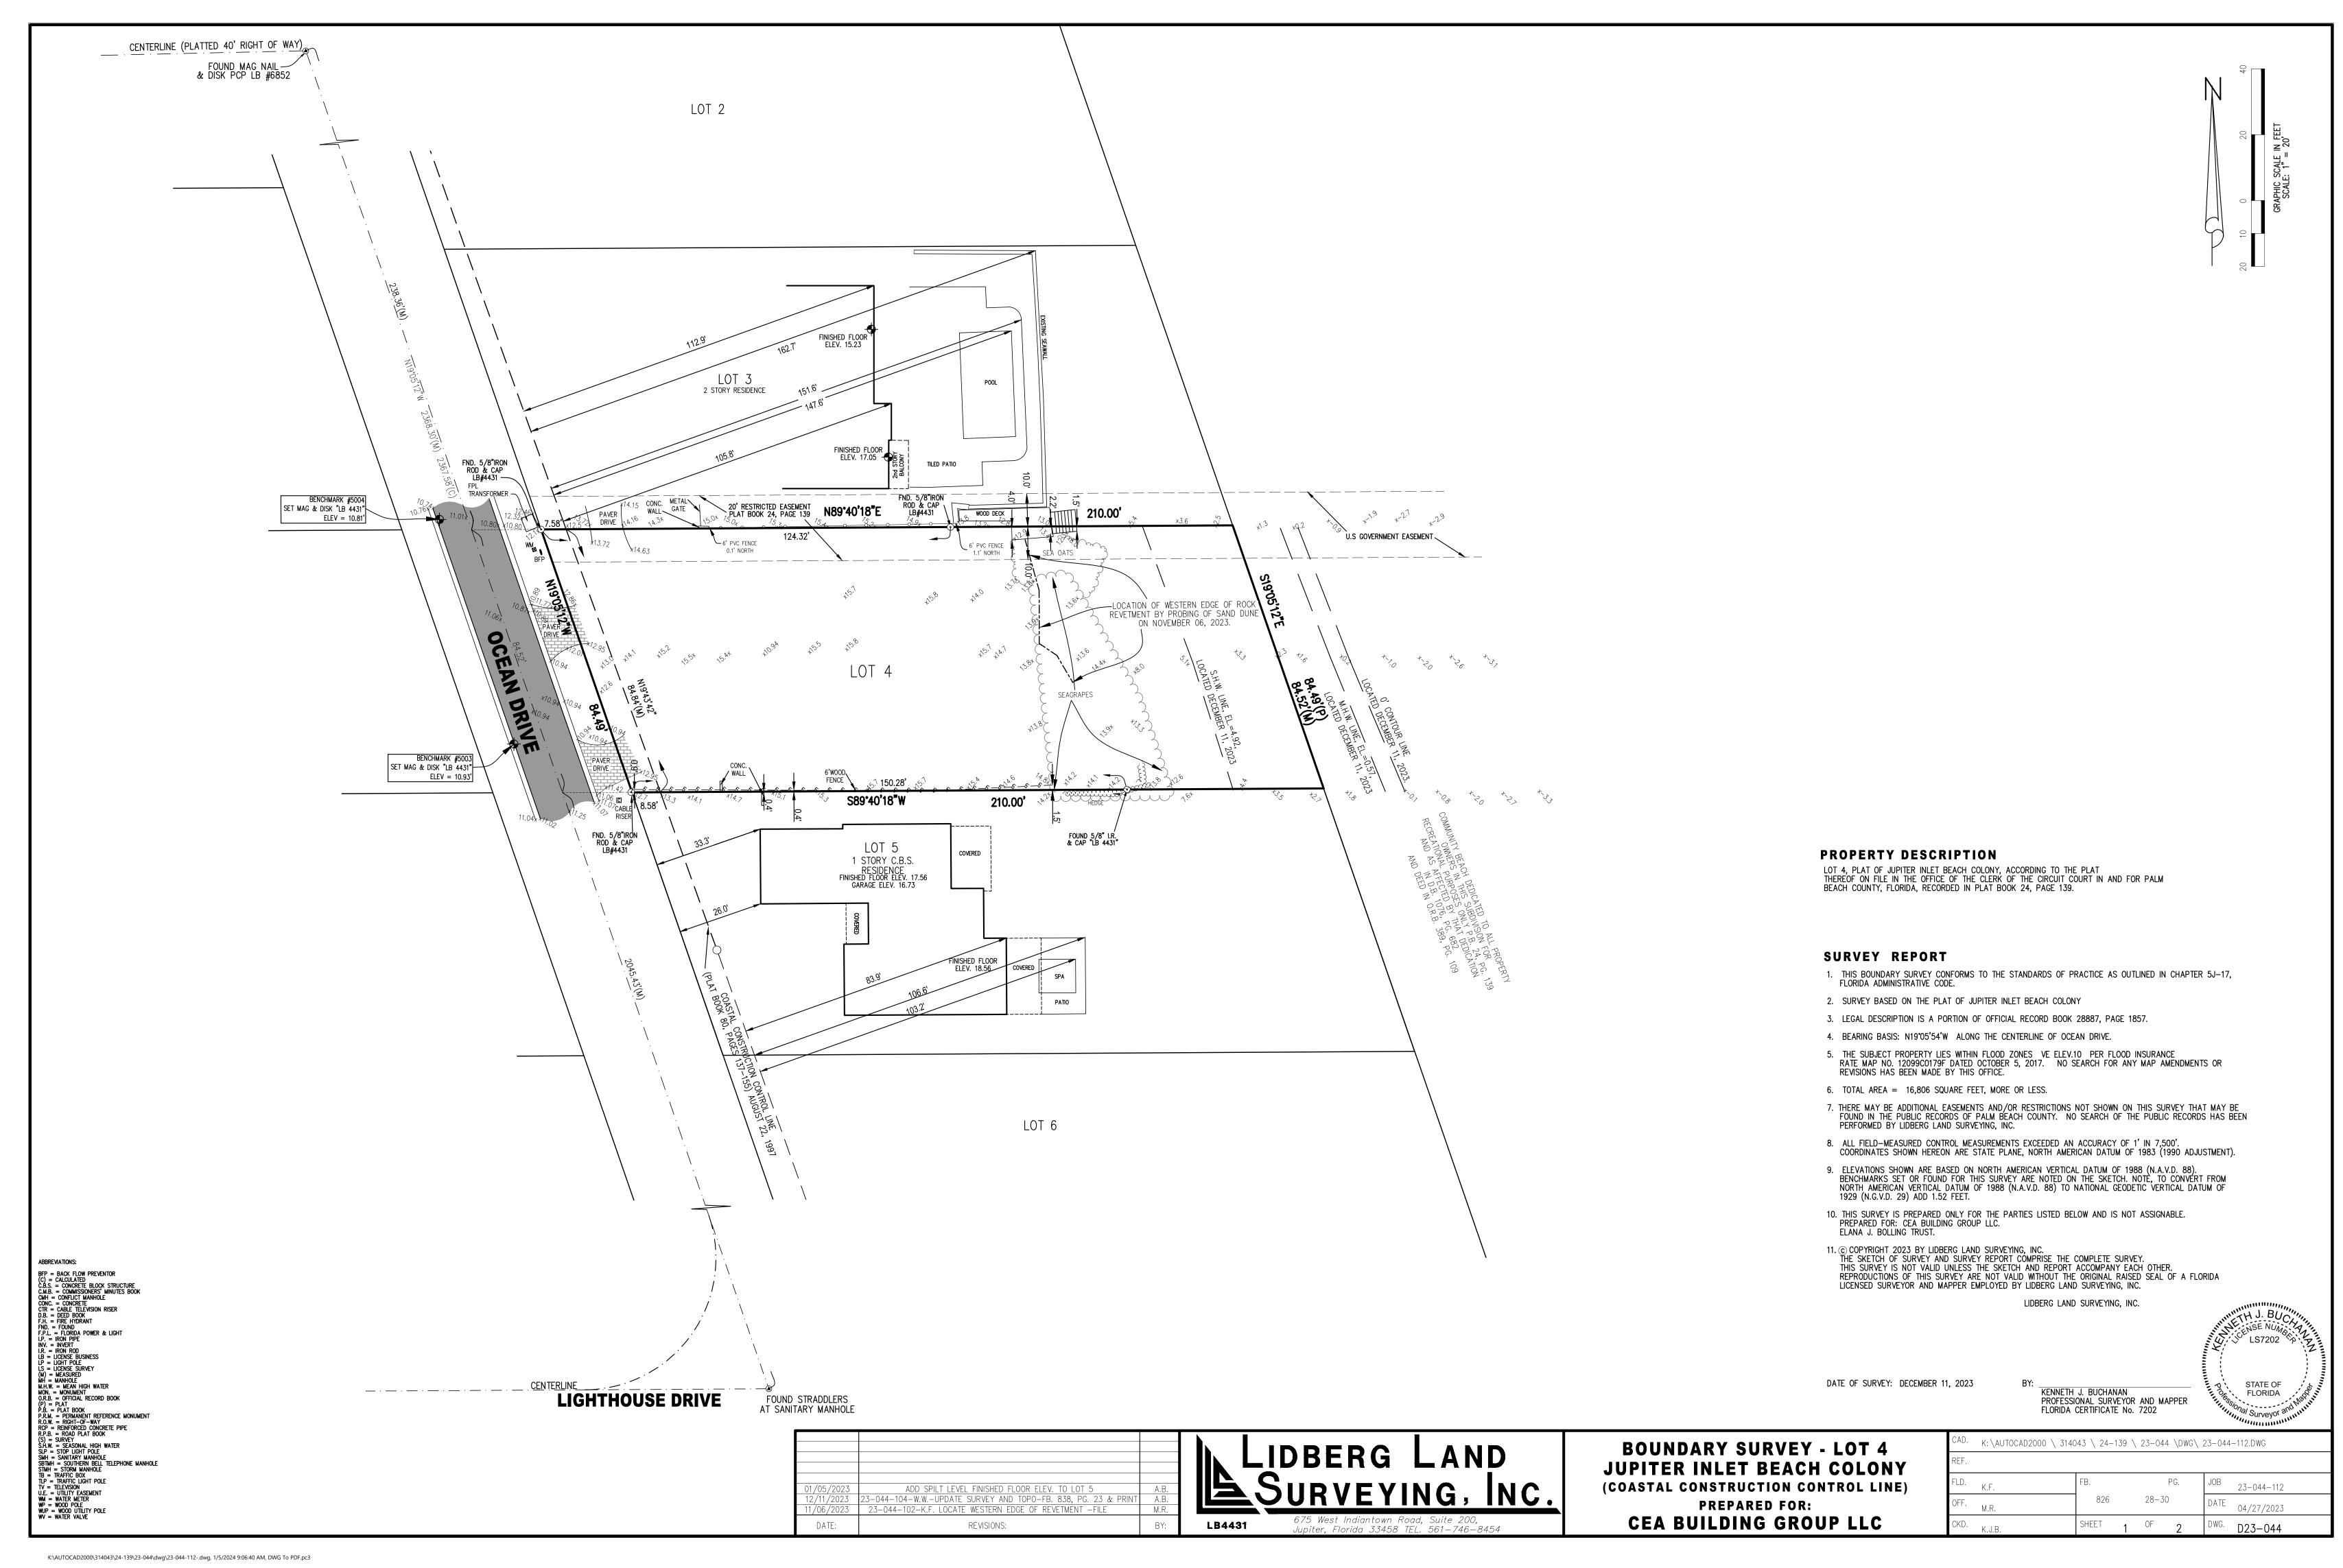

From: Chuck Yannette
To: Bill Whiteford

Cc: "Mitch Miller"; "Sam Miller"; "Michael Armato"; "Matthew Percy"; Chad M. Gruber, P.E.

Subject: 4 Ocean Drive - Gooch Residence

Date: Wednesday, November 15, 2023 3:38:36 PM

Attachments: Gooch 10-00 CS-1.pdf

Gooch 10-01 H-1.pdf Gooch 10-02 L-1.pdf Gooch 10-03 L-2.pdf

Bill – Mitch Miller and I have been working with Roger Siboni to address concerns regarding ocean views from his property looking northeast across the Gooch property. I've attached a revised hardscape/landscape plan set reflecting improvements which include the following:

- The 6' high wall along the south property line was revised to remove approximately 15' from the eastern end.
- The retaining wall on the east side of the site was shifted westward at the southeast corner to align with the new end of south wall.
- The easternmost 20' of the south wall is lowered so the top is at elevation 17.0'. This makes the wall about 3' high from the neighbor's grade.
- One proposed Coconut palm was removed from the southeast corner of the site.

On the north property line, we also lowered the top of the 6' height wall to elevation 17.0' at the easternmost end (from the steps accessing the dune crossover to the eastern end of the wall, approx. 16.5' length).


We believe these improvements will help maintain ocean views for adjacent neighbors. Please let me know if you have any questions.

Thank you,

Chuck Yannette, PLA



Please visit us on the web: http://www.pydg.com

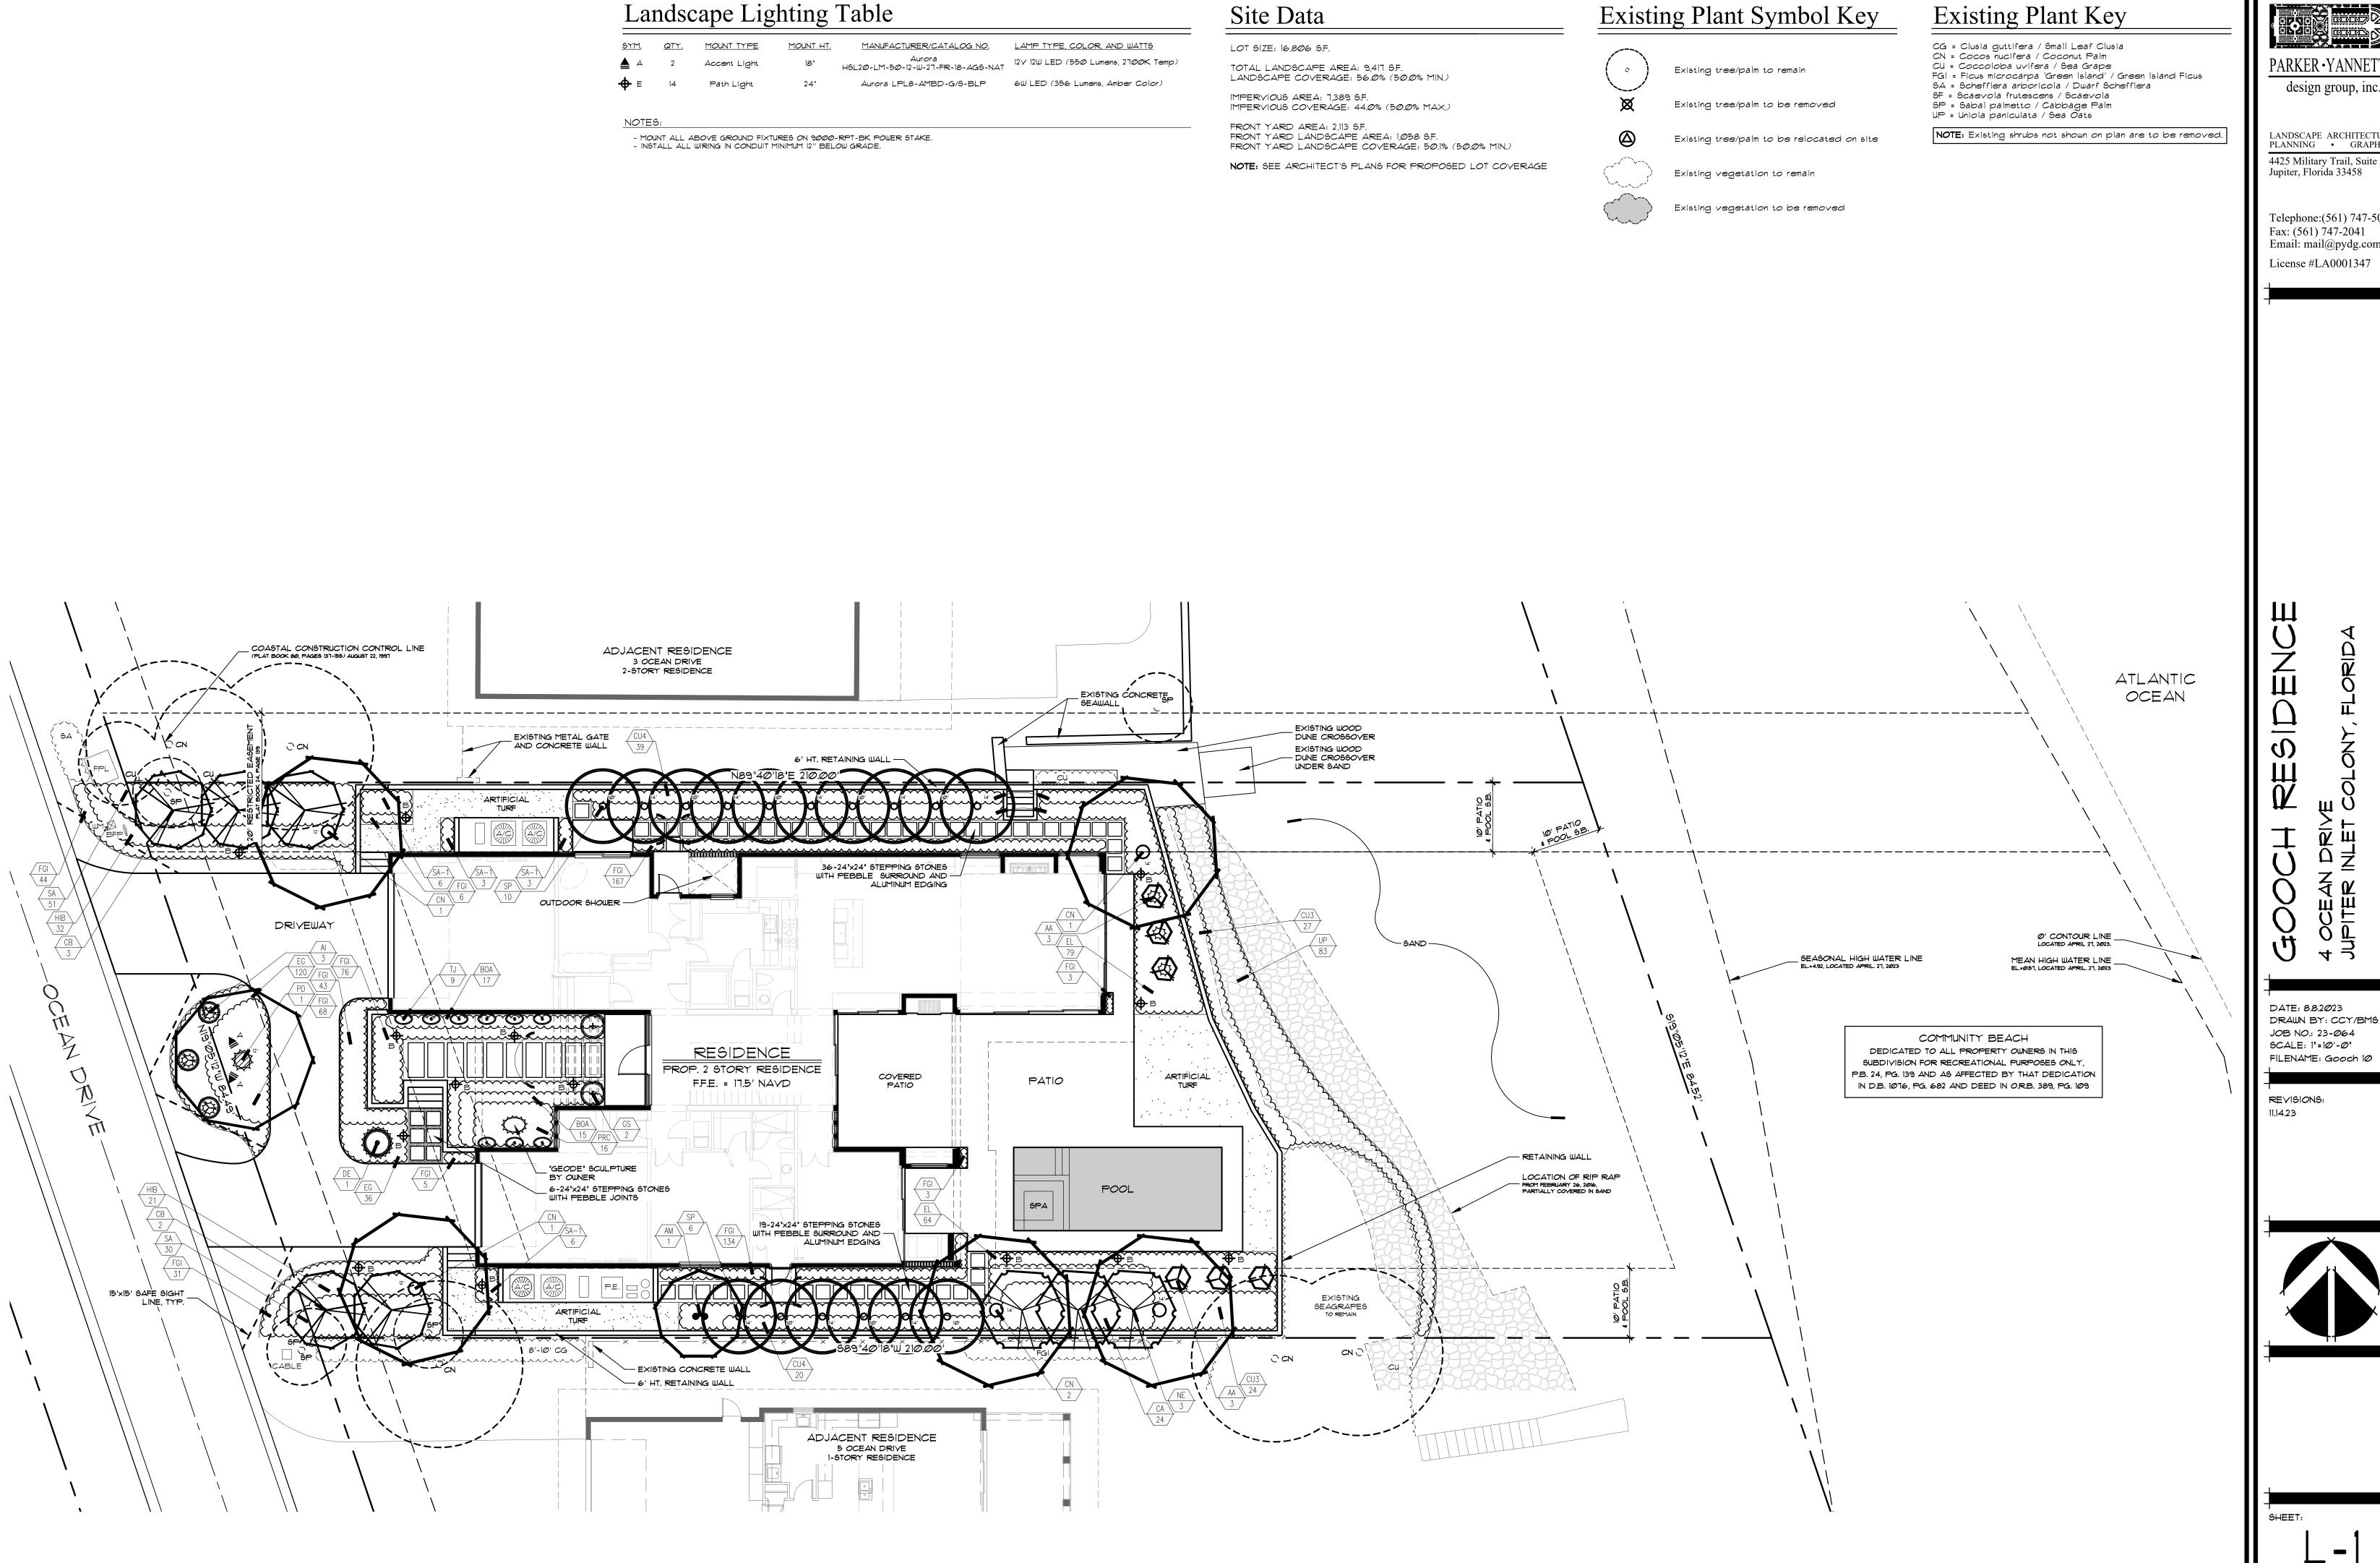

Existing Plant Key

PARKER • YANNETT

design group, inc.

LANDSCAPE ARCHITECTURE PLANNING • GRAPHICS 4425 Military Trail, Suite 202 Jupiter, Florida 33458

Telephone:(561) 747-5069 Fax: (561) 747-2041 Email: mail@pydg.com License #LA0001347

SCALE: 1"=10'-0" FILENAME: Gooch 10



Plant Specifications

SPECIES AND SIZE shall conform to those indicated on the drawings. Nomenclature shall conform to STANDARDIZED PLANT NAMES, current edition. All nursery stock shall be in accordance with Grades and Standards for Nursery Plants Parts | \$ ||, latest edition published by the Florida Department of Agriculture and Consumer Services. All plants not otherwise specified as being Florida Fancy or Specimen, shall be Florida Grade Number 1 or better as determined by the Florida Division of Plant Industry. Specimenans an exceptionally heavy, symmetrical, tightly knit plant, so trained or favored in its development that first appearance is unquestionable and outstandingly superior in form, number of branches, compactness and symmetry.

GENERAL REQUIREMENTS

All plants shall be freshly dug, sound, healthy, vigorous, well branched, and free of disease and insect eggs and larvae, and shall have adequate root systems. Trees for planting rows shall be uniform in size and shape. All materials shall be subject to approval by the Landscape Architect. Where any requirements are omitted from the plant list, the plants furnished shall be normal for the variety. Plants shall be pruned prior to delivery only upon the approval of the Landscape Architect. CONTAINER GROWN STOCK

All container grown material shall be healthy, vigorous, well rooted plants, and established in the container in which they are sold. The plants shall have tops which are good quality and in a healthy growing condition. An established container grown plant shall be grown in that container sufficiently long enough for the new fibrous roots to have developed so that the root mass will retain its shape and hold together when removed from the container. Flant root bound in containers are unacceptable.

MEASUREMENTS

Height shall be measured from ground to the average height of canopy. Spread shall be measured to the end of branching equally around the crown from the center of the trunk Measurements are not to include any terminal growth. Single trunk trees shall be free of "V" crotches that could be points of weak limb structure or disease infestation.

Heights shall be measured from the ground to the average points where mature plant growth stops. Spread shall be measured to the end of branching equally around the shrub mass. Measurements are not to include any terminal growth.

Clear Trunk (C.T.), shall be measured from the ground at the time of installation to the point where the mature aged trunk joins the immature or green portion of the trunk or the head.

> Overall height (O.H.), shall be measured from the ground at the time of installation to a point three quarters the length of the unopened bud. Palms with marred or burned trunks will not be accepted.

Planting soil for use in preparing backfill for plant pits shall be added at a rate of seventy-five (75%) percent to twenty-five (25%) percent existing soil. This soil mix shall be used in all plant pits except Sabal palms which shall be backfilled with clean sand. Planting soil shall be a fertile, friable natural topsoil or loamy character. It shall contain forty (40) to fifty (50) percent decomposed organic matter and shall be free from heavy clay, stones, lime, plants, roots or other foreign materials or noxious grasses (such as Bermuda or nut grass) and noxious weeds. It shall not contain toxic substances which may be harmful to plant

COMMERCIAL FERTILIZER

Two fertilizer shall be used in all types of plantings, except palms. Granular fertilizer shall be uniform in composition, dry and free flowing. This fertilizer shall be delivered to the site in the original unopened bags, each bearing the Manufacturer's statement of analysis, and shall meet the following requirements: sixteen (16%) percent nitrogen, seven (7%) percent phosphorus, twelve (12%) percent potassium, plus iron. Tablet fertilizer ("Agriform" or equal) in 21 gram size shall meet the following requirements: twenty (20%) percent nitrogen, ten (10%) percent phosphorous, five (5%) percent potassium.

The two fertilizers will be applied at the following rates:

PLANT SIZE	16-7-12	"AGRIFORM" TABLET (21 Grams)
1 gal.	1/4 lb.	1
3 gal.	1/3 lb.	2
7-15 gal.	1/2 lb.	4
1"-6" caliper	2 lbs./1" caliper	2/1" caliper
6" and larger	3 lbs./1" caliper	2/1" caliper

"Florida East Coast Palm Special" will be applied to all palms at installation at a rate of 1/2 lb. per inch of trunk caliper unless otherwise specified.


MULCH

Mulch material shall be three (3) inches of shredded melaleuca mulch (sterilized and free of seeds) or approved equal, moistened at the time of application to prevent wind displacement.

SUBSTITUTIONS


No substitutions of plant material types or size will be allowed without written consent of the Landscape Architect. B&B material will not be accepted as substitute for container grown material unless previously approved. Alternate substitutions shall be indicated in bid.

Planting Details

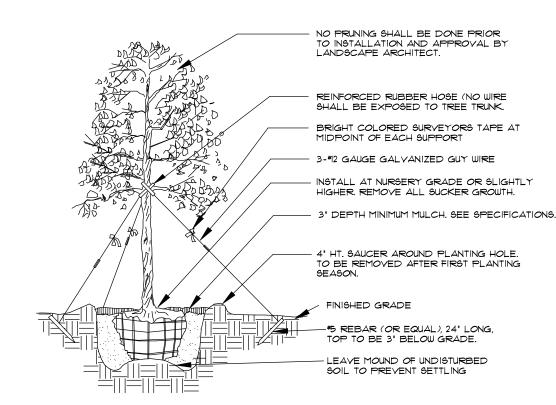

Tree Planting


 SEE SPECIFICATIONS FOR BACKFILL MIXTURE AND FERTILIZATION
 BRACING - SPECIAL SITE CONDITIONS MAY REQUIRE MODIFICATION TO BRACING TECHINQUE. LANDSCAPE CONTRACTOR WILL ADEQUATELY BRACE (OR WIRE) ALL TREES TO PREVENT EXCESSIVE MOVEMENT & MAINTAIN A VERTICAL POSITION.

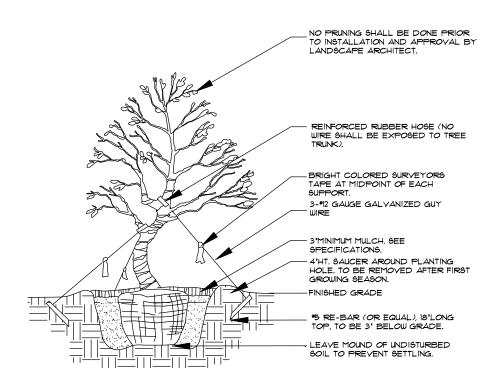

Irregular & Multi-Stem Tree Planting

FOR TREES 6'-14'HT.


NOTES: SEE SPECIFICATIONS FOR BACKFILL MIXTURES AND FERTILIZATION. BRACING-SPECIAL SITE CONDITIONS MAY REQUIRE MODIFICATION TO BRACING TECHNIQUE, LANDSCAPE CONTRACTOR WILL ADEQUATELY BRACE (OR WIRE) ALL TREES TO PREVENT EXCESSIVE MOVEMENT AND MAINTAIN A VERTICAL POSITION.

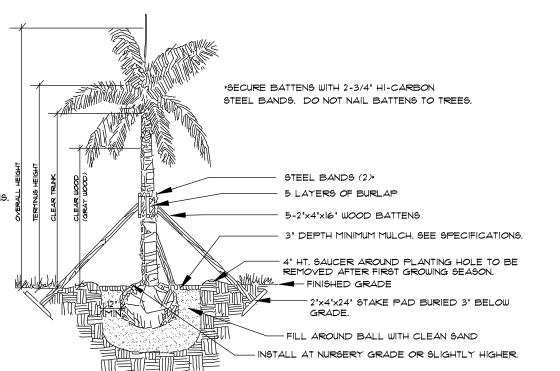

Palm Planting


APPLIES TO: ROYAL PALMS, QUEEN PALMS, ALEXANDER PALMS, MANILA PALMS.

- * SEE SPECIFICATIONS FOR BACKFILL MIXTURE AND FERTILIZATION * BRACING: SPECIAL SITE CONDITIONS MAY REQUIRE MODIFICATION TO
- BRACING TECHNIQUE. LANDSCAPE CONTRACTOR WILL ADEQUATELY BRACE ALL PALMS TO PREVENT EXCESSIVE MOVEMENT AND MAINTAIN A VERTICAL POSITION.

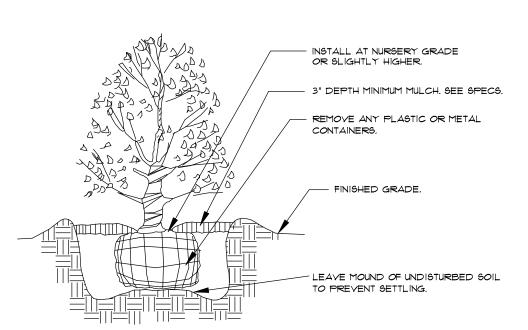

Shrub Planting


* SEE SPECIFICATIONS FOR BACKFILL MIXTURE AND FERTILIZATION.

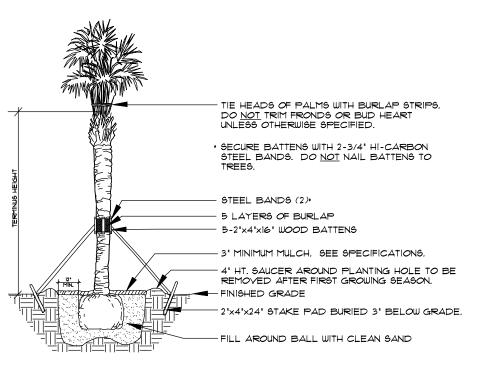

Palm Planting

APPLIES TO: SABAL PALMS, WASHINGTON PALMS, CANARY ISLAND DATE PALMS, SENEGAL DATE PALMS

* SEE SPECIFICATIONS FOR BACKFILL MIXTURE AND FERTILIZATION

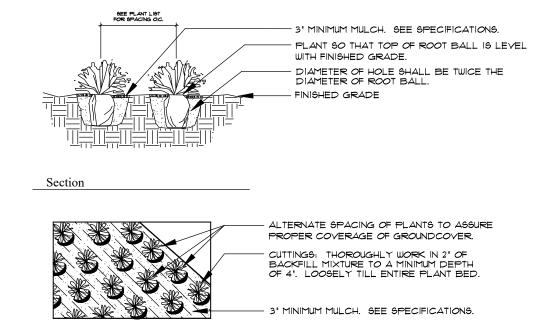

Groundcover Planting

* SEE SPECIFICATIONS FOR BACKFILL MIXTURE AND FERTILIZATION.

Plant List

	PALMS									
0	AM	1	Adonidia merrillii / Christmas Palm	7' c.t., double stem, full frond						
0	CN	5	Cocos nucifera 'Green Malayan' / Coconut Palm	2012', 4014' c.w., heavy cal., full frond						
0	PD	1	Phoenix dactylifera 'Medjool' / Medjool Date Palm	10' c.t., heavy caliper, full frond, Florida Fancy						
* O	SP	16	Sabal palmetto / Cabbage Palm	8010', 8014' c.t., slick trunk, full head						
	TREES									
0	CB	5	Calophyllum brasiliense / Brazilian Beautyleaf	10' $ imes$ 6', limbed up, full canopy, matching, Florida Fancy						
0	NE	3	Noronhia emarginata / Madagascar Olive	$10^{\circ} \times 6^{\circ}$, limbed up, full canopy, matching, Florida Fancy						
	ACCENTS	/ SHRU	BS / GROUNDCOVER / VINES							
	AA	6	Agave americana / Century Plant	32" × 32", full						
0	Al	3	Alcantarea imperialis / Vriesea	7 gal., 32" x 32", full						
0	B0A	32	Begonia odorata 'Alba' / White Angel Wing Begonia	3 gal., 18" × 20", full						
0	CA	24	Crinum asiaticum / Crinum Lily	10° gal., 34" $ imes$ 32", multi-head, full						
* 0	CU3	51	Coccoloba uvifera / Sea Grape	3 gal., 26" x 24", full						
* 0	CU4	59	Coccoloba uvifera / Sea Grape	7 gal., 42" x 30", full						
0	DE	1	Dioon edule / Mexican Cycad	3' × 3Ø", full						
0	EG	156	Evolvulus glomeratus 'Blue My Mind' / Blue Daze	1 gal., 12" × 14", full						
* 0	EL	143	Ernodea littoralis / Golden Beach Creeper	3 gal., 14" x 18", full						
0	FGI	580	Ficus 'Green Island' / Green Island Ficus	3 gal., 14" x 18", full						
0	GS	2	Garcinia spicata / Mangosteen	5' x 3', full to base						
	HIB	53	Hibiscus / Hibiscus shrub	3 gal., 24" x 22", full to base, white flower, red throat						
0	PRC	16	Philodendron 'Rojo Congo'	7 gal., 24" × 30", full						
0	SA	81	Schefflera arboricola / Dwarf Schefflera	3 gal., 24" × 22", full						
0	SA-1	18	Schefflera arboricola / Dwarf Schefflera	7 gal., 4' x 3', full						
0	TJ	9	Trachelospermum jasminoides / Confederate Jasmine	8' ht., full to base, espalier to wall						
* 0	uP	83	Uniola paniculata / Sea Oats	4" clump, 24" o.c.						
	MISCELL	ANEOUS								
	SOD		Stenotabhrum secundatum 'Palmetto' / St. Augustine 'Palmetto'	Solid sod laid tight						

SPECIFICATIONS

SOD

Stenotaphrum secundatum 'Palmetto' / St. Augustine 'Palmetto' — Solid sod, laid tight

O Denotes Drought Tolerance

* Denotes Florida Native Species

Notes

- Prior to the installation of any plant material all existing and imported soils shall be tested and amended to meet the soil specifications and specific plant needs as shown on this plan.

- All plant material, unless specified as being Florida Fancy or Specimen, shall be Florida Grade Number 1

or better as determined by the Florida Division of Plant Industry.

- All plant materials and sod shall have an automatic irrigation system providing 100% coverage. Said system shall consist of an automatic or electronic sensing device or switch that will override the irrigation cycle of the sprinkler system when adequate rainfall has occurred.

- Maintain positive drainage away from residence.

- All plant material shall be planted, fertilized and mulched as per the Plant Details and Plant Specifications noted on this plan.

- Landscape Contractor shall research plans and contact appropriate agencies to determine location of utilities and obstructions prior to commencing work. Any utilities or unanticipated obstructions shall be reported immediately to the Landscape Architect.

- Landscape Contractor will be responsible for obtaining all necessary permits, licenses, inspections, and insurance as required by the State and local agencies.

- Invasive species, including Brazilian Pepper, Australian Pine, Melaleuca, Snake Plant, Scaevola and Earleaf Acacia shall be eradicated in the development area and removed from the site.

design group, inc.

LANDSCAPE ARCHITECTURE PLANNING • GRAPHICS 4425 Military Trail, Suite 202 Jupiter, Florida 33458

Telephone: (561) 747-5069 Fax: (561) 747-2041 Email: mail@pydg.com License #LA0001347

DRAWN BY: CCY/BMS JOB NO.: 23-064 SCALE: N/A FILENAME: Gooch 10

DATE: 8.8.2023

REVISIONS: 11.14.23

ARCHITECT PRIOR TO CONTINUING WORK.

Drainage Notes

1. MATCH ALL EXISTING GRADES ALONG SIDE PROPERTY LINES. 2. PROVIDE SWALES ON BOTH SIDE PROPERTY LINES. NO WATER SHALL DRAIN ONTO NEIGHBORS PROPERTY. 3. CONTRACTOR SHALL BE RESPONSIBLE FOR PROVIDING POSITIVE SITE DRAINAGE AWAY FROM ALL STRUCTURES INCLUDING BUT NOT LIMITED TO PLANTERS, COURTYARD PLANTING AREAS, HARDSCAPE

SURFACES AND ARCHITECTURAL ELEMENTS. 4. CONTRACTOR SHALL PROVIDE DRAINAGE FROM ALL PLANTERS.

Site Data

LOT SIZE: 16,806 S.F.


TOTAL LANDSCAPE AREA: 9,417 S.F. LANDSCAPE COVERAGE: 56.0% (50.0% MIN.)

IMPERVIOUS AREA: 1,389 S.F. IMPERVIOUS COVERAGE: 44.0% (50.0% MAX.)

FRONT YARD AREA: 2,113 S.F. FRONT YARD LANDSCAPE AREA: 1,058 S.F.

FRONT YARD LANDSCAPE COVERAGE: 50.1% (50.0% MIN.)

NOTE: SEE ARCHITECT'S PLANS FOR PROPOSED LOT COVERAGE

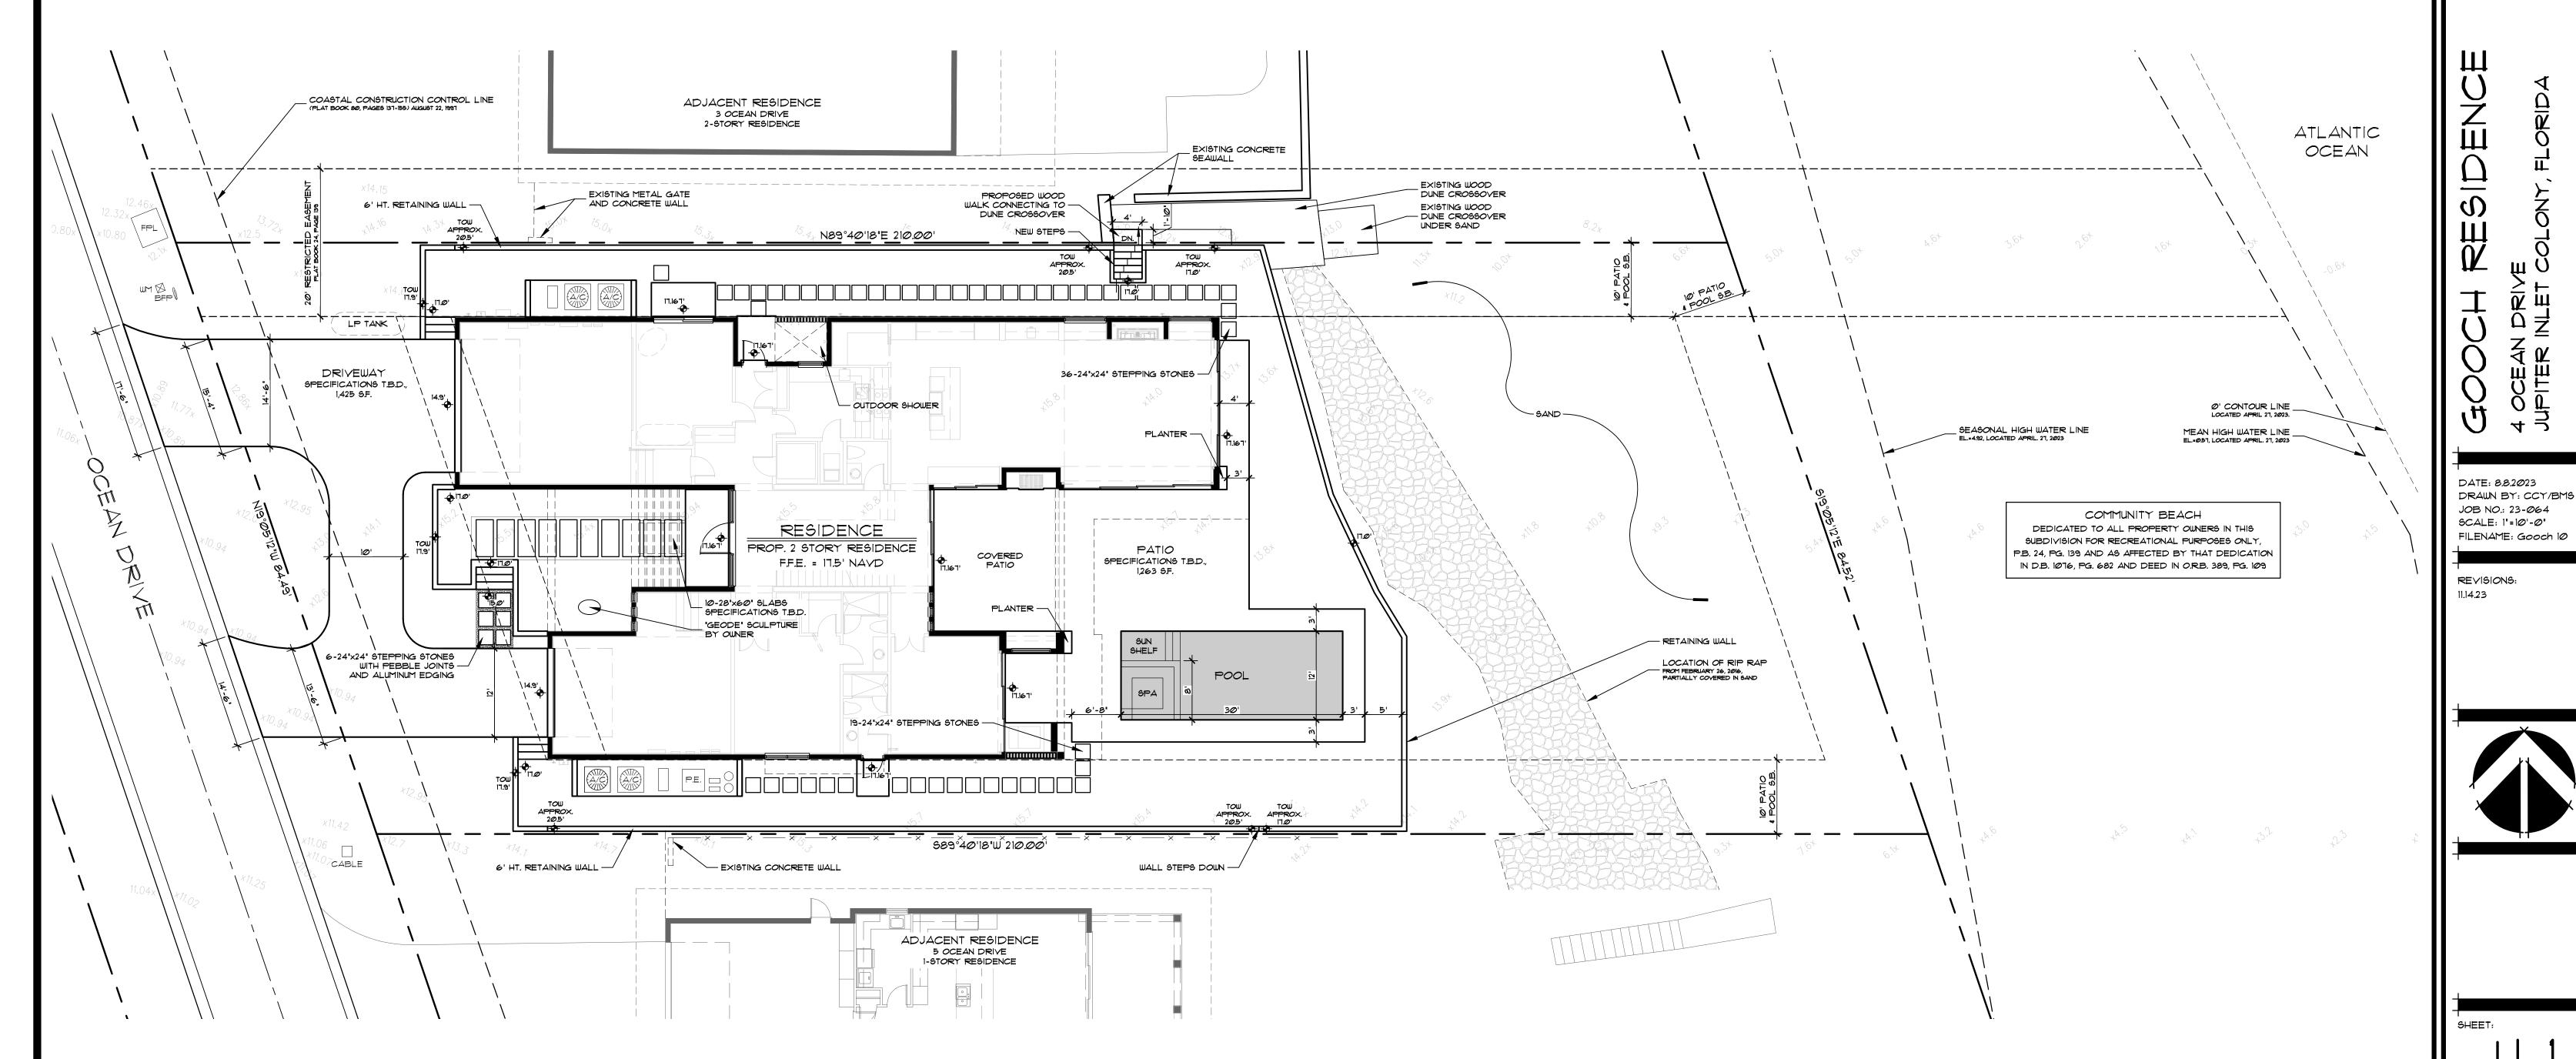

1. PITCH EVENLY BETWEEN SPOT GRADES. ALL PAVED AREAS MUST PITCH TO DRAIN AT MIN. OF 1/8" PER

FOOT. ANY DISCREPANCIES NOT ALLOWING THIS TO OCCUR SHALL BE REPORTED TO THE LANDSCAPE

8. CONTRACTOR SHALL PROVIDE IRRIGATION AND ELECTRIC SLEEVES TO ALL PLANTERS.




PARKER • YANNETT design group, inc.


LANDSCAPE ARCHITECTURE PLANNING • GRAPHICS 4425 Military Trail, Suite 202 Jupiter, Florida 33458

Telephone:(561) 747-5069 Fax: (561) 747-2041 Email: mail@pydg.com License #LA0001347

REVISIONS: 11.14.23

FILENAME: Gooch 10

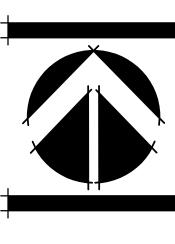

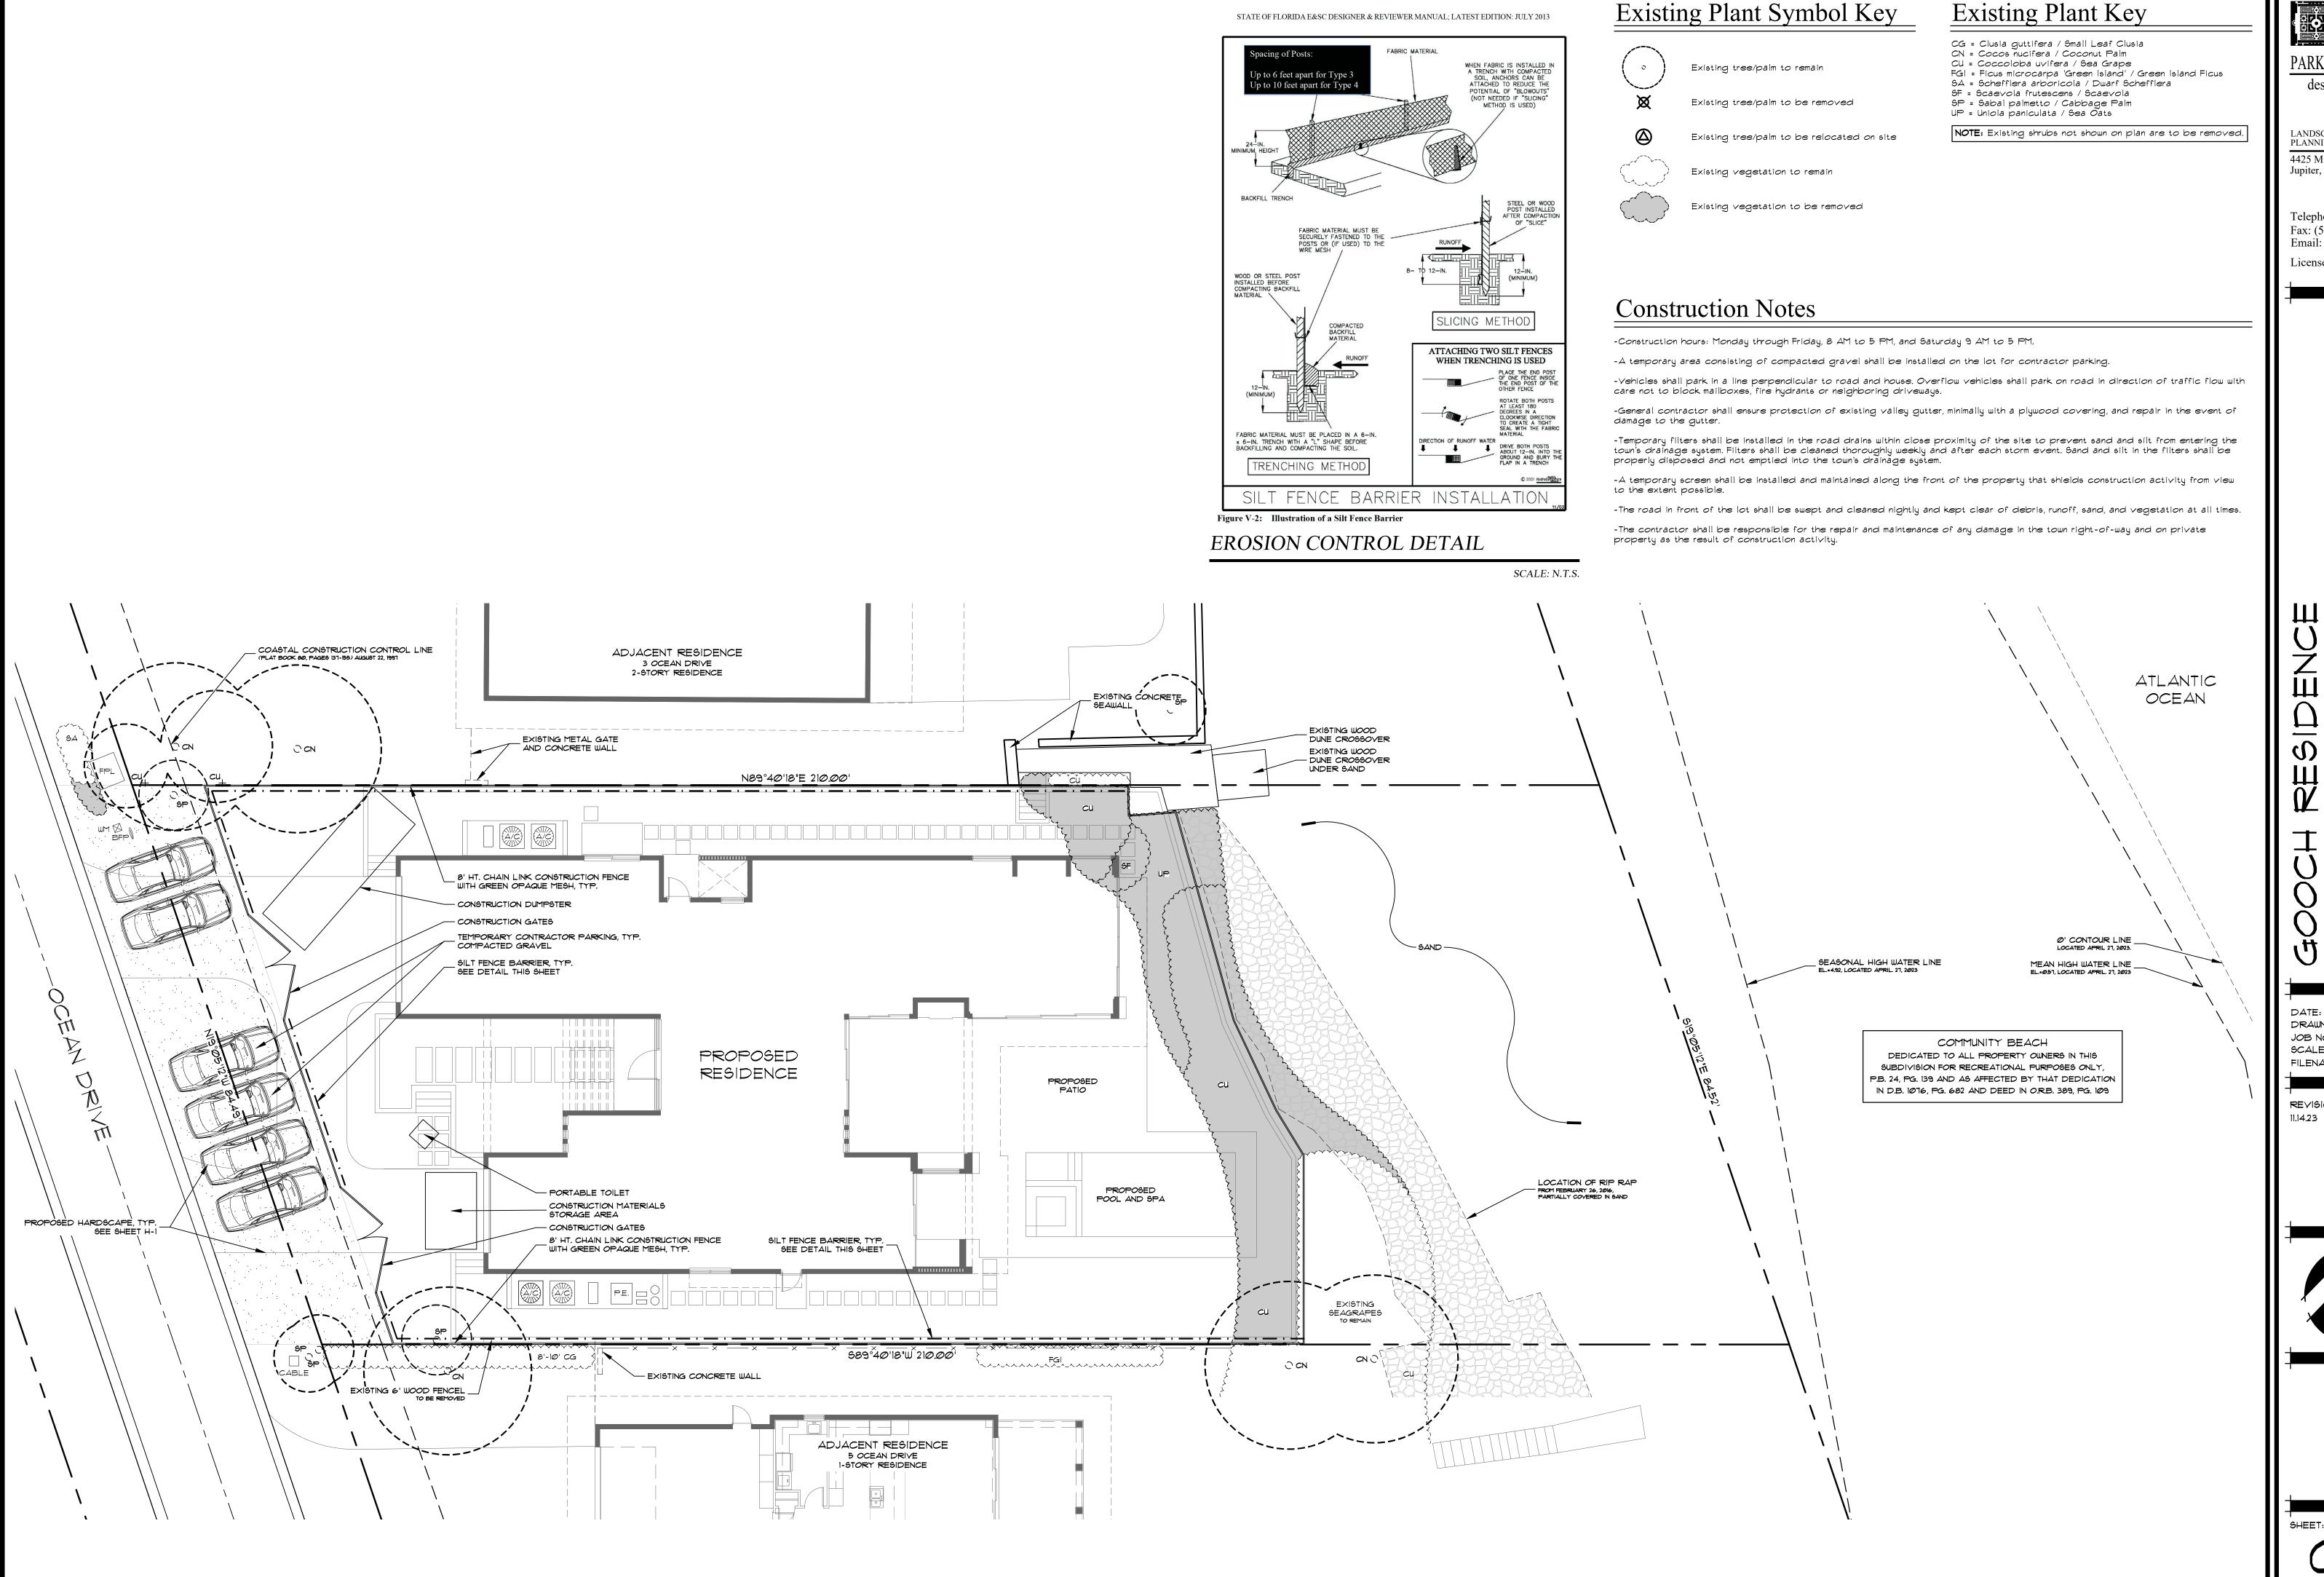

STATE OF FLORIDA E&SC DESIGNER & REVIEWER MANUAL; LATEST EDITION: JULY 2013

Existing Plant Key


PARKER • YANNETT design group, inc.

LANDSCAPE ARCHITECTURE PLANNING • GRAPHICS 4425 Military Trail, Suite 202 Jupiter, Florida 33458

Telephone:(561) 747-5069 Fax: (561) 747-2041 Email: mail@pydg.com License #LA0001347

DRAWN BY: CCY/BMS JOB NO.: 23-064 SCALE: 1"=10'-0" FILENAME: Gooch 10

REVISIONS:

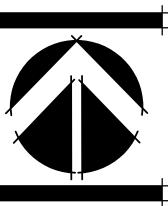



										357 South Cypress Drive, Tequesta, FL 3	469 · 772-260-9179								
										Schedule - Gantt - 4 Ocea	Drive - Gooch								
	ec January 2024		February 2024	March 2024	April 2024	May 2024	June 2024	July 2024	August 2024	September 2024		October 2024	November 2024	December 2024	January 2025	February 2025	March 2025	April 2025	May 2025
Title Start Workdays	Week 1 Week 2 Week 3 31 1 2 3 4 5 6 7 8 9 10 11 12 13 14 15 16 17 18 1	Week 4 Week 5 Week 6 19 20 21 22 23 24 25 26 27 28 29 30 31 1 2 3 4 5 6 7 8	k 6 Week 7 Week 8 W 8 9 10 11 12 13 14 15 16 17 18 19 20 21 22 23 24 25 26 27	Week 10 Week 11 Week 12 Week 13 3 29 1 2 3 4 5 6 7 8 9 10 11 12 13 14 15 16 17 18 19 20 21 22 23 24 25 26 27 28 29 30	Week 14 Week 15 Week 16 Week 17 Week 18 30 31 1 2 3 4 5 6 7 8 9 10 11 12 13 14 15 16 17 18 19 20 21 22 23 24 25 26 27 28 29 30 1 2	Week 19 Week 20 Week 21 Week 21 Week 21 Week 21 Week 21 2 <	Week 22 Week 23 Week 24 Week 25 Week 26 28 29 30 31 1 2 3 4 5 6 7 8 9 10 11 12 13 14 15 16 17 18 19 20 21 22 23 24 25 26 27 28 29 30	July 2024 Week 27 Week 28 Week 29 Week 30 Week 31 1 2 3 4 5 6 7 8 9 10 11 12 13 14 15 16 17 18 19 20 21 22 23 24 25 26 27 28 29 30 31 1	Week 32 Week 33 Week 34 2 3 4 5 6 7 8 9 10 11 12 13 14 15 16 17 18 19 20 21 22 23 24 25 2	Week 35 Week 36 Week 37 Week 38 26 27 28 29 30 31 1 2 3 4 5 6 7 8 9 10 11 12 13 14 15 16 17 18 19 20 21	Week 39 Week 40 Week 41 2 23 24 25 26 27 28 29 30 1 2 3 4 5 6 7 8 9 10 11 12 13 14	Week 42 Week 43 Week 44 Week 44 Week 4 14 15 16 17 18 19 20 21 22 23 24 25 26 27 28 29 30 31 1 2 3 4 5 6	45 Week 46 Week 47 Week 48 Week 47 10 11 12 13 14 15 16 17 18 19 20 21 22 23 24 25 26 27 28 29 30 1 2	Week 49 Week 50 Week 51 Week 52 Week 1 3 4 5 6 7 8 9 10 11 12 13 14 15 16 17 18 19 20 21 22 23 24 25 26 27 28 29 30 31 1 2	Week 2 Week 3 Week 4 Week 5 2 3 4 5 6 7 8 9 10 11 12 13 14 15 16 17 18 19 20 21 22 23 24 25 26 27 28 29 30 31 1 2	Week 6 Week 7 Week 8 Week 9 3 4 5 6 7 8 9 10 11 12 13 14 15 16 17 18 19 20 21 22 23 24 25 26 27 28	Week 10 Week 11 Week 12 Week 13 Week 14 2 3 4 5 6 7 8 9 10 11 12 13 14 15 16 17 18 19 20 21 22 23 24 25 26 27 28 29 30 31 1 2 3 4	Week 15 Week 16 Week 17 Week 18 Week 19 5 6 7 8 9 10 11 12 13 14 15 16 17 18 19 20 21 22 23 24 25 26 27 28 29 30 1 2 3 4 5 6 7 8	Week 20 Week 21 Week 22 Week 23 Week 23 8 9 10 11 12 13 14 15 16 17 18 19 20 21 22 23 24 25 26 27 28 29 30 31 1 2 3 4 5 6 7 8 9
Erosion Control Jan 8, 2024 10 days	Erosion Control																		
Underground MEP Jan 22, 2024 15 days		Underground MEP																	
Concrete Slab, Foudation & Shell Feb 12, 2024 100 days					Concrete Slab, Foudation & Shell														
Pool Piping & Shell Apr 15, 2024 20 days					Pool Piping & Shell														
Waterproofing Jul 1, 2024 3 days								→ Waterproofing —											
Roof Dry In & Flashing Jul 5, 2024 20 days								Roof Dry In & Flashing											
Interior Framing Jul 22, 2024 25 days									Interior Framing										
Exterior Windows & Doors Aug 5, 2024 20 days									Exterior Windows & Doors										
Rough MEP Aug 26, 2024 40 days										Rough	EP								
Lath & Stucco Sep 2, 2024 15 days										Lath & Stucco									
Exterior Finish & Trim Sep 23, 2024 20 days											Exterior Finish & Trim								
Interior Insulation Oct 21, 2024 5 days												Interior Insulation							
Drywall, Tape & Finish Oct 28, 2024 30 days													Drywall, Tape & Finish						
Flooring Installation Dec 9, 2024 25 days														Flooring Installation					
Cabinetry & Vanities Jan 13, 2025 20 days															Cabinetry & Vanities				
Tile & Stone Jan 13, 2025 30 days															Tile & Stone				
Trim & Millwork Jan 13, 2025 45 days																Trim & Millwork			
Template, Fabricate & Install Countertops Feb 10, 2025 20 days																Template, Fabricate & Install Countertops			
Paint - Prep, Primer, Spray, etc Mar 17, 2025 40 days																		Paint - Prep, Primer, Spray, etc	
Hardscape/Landscape Apr 7, 2025 25 days																		Hardscape/Landscape	
Final MEP (Including Appliances) May 12, 2025 20 days																			Final MEP (Including Appliances)
Final Inspections & Punch Out Jun 9, 2025 10 days																			
,																			

CFN 20230032908 OR BK 34096 PG 1042

RECORDED 1/31/2023 7:53 AM Palm Beach County, Florida Joseph Abruzzo, Clerk Pgs: 1042 - 1044; (3pgs)

Document prepared by and Return Recorded Copy to: Nicole C. Morris, Esq. The Law Office of Nicole C. Morris, P.A. 3825 PGA Blvd., Suite 207 Palm Beach Gardens, FL 33410

PCN: 3

32-43-40-31-01-000-0030

RELEASE OF UNITY OF TITLE

WHEREAS, on February 14, 2002, VINCENT BOLLING, JR., the owner at the time of the real property located at 3 Ocean Drive, Jupiter Inlet Colony, FL 33469 ("Property") entered into a *Unity of Title* pertaining to the use of said Property, as described herein, which such *Unity of Title* was recorded on February 15, 2002 in Official Records Book 13419, Page 0625 of the Public Records of Palm Beach County, Florida; and

WHEREAS, AGREEMENT OF TRUST FOR ELANA J. BOLLING U/A/D 11/30/1993, currently owns the Property ("Property Owner"), legally described as:

JUPITER INLET BEACH COLONY LTS 3 & 4 PCN: 32-43-40-31-01-000-0030

WHEREAS, such *Unity of Title* declared that the Property shall be considered as one plot and parcel of land and that no portion of said plot and parcel of land shall be encumbered, mortgaged, sold, transferred, divided, conveyed, devised or assigned separately, except in its entirety as one plot or parcel of land; and

WHEREAS, the Property Owner has requested that the *Unity of Title* be canceled and released; and

WHEREAS, the Town of Jupiter Inlet Colony ("Town") is willing to cancel and release this Unity of Title;

NOW, THEREFORE, for valuable consideration, the receipt and sufficiency of which are hereby acknowledged, the Owner and Town agree as follows:

- 1. Recitals. The above recitals are true and correct and incorporated herein by reference.
- 2. Release. The *Unity of Title* is hereby canceled and released and shall have no further force or effect and that Lots 3 & 4 shall be deemed two separate plots or parcels of land.
- 3. Counterparts/Electronic Signature. This *Release of Unity of Title* may be executed in any number of counterparts, each of which so executed shall be deemed to be an original, and such counterparts shall together constitute but one and the same instrument. The parties shall be entitled to sign and transmit an electronic signature of this instrument (whether by facsimile, PDF or other email transmission), which signature shall be binding on the party whose name is contained therein. Any party providing an electronic signature agrees to promptly execute and deliver to the other parties an original signed instrument upon request.

4. Recording. This <i>Release of Unity of Title</i> will County, Florida upon full execution.	be recorded in the public records of Palm Beach
IN WITNESS WHEREOF, Signed, witnessed	, executed and acknowledged this day of
January, 2023.	ARMAND L. BOLLING, Successor Co- Trustee of the AGREEMENT OF TRUST FOR ELANA J. BOLLING
Witness #1 Signature Witness #1 Print Name: Alexa Bard	Witness #2 Signature Witness #2 Print Name: Arie Parets
STATE OF FLORIDA))ss:	
COUNTY OF PALM BEACH)	
SUBSCRIBED AND ACKNOWLEDGED	before me in person by ARMAND L.
BOLLING, Successor Co-Trustee of the AGREEN	MENT OF TRUST FOR ELANA J.
BOLLING , who is personally known to me on this	// day of January, 2023.
[SEAL] SEAL	NOTARY PUBLIC
Public Under Continued of the Continued	ANTHONY RIZZO, Successor Co-Trustee of the AGREEMENT OF TRUST FOR
And Pareto	ELANA, J. BOLLING
Witness #1 Signature 1	Witness #2 Signature .

STATE OF FLORIDA)
COUNTY OF PALM BEACH)ss:
COUNT OF TALM BLACK	,
	EDGED before me in person by ANTHONY RIZZO,
	NT OF TRUST FOR ELANA J. BOLLING, who is
personally known to me on thisday of .	January, 2023.
WINNIHMINI	1///
[SEAL]	
1 1 1 1 1 1 1 1 1 1 1 1 1 1 1 1 1 1 1	NOTARY PUBLIC
* * * * * * * * * * * * * * * * * * *	
To onged this west of	
JUBUC STATE OF WILLIAM	
William III	
	TQWN OF JUPITER INLEȚ COLONY
	A) a.i. (Homes Xontu
	By: DR. DANIEL J. COMERFORD, III
1	It's: Mayor
LAHAWI - Showners	
Witness #1 Signature	Witness #2 Signature
Witness #1 Signature Witness #1 Print Name: LATOYA J. THOP	Witness #2 Print Name ATHI DEVELIUS
STATE OF FLORIDA)
)ss:
COUNTY OF PALM BEACH)
SUBSCRIBED AND ACKNOWLI	EDGED before me in person by DR. DANIEL J.
COMERFORD, III, in his capacity as the M	Mayor of the Town of Jupiter Inlet Colony, who is
personally known to me on this 18th day of	January, 2023.
[SEAL]	NOTARY PUBLIC
IVELISSE CHICO-RANDAZZO	NOTARY PUBLIC
Notary Public - State of Fiori	
Bonded through National Notary As	

Prepared by and return to: Town of Jupiter Inlet Colony 50 Colony Road Jupiter Inlet Colony, FL 33469

AGREEMENT FOR CONSTRUCTION WITHIN EASEMENT

Diane Gooch, a single woman, (hereinafter "Owner") and the Town of Jupiter Inlet Colony, Florida (hereinafter "Town") hereby agree as follows:

WHEREAS, Owner is the owner of certain real property located at 4 Ocean Drive Jupiter Inlet Colony, Florida. (the "Property"). The Property is legally described as follows:

Lot 4, JUPITER INLET BEACH COLONY, according to the plat thereof recorded in Plat Book 24, page 139 of the public records of Palm Beach County, Florida.

Parcel ID No. 32-43-40-31-01-000-0040

WHEREAS, the Plat for JUPITER INLET BEACH COLONY, as referenced above, depicts an easement described as "U. S. Government Easement" that is located on the north ten (10') feet of the Property; and

WHEREAS, Owner desires to construct a privacy wall, a paver walkway, stairs and mechanical improvements (hereinafter "Improvements") in the area shown as the U.S. Government Easement area and Town desires to approve such construction subject to the terms and conditions as forth herein.

NOW, THEREFORE, in consideration of the mutual covenants, considerations, representation, warranties and promises herein contained and other good and valuable consideration, the sufficiency of which is hereby acknowledged by each party, the parties agree as follows:

The Town agrees to allow the Improvements described above under the following terms and conditions:

1. Owner shall obtain a building permit prior to construction of the Improvements and agrees that the Improvements will be constructed/installed and maintained in accordance with the Town's Code of Ordinances.

- 2. Owner agrees to remove or relocate the Improvements at her own expense upon request of the Town. Upon such removal or relocation, Owner agrees to restore the Easement to its previous condition. If Owner fails to do any of the above within ten (10) days of such request, Town may remove or relocate the Improvements and restore the Easement to its previous condition, and Owner agrees to reimburse the Town for any expenses it incurs in connection therewith. Owner understands and acknowledges that the Town will not be responsible in any way for repairs to, or replacement of, the Improvements or any portion thereof.
- 3. This Agreement shall be recorded, at the Owner's expense (standard fees by the Clerk of the Circuit Court, and the Owner will be billed by the Town Clerk), in the public records of Palm Beach County, Florida and shall be a covenant running with the Property, and shall be binding on the Owner, her successors and assigns.
- 4. Owner hereby agrees that she will indemnify and hold the Town harmless from and against any and all claims, demands, lawsuits, settlements, damages, costs and expenses, including attorney's fees, suffered or incurred by the Town and arising out of or in connection with the subject matter of this Agreement.

Witnesses:	
O Stuff-	
Owen Stauffer Print Name	Wen fr
Laur Merga Freedmen	Diane Gooch
Print Name	Laura Maggi-Friedman Notary Public New Jersey
STATE OF FLORIDA) COUNTY OF PALM BEACH)	My Commission Expires 4-29-2025 No. 50126806
means of (x) physical presence or ()	Difful (2000) Type X A in
	Notary Public My Commission Expires:

SHORELINE SEAGRAPE MAINTENANCE AGREEMENT

NAME: Ms. Diane Gooch

PROPERTY ADDRESS: 4 Ocean Drive, Jupiter Inlet Colony. FL 33469

ınd

NAME: Mr. Roger Siboni

PROPERTY ADDRESS: 5 Ocean Drive, Jupiter Inlet Colony, FL 33469

Diane Gooch and Roger Siboni, in order to protect and maintain ocean views across each other's property while providing protection from beach erosion, agree to a snared maintenance of the Seagrapes along our adjoining shoreline. The maintenance of the Seagrapes will be administered by Rob Mancuso aka "Ocean Breeze" or the current maintenance company used by the town of Jupiter Inlet Colony. In order to maintain the continuity of sea grape coverage, the Seagrapes shall be maintained to a height no higher than 3' above grade measured along the east side of the retaining wall along the rear of the Gooch property and tapering down to a height of about 24" and/or matching the Seagrapes along the rear of the Siboni property. The expense shall be based upon the relative square footage and be billed separately on a quarterly maintenance basis or as mutually agreed upon depending on growin.

The terms of this agreement shall be construed as the entire agreement and may not be altered, amended, or modified except in writing and signed by both parties. The terms of this agreement shall be governed by the laws of the State of Florida.

Date: 12/7/23

Signed:

(Ms. Diane Gooch)

Datas

Signed:

(Mr. Roger Siboni)



CCCL Dune Plant Maintenance Guidelines

These guidelines provide best management practices for maintenance of seagrapes and other salt tolerant dune plants protected seaward of a coastal construction control line by state law 161.053 (2)(a), Florida Statutes.

Beach – Dune Vegetation

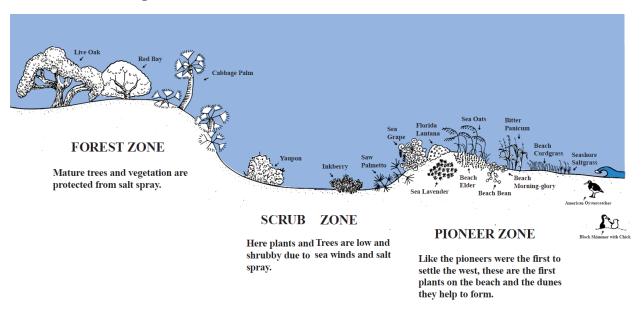


Figure 1: Diagram of pioneer, scrub (or strand) and forest zones of dunes within a typical Florida beach and dune system.

Sea oats, seagrapes and other plants growing on Florida dunes give significant benefits to beaches, dunes, upland properties and wildlife. Salt tolerant dune plants:

- build protective dunes by trapping and stabilizing wind-blown beach sand,
- reduce erosion losses by wind and storms,
- provide a buffer against storm surges and salt spray,
- provide shelter for wildlife, and
- block light pollution for nesting and hatchling sea turtles.

Dune plants are resilient and adapted to survive storms and grow back through natural recovery processes. At the same time, dune plants can be easily damaged by construction and other human activities and require much longer recovery times. It is important to conduct dune plant maintenance so that the plants are not permanently damaged and sea turtles and dune systems are protected.

What are Dune Plants?

Dune plants are those native trees, shrubs, grasses, groundcovers and other plants found in beach dune, coastal berm, coastal grassland, coastal strand and maritime hammock natural communities as described by the Florida Natural Areas Inventory (see <u>Guide to the Natural Communities of Florida – 2010 Edition</u>). Native plants are those species documented as native or endemic in the <u>Atlas of Florida Vascular Plants</u> maintained by the Institute for Systematic Botany. Nuisance or Invasive Exotic Plant Species are those species listed in the Florida Exotic Pest Plant Council's <u>List of Category I and II Invasive Species</u>. Plants that have been intentionally planted or installed, or inadvertently introduced into the dune system for purposes other than for dune restoration are considered to be ornamental or landscape plantings.

What are the State Laws related to Dune Plant Maintenance?

Beach-dune plant damage or removal located seaward of a state of Florida coastal construction control line (CCCL) is regulated under section 161.053, Florida Statutes (F.S.). Additional protections for sea oats, *Uniola paniculata*, and seagrapes, *Coccoloba uvifera*, are found in section 161.242, F.S. CCCL regulations do not supersede more stringent requirements of other laws or jurisdictions that may be in effect, or the protection of endangered, threatened or commercially exploited plants regulated under Chapter 581 of the Florida Statutes, and Rule Chapter 5B-40, of the Florida Administrative Code.

In recognition of the storm buffer services of dune plants, Florida law states that no person, firm, corporation, or governmental agency shall damage or cause to be damaged sand dunes or the vegetation growing on them without a permit from the Florida Department of Environmental Protection (FDEP) (subparagraph 161.053(2)(a), Florida Statutes). Consequently, FDEP Coastal Construction Control Line Program (CCCL) rules in Chapter 62B-33, Florida Administrative Code, protect these important native salt-tolerant dune plants from damage. On dune systems seaward of the Department's Coastal Construction Control Line, property owners or their agents cannot cut down or damage beach dune plants without a CCCL permit. Landscape plant maintenance activities that target ornamental or introduced non-native species or do not damage native beach-dune vegetation or involve excavation do not require CCCL permits and are exempt from CCCL permit application requirements under subparagraph 161.053(11)(c)2, F.S.

What "Damages" Dune Plants?

Damage to vegetation refers to a material reduction in the health of plant from trampling, crushing, chopping, breaking, digging up, or excessive cutting of roots, stems, trunks, branches or leaves of beach dune plants naturally occurring or planted on-site for dune enhancement seaward of a CCCL. Excessive cutting means the removal of roots, branches, stems and leaves in exceedance of accepted horticultural practices, such as the standards published in ANSI A300 Part 1: Tree, Shrub and other Woody Plant Maintenance -Standard Practices, Pruning. Tree and landscape maintenance practices recognize exceptions to the standards and that certain coastal plants adapted to recover from breakage by damaging tropical storm force winds, such as seagrape, *Coccoloba uvifera*, are tolerant of heavy pruning or coppicing. Damage to beach and dune vegetation can be avoided, minimized or mitigated through employment of arborists and other landscape professionals and when following best management practices tailored for the unique physical conditions of coastal dune environments.

What Permits, if any, are Required to Cut Dune Vegetation?

Cutting dune vegetation seaward of a coastal construction control line requires a CCCL permit unless the activity qualifies as a minor activity determined by the department not to have an adverse effect on the coastal system, such as "maintenance of existing beach-dune vegetation" exempted in state law. Vegetation maintenance that does not damage native dune plants includes trimming, shearing, pruning, dead heading and other accepted horticultural practices, and does not require a CCCL permit pursuant to section 161.053(11), F.S. An exemption of the work from CCCL permitting requirements does not shield the property owner from his or her responsibility for following other laws or from enforcement action taken by other local, state, or federal agencies. Furthermore, proper arboricultural and horticultural practices must be followed to ensure that the native beach-dune plants are not damaged or destroyed from the maintenance. Trespass onto another's property to remove vegetation without the property owner's approval is also not allowed.



Figure 2: Sea oats, Uniola paniculata, building a dune by trapping and stabilizing windblown beach sand.

CCCL staff are available to assist property owners in determining if the dune maintenance project is exempt, or if not exempt, in processing the proper CCCL permit. CCCL field inspectors can schedule site visits to meet on the property, discuss projects over the phone, and issue CCCL Field Permits as needed. Additionally, property owners can send dune maintenance project information (eg. address, description of work, photographs and plans) to a CCCL permit manager in a consultation request emailed to cccl@dep.state.fl.us. The permit manager can assist with the processing of a CCCL Individual Permit application as needed. Both CCCL field inspector and permit manager contact information is located at the FDEP CCCL webpage or by calling 850/245-2094 and asking for the CCCL staff member assigned to the county of the project.

General Dune Plant Maintenance Guidance

- Work is to be conducted in a way that does not alter or damage dune topography or beach-dune vegetation, require new beach access, disturb marked sea turtle nests or known nest locations, obstruct public access, cause excavation of the ground or damage adjacent properties.
- Any disturbance of the beach or soil surface must be restored to a stable, pre-work condition.
- Removal of beachfront vegetation must not result in the increase of the visibility of artificial light from the beach, nor additional exposure of salt-sensitive plants or property to increased salt spray.
- Vegetation maintenance, trimming, or removal requires the approval of the property owner or if on public property, the approval of the responsible government resource management agency.
- Native dune plants damaged by unauthorized maintenance activities must be replaced to the approval of the Department.



Property owners and others maintaining native vegetation seaward of the Coastal Construction Control Line must consider possible harm to sea turtles. Removal of beachfront vegetation increases the potential for disorientation and subsequent injury or mortality of hatchling sea turtles, which are attracted to light. Pruning or trimming removes vegetation from the canopy that often blocks lights from shining on the beach and thus protects sea turtle nesting habitat. Vegetation maintenance that increases lighting of the beach must be in compliance with section 379.2431, Florida Statutes, "Marine Turtle Protection Act." Information on lighting issues is provided in the publication "Sea Grape Trimming and Sea Turtles," available on the CCCL webpage or by visiting the Florida Fish and Wildlife Conservation Commission sea turtle conservation program website. The Florida Fish and Wildlife Conservation Commission, Imperiled Species Management Section can be reached at 850/922-4330 or marineturtle@myfwc.com.

- If reducing the tree crown or canopy of the dune vegetation, the property owner must evaluate existing or potential sources of light visible from the beach and take appropriate measures to eliminate the possibility of increased light cast on the nesting beach. Before cutting down vegetation seaward of a beach house, property owners can protect sea turtle nesting habitat by replacing light fixtures that are visible from the beach with shielded "can" type or other fixtures.
- Operation, transportation, or storage of equipment or materials, including skid steers, cherry pickers
 and other equipment on the beach or frontal dune must be scheduled outside sea turtle nesting
 season, or coordinated with CCCL and FWC staff if proposed during nesting season. This may
 require engaging the services of a state permitted biologist to ensure that proposed activities avoid
 all sea turtle nesting, nests and hatchlings.

References

Guide to the Natural Communities of Florida – 2010 Edition.

Atlas of Florida Vascular Plants website maintained by the Institute of Systematic Botany

Florida Exotic Pest Plant Council's <u>List of Category I and II Invasive Species</u>

Florida Beach and Shore Preservation Act, Chapter 161, Florida Statutes, (go to Online Sunshine)

ANSI A300 Pruning Standard – Part 1 "Tree, Shrub, and Other Woody Plant Management – Standard Practices (Pruning); American National Standards Institute.

Coastal Construction Control Line Program, FDEP. (see website)

Coastal Construction Control Line Program

Florida Department of Environmental Protection Office of Resilience and Coastal Protection Bob Martinez Center, Suite 505 2600 Blair Stone Road, MS 3522 Tallahassee, Florida 32399-2400

Email: cccl@dep.state.fl.us

Website: www.FloridaDEP.gov/CCCL

CCCL Dune Plant Maintenance Guidelines March 2022

JUPITER INLET COLONY BUILDING AND ZONING COMMITTEE REVIEW STANDARDS

MASS AND VOLUME

Zoning Code Section 10.1. - Development standards for single family residences.

Mass and Volume Distribution. Because lots within the town are limited in size, the massing and volume of any new residential building or addition should be sensitive to the profiles of adjacent buildings and should locate second stories adequately to reduce the apparent overall scale of the building. Second story windows, decks, terraces, and balconies for new construction shall be designed and located to ensure privacy for adjacent properties to the extent possible. (emphasis added)

IMPACT REVIEW STANDARDS AND DECISIONS Ordinance 02-2021

Procedures: Standards for Review. In performing its impact review analysis, the Building and Zoning Committee shall approve an application if the Applicant demonstrates that:

- a. The proposed development will not adversely affect the public interest; and
- b. The mass, scale and height of the proposed development is consistent with the surrounding properties and neighborhood character; and
- c. The proposed development will not adversely affect adjoining properties; and
- d. For development on waterfront properties, the proposed development is sensitive to and preserves views from adjoining properties as much as is practicable.

Decisions: Appeals. In performing its impact review analysis, the Building and Zoning Committee shall either approve, approve with conditions, or deny an application for development approval. In the event the Building and Zoning Committee finds that an application meets the requirements of this Section, then the application shall be approved. In the event the Building and Zoning Committee approves the application with conditions or denies the application, the Applicant may either amend its development application in compliance with the decision of the Building and Zoning Committee or may appeal the decision to the Town Commission. ...

JUPITER INLET COLONY BUILDING AND ZONING COMMITTEE MEETING 01-18-2024

Conditions of Approval: #4 Ocean Drive

- 1) A temporary area consisting of compacted gravel shall be installed on the lot for contractor parking.
- 2) Temporary filters shall be installed in the road drains within close proximity of the site to prevent sand and silt from entering the town's drainage system. Filters shall be cleaned thoroughly weekly and after each storm event. Sand and silt in the filters shall be properly disposed and not emptied into the town's drainage system.
- 3) A temporary screen shall be installed and maintained along the front of the property that shields construction activity from view to the extent possible.
- 4) The road in front of the lot shall be swept and cleaned nightly and kept clear of debris, runoff, sand, and vegetation at all times.
- 5) The contractor shall be responsible for the repair and maintenance of any damage in the town right-of-way and on private property as the result of construction activity.
- 6) Prior to the issuance of a building permit, the property owner shall enter into a removal agreement for the area encumbered by an existing easement along the north property line.
- 7) Prior to the issuance of a building permit, the property owner shall enter into an agreement with the property owner to the north allowing shared access and use of the dune walkover at #3 Ocean Drive.
- 8) The property owner shall maintain all vegetation east of the oceanside retaining wall to ensure existing views of the Atlantic Ocean and public beach to the north and south are maintained from abutting properties.
- 9) During construction, the general contactor shall provide the Town quarterly updates regarding the construction schedule, major milestones, and timeline to complete the residence. Any significant deviation from the schedule shall require review and approval by the Building and Zoning Committee.

MINIMUM LANDSCAPE REQUIREMENTS

At the request of the Town Commission on January 8, 2024, the Planning and Zoning Administrator has been directed to develop minimum landscape standards for single family residences. The current regulations for landscaping are below and can be generally summarized as follows:

- Landscape plan prepared by a license landscape architect required.
- Minimum required landscape area is based on a percentage of lot size; irrigation required; native vegetation encouraged.
- Design criteria is descriptive and subject to approval by the Building and Zoning Committee.
- Landscape permit required no certificate of occupancy until all landscaping is in place as shown on approved plan and permit.

Sec. 19-2. - Required residential landscaping.

- (a) One-story residence. For a one-story home that conforms to section 10(C)(1) of the Zoning Code, at least forty (40) percent of the land area of a residential property shall be developed, maintained and preserved as lawn, plants, bushes, shrubs, trees and other organic landscape material. For a one-story home that does not conform to section 10(C)(1) of the Zoning Code, the minimum required residential landscaping shall be fifty (50) percent.
- (b) Two-story residence. For a two-story home, at least fifty (50) percent of the land area of a residential property shall be developed, maintained and preserved as lawn, plants, bushes, shrubs, trees and other organic landscape material.
- (c) Ground cover. Pebbles, gravel, and stones may be used as a mulch or protective ground cover immediately around the base of landscape material in accordance with typical horticultural practices. When used in such a manner, ground cover shall not count toward lot occupancy. When used in any other manner, pebbles, gravel, stones, and other inorganic materials shall count toward lot occupancy. (Ord. No. 04-2014, § 1, 5-12-14; Ord. No. 06-2018, § 8, 5-14-18)

Sec. 4-7. - Landscaping and landscape plans...

- (a) Landscaping and landscape plans:
- (1) At the time that application is made for a building permit for new construction, a building repair or renovation that has the effect of relocating exterior walls of a structure or a repair or renovation to an existing structure the cost of which exceeds the amounts set forth in Section 9(D)(2) or (4) of Appendix A Zoning Code, there shall be submitted additionally two (2) copies of landscape plans for the premises. Such landscape plans shall provide for sodding, shrubs, trees or ornamental landscaping conforming generally with that displayed in the community. All plantings will be defined on the landscape plan by both common and scientific name. The applicant shall use native species in landscaping and native dune vegetation when restoring dune systems. South Florida Water Management District Xeriscape practices shall be used in connection with these landscape regulations when considering proposals for development and/or redevelopment. No landscaping shall be installed prior to issuance of a landscape permit by the planning and zoning

- administrator upon review and approval of the building and zoning committee. No certificate of occupancy shall be issued until all landscaping is in place as set forth on the approved plan and permit.
- (2) Necessary access ways from public rights-of-way through all required landscaped areas shall be permitted to service the open land use.
- (3) All landscaped areas and plantings shall be provided with automatic irrigation facilities.
- (4) In cases where hedges or continuous screening, or a structure already exist on the front property line to a height of at least four (4) feet, no planting strip nor trees shall be required.
- (5) The town shall require the use of native vegetation in landscaping and native dune vegetation in dune areas. South Florida Water Management District Xeriscape practices shall be used in connection with these landscape regulations when considering proposals for development and/or redevelopment.
- (6) Whenever appropriate, existing trees shall be conserved and integrated into the landscaping design plan.

RECOMMENDATIONS:

- 1. Develop minimum prescriptive requirements for single family residences, and
- 2. Schedule final landscape inspection on all new development or require an affidavit by the landscape architect of record confirming all landscaping is in place as shown on the approved plan and permit.