

### NOTICE OF PUBLIC MEETING BUILDING AND ZONING COMMITTEE LOCATION: TOWN HALL, 50 COLONY ROAD DATE AND TIME: WEDNESDAY, MARCH 20, 2024 AT 5:00 PM

Join by Zoom at: <u>https://zoom.us/join</u> OR dial-in by location:

+1-301-715-8592 +1-312-626-6799 +1-929-205-6099 +1-253-215-8782 +1-346-248-7799 +1-669-900-6833

Meeting ID: 585 628 8134 Password: 3787

### **MEETING AGENDA**

- 1. Call to Order.
- 2. Roll Call: Russell Bourne (Chair), William Gilbane (Vice Chair), Butch Harper, Brad Eavenson, Roger Siboni, Katharine Murray, Matthew Carrara. Planning and Zoning Administrator: Bill Whiteford
- 3. Motion to approve prior minutes February 15, 2024 meeting.
- 4. Public Comments items not on the agenda (3 minutes).
- 5. Discussion Item:
  - A. Building permit fees and timeframes to complete construction (final discussion).
- 6. Continued Items:
  - A. #20 Ocean Drive: new two-story residence with outdoor pool. Total under air: 6,834 sf. Total square footage: 9,768 sf. Lot occupancy calculation: 47.97% (50% allowed). Maximum building height: 25' (25' allowed).
  - B. #34 Ocean Drive: new two-story residence with outdoor pool. Total under air: 3,795 sf. Total square footage: 4,637 sf. Lot occupancy calculation: 49.29% (50% allowed). Maximum building height: 24'-11¼" (25' allowed).
- 7. Other Matters: accessory structure setbacks and screening.
- 8. Motion to Adjourn.

#### STATE MANDATED STATEMENT

If a person decides to appeal any decision made by the board, agency, or Commission with respect to any matter considered at such meeting or hearing, he/she will need a record of the proceedings, and that, for such purpose, he/she may need to ensure that a verbatim record of the proceedings is made, which record includes the testimony and evidence upon which the appeal is to be based. Any person requiring a special accommodation at this meeting because of a disability or physical impairment should contact the Town Administrative Office at 50 Colony Road, Jupiter Inlet Colony, FL 33469, or by telephone at 561-746-3787, prior to the meeting.



#### A MUNICIPALCORPORATION

#### TOWN OF JUPITER INLET COLONY BUILDING AND ZONING COMMITTEE MEETING

#### BUILDING AND ZONING MEETING Thursday, February 15, 2024

#### **MINUTES**

- 1. Call to Order. Russell Bourne called the meeting to order at 5:04 p.m.
- 2. Roll Call:

Russell Bourne (Chair) - Present William Gilbane (Vice Chair) - Present Butch Harper - Present Brad Eavenson - Absent Roger Siboni - Absent Katharine Murray - Present Matthew Carrara – Present

Also in attendance: Mike Armato, owner 34 Ocean, on the phone, Chris Sorenson, CEA, Mitch Miller, Village Architects, Chris Andrus, Village Architects, Don French, homeowner 64 Colony, Marie Rosner, Commissioner,

- 3. Motion to approve prior minutes January 18, 2024 meeting. Butch Harper made the motion to approve the minutes, the motion was seconded by Matt Carrara, and the motion passed unanimously.
- 4. Public Comments items not on the agenda (3 minutes). No Comments
- 5. New Items:

The Chair, Russell Bourne requested to change the order of plan review and review the property of 34 Ocean first.

A. #34 Ocean Drive: new two-story residence with outdoor pool. Total under air: 3,827 sf. Total square footage: 4,669 sf. Lot occupancy calculation: 49.84% (50% allowed). Maximum building height: 24'-11¼" (25' allowed).

#### STATE MANDATED STATEMENT

If a person decides to appeal any decision made by the board, agency, or Commission with respect to any matter considered at such meeting or hearing, he/she will need a record of the proceedings, and that, for such purpose, he/she may need to ensure that a verbatim record of the proceedings is made, which record includes the testimony and evidence upon which the appeal is to be based.



Bill Whiteford provided background to the project and discussed the building setbacks in the handout.

Mike Armato commented about the setbacks and deferred to Mitch Miller, Village Architects and Bill Whiteford.

Mike Armato stated that he was not able to log into Zoom.

Discussion of the irregular lots and the setbacks. Mitch Miller would like to participate in the discussion of the code, how it is written and interpreted. Further discussion on the drainage, currently there is an issue with drainage, and we do not have an approved grade and drainage plan.

Matt Carrara brought up discussion of location of pool equipment and generators. Bill Whiteford cited code for requiring a pad for pool equipment, and the screen requirement for generators. Katharine Murray asked about the times when the pool pumps run.

Bill Whiteford reviewed all plans of the house, grade & drainage, and landscape plans.

Mike Armato asked if a retaining wall should be placed on the side and level the lot. Bill Whiteford stated that drainage needs to be from back to front. The committee discussed the use of the retaining wall on the property. Bill Whiteford stated that Tom Jensen and Chad would need to approve a retaining wall.

Don French commented on the elevation and that it seemed a bit high at the moment. The committee discussed the various elevations of the surrounding lots. Bill Whiteford stated that Tom Jensen will review all points and we are waiting for Tom's final approval.

Katharine Murray asked the question about windows on the second floor and how they align with the neighbor's home and the committee discussed. Bill Whiteford said it is in the code that there must be windows on the second floor but only 10%.

There was discussion on deferring approval of the plans for 34 Ocean until the March B&Z meeting. Russell Bourne asked for a motion.

Butch Harper made the motion to defer approval until the March meeting when all plans are received, the motion was seconded by Matt Carrara, and the motion carried unanimously.

#### STATE MANDATED STATEMENT

If a person decides to appeal any decision made by the board, agency, or Commission with respect to any matter considered at such meeting or hearing, he/she will need a record of the proceedings, and that, for such purpose, he/she may need to ensure that a verbatim record of the proceedings is made, which record includes the testimony and evidence upon which the appeal is to be based.



B. #20 Ocean Drive: new two-story residence with outdoor pool. Total under air: 7,745 sf. Total square footage: 10,588 sf. Lot occupancy calculation: 48.83% (50% allowed). Maximum building height: 24'-11 5/8" (25' allowed).

Bill Whiteford reviewed the plans for 20 Ocean with the committee. One area of concern is that this property has a basement. The square footage of the basement is not included in the total sq. ft. of the house, which keeps it under 50%, but including it pushes it over the 50% lot coverage.

The committee continued discussion about the basement, the water table, and Mitch Miller stated that after the B&Z approves the plans, they then go to the State for review by the Coastal Commission. The walls of the basement must be breakaway walls per the DEP.

Discussion on the solar panels, there will not be a generator on property, but in its place will be a battery panel located in the basement room.

Butch Harper objects to the basement due to possibility of erosion based on recent events of the ocean front homes in the Town and would like to see a complete redesign of the basement structure.

Discussion on the square footage, the basement increases the total, and how to make it passable as uninhabitable, Mitch Miller stated that the ceiling could be lowered from 8 feet to 7'2", which qualifies as uninhabitable.

The committee said the review and approval needs to be deferred until the March B&Z meeting.

Bill Gilbane made the motion to defer review and approval until the March meeting, the motion was seconded by Butch Harper, the motion carried unanimously.

#### STATE MANDATED STATEMENT

If a person decides to appeal any decision made by the board, agency, or Commission with respect to any matter considered at such meeting or hearing, he/she will need a record of the proceedings, and that, for such purpose, he/she may need to ensure that a verbatim record of the proceedings is made, which record includes the testimony and evidence upon which the appeal is to be based.



A MUNICIPALCORPORATION

- 6. Discussion Items:
  - A. Building permit fee schedule (Resolution R-2019-07).

Russell provided the history of the revision of this resolution as well as the Town Ordinance. And provided the information discussed at the meeting Mayor Hocevar had with the several of the Builders on February 2, 2024.

Discussion on how to implement the fee structure, monitor construction schedules, and modify the ordinance and resolution.

Butch Harper suggested that permit fees are front loaded with the reward to get a refund when construction is completed before or on schedule. Matt Carrara suggested receiving a quarterly report from the contractor detailing where they are in the construction project.

Russell Bourne suggested that the fee is based on the square footage of the lot rather than the house.

7. Any Other Matters:

Bruce brought up Form 1 and said that the B&Z members will need to complete it.

8. Motion to Adjourn:

Matt Carrara made the motion to adjourn, the motion was seconded by Bill Gilbane, and the motion was carried unanimously. The meeting was adjourned at 7:53 p.m.

Approved,

Attest,

Russell Bourne, Chair

Kathi Cornelius, Deputy Town Clerk

#### STATE MANDATED STATEMENT

If a person decides to appeal any decision made by the board, agency, or Commission with respect to any matter considered at such meeting or hearing, he/she will need a record of the proceedings, and that, for such purpose, he/she may need to ensure that a verbatim record of the proceedings is made, which record includes the testimony and evidence upon which the appeal is to be based.

#### **Bill Whiteford**

-	
To:	Edward Hocevar; Russell Bourne; Brad Eavenson; Bill Gilbane; Butch Harper; Roger Siboni
Cc:	William P. Doney; Kevin Lucas; Kathi Cornelius; Ivelisse Chico-Randazzo
Subject:	JIC Permit Fee Resolution Change, Mtg. w/JIC General Contractors

From: Edward Hocevar <hocevare@jupiterinletcolony.org>

Sent: Friday, February 2, 2024 4:44 PM

**To:** Russell Bourne <russellbourne@mac.com>; Brad Eavenson <brad@efli.law>; Bill Gilbane <wgilbane@gilbaneco.com>; Butch Harper <butchharper1946@gmail.com>; Roger Siboni <rogersiboni@gmail.com>; Bill Whiteford <wcw@teamplaninc.com>

**Cc:** William P. Doney <doney@caldwellpacetti.com>; Kevin Lucas <lucask@jupiterinletcolony.org>; Kathi Cornelius <Corneliusk@jupiterinletcolony.org>; Ivelisse Chico-Randazzo <Randazzol@jupiterinletcolony.org> **Subject:** JIC Permit Fee Resolution Change, Mtg. w/JIC General Contractors

All,

Today I met with 3 of the major general contractors performing work in JIC that included Mike Armato of CEA and his associate, Dennis (John) McDonald, and Evan Anderson of Onshore. I shared with them the approach we'd like to take (ref. attached Word doc), where we front load our fee collection when the initial permit is issued based on a revised cost/sq. ft. basis. I explained that we're currently working with our accountant to make sure the revised basis and applied percentage will provide for adequate revenue to cover JIC's building support costs and allow for partial permit fee recovery with timely completion of their permitted project. This approach was generally well received; however several good points were made by the participants that also need to be considered prior to adopting any changes.

These include:

- 1. The current building terms of 12 months for residences 4000 sq.ft. or less, and 18 months for anything larger isn't realistic due to several factors including the tight confines of our roads and lots. Also, the 4000 sq. ft. requirement could entice someone to build to 4001 sq. ft. in order to increase the build term by 6 months. It was suggested that lot square footage could be a better basis for for determining term duration. Review of the attached PDF scan of all JIC lots and their sizes can be used for your consideration. On large projects that require pilings, 2 permits may have to be considered. 1 for the pilings and another for the residence. Any changes that extend the project term will not likely be well received by existing home residents so it would be wise to simultaneously propose enforcement of existing codes regarding parking, dust control, site appearance, etc. and possibly offer additional measures such as a site supervisor and traffic control.
- 2. The current practice of submitting an affidavit following construction completion for comparison to the original permit basis could unfairly penalize owners for making amenity improvements that add to the total build cost.
- 3. All builders concurred that a signed owner/builder affidavit confirming full knowledge of the permit fee schedule at the time of initial permit issue would clarify expectations and responsibilities.
- 4. Current build permits remain open beyond the original permit term provided that inspections continue.

Clearly a single resolution change will not be sufficient to address all the necessary changes as we will also need to revise our current building ordinances. My goal is to add this topic for discussion only at the Feb 12 commission meeting, but to follow up with the first reading of a proposed ordinance change at the March commission meeting and final reading and approval in April along with the fee schedule resolution. I look forward to working with all of you prior to and at the next Feb B&Z meeting to work out an acceptable set of changes that meet this goal timeline.

Ed Hocevar

#### RESOLUTION NO.

A RESOLUTION OF THE TOWN COMMISSION OF THE TOWN OF JUPITER INLET COLONY, FLORIDA, AMENDING ITS SCHEDULE OF PERMIT FEES IN ACCORDANCE WITH SECTION 4-1.1 OF THE CODE OF ORDINANCES TO ADOPT AND ESTABLISH A NEW SCHEDULE OF PERMIT FEES; PROVIDING A CONFLICTS CLAUSE, A SEVERABILITY CLAUSE, AN EFFECTIVE DATE; AND FOR OTHER PURPOSES.

WHEREAS, Section 4-1.1 of the Code of Ordinances, Town of Jupiter Inlet Colony,

Florida, provides that permit fees shall be established by Resolution duly adopted by the Town

Commission; and

WHEREAS, the Town Commission hereby desires to adopt and establish a schedule of

permit fees as set forth below.

NOW, THEREFORE, BE IT RESOLVED BY THE TOWN COMMISSION OF THE

TOWN OF JUPITER INLET COLONY, FLORIDA, that:

SECTION 1: Permit fees are hereby adopted and established pursuant to the following

schedule:

(a) Building Permit Fees:

Amount is based on contract or the fair and reasonable construction value of the proposed work to be accomplished in the Town subject to adjustment as set forth in Section 4-10(d) of the Town's Code of Ordinances. For purposes of the issuance of a building permit for new construction, the construction value shall initially be estimated at the greater of (i) \$3650.00/ square foot of total floor area as defined in Appendix A-Zoning Code or (ii) the contract amount for the new construction work to be completed under such building permit. For purposes of the issuance of a building permit for a major remodel or re-build (requiring a 12-month building permit), the construction value shall initially be estimated at the greater of (i) \$3450.00/square foot of existing floor area for proposed new floor area and \$4250.00/square foot of existing floor area for proposed renovation, or (ii) the contract amount for re-build construction work to be completed under such building permit.

AMOUNT	<u>FEE</u>
Up to \$2,000.00	\$60.00
Above \$2,000.00	3.0%

In order to encourage the timely and expeditious completion of construction projects, in the event an owner or contractor completes construction during the term of the initial building permit, <u>%</u> of the initial permit fee shall be refunded to the owner or contractor. In the event the owner or contractor completes construction within the term of the 1<sup>st</sup> renewal permit, <u>%</u> of the initial permit fee will be refunded to the owner or contractor. The owner or contractor will be entitled to no refund of a portion of the initial permit fee in the event construction is not completed during the term of the initial building permit or the 1<sup>st</sup> renewal permit, if applicable. For purposes of this Section, completion of construction shall be the issuance of a certificate of occupancy for new construction or a certificate of completion for a major remodel or re-build.

- (b) Moving building: \$1,000.00
  (c) Demolition: \$350.00 minimum, or 3% of cost of demolition, whichever is greater
- (d) Structural Pest Control: \$50.00
- (e) A new construction plan review fee of \$400.00 is required for all new construction projects. The fee is non-refundable and is not credited to the permit fee at the time of permit issuance.

(g) Re-inspection Fee(s):	
First Re-inspection:	\$ 50.00
Second Re-inspection:	\$100.00
Third & Subsequent Re-inspection(s):	\$150.00

- (h) Additional Plan Review Fee(s): A fee of \$75.00 per hour shall be charged for all plan review(s) subsequent to the initial new construction plan review.
- (i) Inspection Fee(s) for inspections on non-scheduled days: Regular inspections will be performed only on Tuesday and Thursday between the hours of 8:00 A.M. and 4:00 P.M. In the event an inspection is requested to be performed at other times, a surcharge of \$300.00 shall be due for each such inspection performed.
- (j) Renewal Permit Fee(s): (To be charged in the event of the expiration of an initial or renewal permit due to non-completion of work)

1) $1^{st}$ Renewal (6 month term)	<del>3%</del> <u>\$100.00</u>
2) 2 <sup>nd</sup> Renewal (6 month term)	<del>3%</del> <u>\$100.00</u>
3) 3 <sup>rd</sup> Renewal (term based on square footage)	3.0% of cost of remaining
Full Re-submittal required	construction
4) Additional Renewals (6 month term)	<del>3%</del> <u>\$100.00</u>

- (k) Zoning Review Fee: A zoning review fee in the amount of \$500.00 shall be required on all submittals of plans for a building permit that require review by the Building and Zoning Committee.
- Zoning Variance Fee: A zoning variance fee in the amount of \$2500.00 plus administrative (mailing and publication) costs shall be required on all applications for a variance from the provisions of the Zoning Code. A deposit of \$2500.00 shall be paid at time of application and all administrative costs must be paid prior to the public hearing before the Town Commission.
- (m) Zoning Waiver Fee: A zoning waiver fee in the amount of \$125.00 shall be required on all applications for a waiver from the provisions of the Zoning Code.

SECTION 2: All resolutions or parts of resolutions in conflict herewith be and the same are hereby repealed.

<u>SECTION 3</u>: Should any section or provision of this Resolution or any portion thereof be declared by a court of competent jurisdiction to be invalid, such decision shall not affect the remainder of this Resolution.

<u>SECTION 4</u>: This Resolution shall become effective on adoption.

PASSED AND ADOPTED this \_\_\_\_\_ day of \_\_\_\_\_, 2024.

### TOWN OF JUPITER INLET COLONY, FLORIDA

Mayor Ed Hocevar

Vice-Mayor Mark Ciarfella

Commissioner William "Bill" Muir

Commissioner Marie Rosner

Commissioner Sharon Seagren

ATTEST:

Town Clerk, Ivelisse Chico-Randazzo

#### ORDINANCE NO. 2024-\_\_\_\_

AN ORDINANCE OF THE TOWN COMMISSION OF THE TOWN OF JUPITER INLET COLONY, FLORIDA, AMENDING CHAPTER 4 BUILDING AND BUILDING REGULATIONS, SECTION 4-2. TERM OF BUILDING PERMITS; FILL, REMOVAL OR REGRADING PLANS REQUIRED; PLOT PLAN, MAXIMUM HEIGHT CERTIFICATION REQUIRED, SUBSECTION (A) OF THE CODE OF ORDINANCES OF THE TOWN OF JUPITER INLET COLONY IN ORDER TO AMEND THE TERM OF BUILDING PERMITS FOR NEW CONSTRUCTION; PROVIDING AUTHORITY TO CODIFY; PROVIDING A CONFLICTS CLAUSE, A SEVERABILITY CLAUSE AND AN EFFECTIVE DATE; AND FOR OTHER PURPOSES

NOW, THEREFORE, BE IT ENACTED BY THE TOWN COMMISSION OF THE TOWN OF JUPITER INLET COLONY, FLORIDA, AS FOLLOWS:

SECTION 1. Chapter 4 BUILDING AND BUILDING REGULATIONS, Section 4-2.

*Term of building permits; fill, removal or regrading plans required; plot plan, maximum height certification required,* Subsection (a) of the Code of Ordinances of the Town of Jupiter Inlet Colony, Florida is hereby amended to read as follows:

### Sec. 4-2. Term of building permits; fill, removal or regrading plans required; plot plan, maximum height certification required.

- (a) The term of a building permit for construction authorized by the town shall be as follows:
  - (1) Three-month term for change out or replacement of systems or improvements such as air conditioning, water heater, decks, walkways, beach cross-over, roofs, and driveways.
  - (2) Six-month term for seawalls, docks, or rip rap installations or repairs and for minor remodel work such as bathroom, kitchen, laundry and pool area remodeling.
  - (3) Twelve-month term for major remodel or construction such as changing the footprint or the exterior walls of a structure; replacing the roof structure and/or elevation where a certificate of completion is to be issued.
  - (4) The term of a permit for new construction of structures including garages, out buildings, and landscaping shall be as follows:
    - a. New residences with four thousand (4,000) square feet or less under air—Twelve (12) Fifteen (15) months.

- b. New residences with greater than four thousand (4,000) square feet under air—Eighteen (18) Twenty (20) months.
- (5) A permit may be renewed or extended two (2) times for a term of six (6) months for each renewal upon payment of the fee as established by resolution. In the event a third renewal or extension permit is necessary in order to complete construction, a full re-submittal of building plans shall be required which shall include, at a minimum:
  - a. The submittal of a new building permit application, modification of existing construction plans and documents in accordance with the current version of the Florida Building Code in effect at the time of the re-submittal and payment of all fees.
  - b. Full re-submittal includes reevaluation and reappraisal of all construction costs and estimates based on the full value of the work necessary to complete the project.
  - c. A stop work order will be placed on the project until all updated plans and documents are submitted, reviewed and approved by the building official, all fees are paid and the project has been reviewed by the building and zoning committee. Applicants are encouraged to initiate the building and zoning review process with the town in sufficient time to ensure no lapse in construction activity.
  - d. The term of a third renewal permit shall be based on the square footage of the residence at the time of re-submittal.
- (6) Each application for new construction or a major remodel shall include a construction schedule in written or chart format. At a minimum, the construction schedule shall include critical dates, milestones, and inspections from the start of the project until its completion. The construction schedule shall be subject to review and approval by the building and zoning committee. Minor modifications to the schedule (a total of thirty (30) days or less) may be made by the planning and zoning administrator during the course of construction due to emergencies or unforeseen circumstances.

<u>SECTION 2.</u> Chapter 4 BUILDING AND BUILDING REGULATIONS, Section 4-2. Term of building permits; fill, removal or regrading plans required; plot plan, maximum height certification required, Subsections (b) through (e) inclusive are unchanged and shall remain in full force and effect as previously enacted.

<u>SECTION 3.</u> Specific authority is hereby granted to codify and incorporate this Ordinance into the existing Code of Ordinances of the Town of Jupiter Inlet Colony, Florida.

<u>SECTION 4.</u> If any clause, section or other part of this Ordinance shall be held by any court of competent jurisdiction to be unconstitutional or invalid, such unconstitutional or invalid

part shall be considered as eliminated and in no way affecting the validity of the other provisions of this Ordinance.

<u>SECTION 5.</u> That all ordinances or parts or ordinances, resolutions or parts of resolutions in conflict hereby, be and the same are hereby repealed to the extent of such conflict.

<u>SECTION 6.</u> This Ordinance shall become effective immediately upon passage and shall apply to all building permits issued after said effective date.

FIRST READING this \_\_\_\_\_ day of \_\_\_\_\_, 2024.

SECOND READING and FINAL PASSAGE this \_\_\_\_\_ day of \_\_\_\_\_\_, 2024.

#### TOWN OF JUPITER INLET COLONY, FLORIDA

Mayor Ed Hocevar

Vice Mayor Mark Ciarfella

Commissioner William "Bill" Muir

Commissioner Marie Rosner

Town Clerk

Commissioner Sharon Seagren

ATTEST:

### PERMIT AND INSPECTION UTILIZATION REPORT

#### Direct costs incurred by the local government to enforce the Florida Building Code

Department budget: \$3,389,073.00

Operating expenses: \$2,042,095.00

Balance carried forward 2019: \$47,708.00

Balance carried forward 2020: \$1,346,977.51

#### PERMIT AND INSPECTION UTILIZATION INFORMATION

Number of permit applications submitted: 1209

Number of permits approved: 1110

Number of inspections requested: 3056

Number of inspections performed: 3056

Lot #	Parcel Number	Owner Address	GIS Acreage	Sq. Ft.
1	32434030080001973	1 COLONY RD	0.17	7,405
2	32434031010000010	1 OCEAN DR	0.39	16,988
3	3243403101000020	2 OCEAN DR	0.39	16,988
5	3243403101000030	3 OCEAN DR	0.80	34,848
6	32434031010000050	5 OCEAN DR	0.39	16,988
7	3243403101000060	6 OCEAN DR	0.39	16,988
8	32434031010000070	7 OCEAN DR	0.39	16,988
9	3243403101000080	8 OCEAN DR	0.46	20,038
10	3243403101000090	9 OCEAN DR	0.46	20,038
11	32434031010000100	10 OCEAN DR	0.46	20,038
12	32434031010000111	11 OCEAN DR	0.43	18,731
13	32434031010000112	12 OCEAN DR	0.48	20,909
	32434031010000130	13 OCEAN DR	0.46	20,038
14	32434031010000140	14 OCEAN DR	0.46	20,038
15	32434031010000150	15 OCEAN DR	0.46	20,038
16	32434031010000160	16 OCEAN DR	0.48	20,038
17	32434031010000170	17 OCEAN DR	0.46	20,009
18	32434031010000180	18 OCEAN DR	0.46	20,038
19	32434031010000190	19 OCEAN DR	0.46	20,038
20	32434031010000200	20 OCEAN DR	0.46	20,038
21 22	32434031010000210	21 OCEAN DR	0.46	20,038
	32434031010000220	22 OCEAN DR	0.46	20,038
23	32434031010000230	23 OCEAN DR	0.46	20,038
24	32434031010000240	24 OCEAN DR	0.46	20,038
25	32434031010000250	25 OCEAN DR	0.22	9,583
26	32434031010000260	26 OCEAN DR	0.21	9,148
27 28	32434031010000270	27 OCEAN DR	0.21	9,148
28	32434031010000280	28 OCEAN DR	0.21	9,148
29 31	32434031010000290	29 OCEAN DR	0.41	17,860
32	32434031010000310	31 OCEAN DR	0.21	9,148
33	32434031010000320	32 OCEAN DR	0.21	9,148
33 34	32434031010000330	33 OCEAN DR	0.22	9,583
	32434031010000340	34 OCEAN DR	0.22	9,583
85	32434031010000350	35 OCEAN DR	0.21	9,148
6	32434031010000360	36 OCEAN DR	0.21	9,148
7	32434031010000370	37 OCEAN DR	0.21	9,148
8	32434031010000380	38 OCEAN DR	0.21	9,148
9	32434031010000390	39 OCEAN DR	0.21	9,148
0	32434031010000400	40 OCEAN DR	0.21	9,148
1	32434031010000410	41 OCEAN DR	0.21	9,148
2	32434031010000420	42 OCEAN DR	0.21	9,148
3	32434031010000430	43 OCEAN DR	0.21	9,148
4	32434031010000440	44 OCEAN DR	0.19	9,148 8,276
5	32434031010000450	45 OCEAN DR	0.19	8,276
6	32434031010000460	46 OCEAN DR	0.19	8,276
7	32434031010000470	47 OCEAN DR	0.19	8,276
3	32434031010000480	48 OCEAN DR	0.25	10,890
)	32434031010000490	49 OCEAN DR	0.24	10,850
2	32434031010000500	50 COLONY RD	0.23	10,454
	32434031010000510	51 COLONY RD	0.25	
2	32434031010000520	52 COLONY RD	0.19	10,890
	32434031010000530	53 COLONY RD	0.39	8,276
	32434031010000550	55 COLONY RD	0.19	16,988
	32434031010000560	56 COLONY RD	0.19	8,276

:

•

Lot #	Parcel Number	Owner Address	GIS Acreage	Sq. Ft.
	32434031010000570	57 COLONY RD	0.21	9,148
58	32434031010000580	58 COLONY RD	0.21	9,148
59	32434031010000590	59 COLONY RD	0.21	9,148
60	32434031010000600	60 COLONY RD	0.21	9,148
61	32434031010000610	61 COLONY RD	0.21	9,148
62	32434031010000620	62 COLONY RD	0.21	9,148
63	32434031010000630	63 COLONY RD	0.21	9,148
64	32434031010000640	64 COLONY RD	0.21	9,148
65	32434031010000650	65 COLONY RD	0.22	9,583
66	32434031010000660	66 COLONY RD	0.22	9,583
67	32434031010000670	67 COLONY RD	0.21	9,148
68	32434031010000680	68 COLONY RD	0.21	9,148
69	32434031010000690	69 COLONY RD	0.21	9,148
70	32434031010000700	70 COLONY RD	0.31	13,504
72	32434031010000711	72 COLONY RD	0.31	13,504
73	32434031010000730	73 COLONY RD	0.43	18,731
75	32434031010000750	75 LIGHTHOUSE DR	0.41	17,860
76	32434031010000760	76 LIGHTHOUSE DR	0.40	17,424
77	32434031010000770	77 LIGHTHOUSE DR	0.38	16,553
78	32434031010000780	78 LIGHTHOUSE DR	0.33	14,375
79	32434031010000790	79 LIGHTHOUSE DR	0.32	13,939
80	32434031010000800	80 LIGHTHOUSE DR	0.36	15,682
81	32434031010000811	81 LIGHTHOUSE DR	0.38	16,553
82	32434031010000812	82 LIGHTHOUSE DR	0.36	15,682
83	32434031010000821	83 LIGHTHOUSE DR	0.33	14,375
84	32434031010000840	84 LIGHTHOUSE DR	0.35	15,246
85	32434031010000850	85 LIGHTHOUSE DR	0.44	19,166
86	32434031010000860	86 LIGHTHOUSE DR	0.47	20,473
87	32434031010000870	87 LIGHTHOUSE DR	0.44	19,166
88	32434031010000880	88 LIGHTHOUSE DR	0.50	21,780
89	32434031010000890	89 LIGHTHOUSE DR	0.62	27,007
90	32434031010000900	90 LIGHTHOUSE DR	0.79	34,412
91	32434031010000910	91 LIGHTHOUSE DR	0.83	36,155
92	32434031010000920	92 LIGHTHOUSE DR	0.62	27,007
93	32434031010000930	93 LIGHTHOUSE DR	0.51	22,216
94	32434031010000940	94 LIGHTHOUSE DR	0.48	
95	32434031010000950	95 LIGHTHOUSE DR	0.46	20,909
96	32434031010000960	96 LIGHTHOUSE DR	0.40	20,038
97	32434031010000970	97 LIGHTHOUSE DR	0.43	18,731
98	32434031010000980	98 LIGHTHOUSE DR	0.41	17,860
99	32434031010000990	99 LIGHTHOUSE DR	0.39	
100	32434031010001000	100 LIGHTHOUSE DR	0.38	<u>    16,988  </u> 16,553
101	32434031010001010	101 LIGHTHOUSE DR	0.36	
102	32434031010001020	102 LIGHTHOUSE DR	0.38	15,682
103	32434031010001030	103 LIGHTHOUSE DR	0.36	16,553
104	32434031010001040	104 LIGHTHOUSE DR	0.35	15,682
105	32434031010001050	105 LIGHTHOUSE DR	0.35	15,246
106	32434031010001060	106 LIGHTHOUSE DR	0.32	14,810
107	32434031010001070	107 LIGHTHOUSE DR	0.32	13,939
108	32434031010001080	108 LIGHTHOUSE DR		12,197
109	32434031010001090	109 LIGHTHOUSE DR	0.26	11,326
110	32434031010001100	110 LIGHTHOUSE DR	0.26	11,326
111	32434031010001110	111 LIGHTHOUSE DR	0.24	10,454
112	32434031010001120	112 LIGHTHOUSE DR	0.22	9,583
	02-10-100 10 1000 1 120	LIZ LIGHTHUUSE DK	0.22	9,583

Lot #	T alloot itallipol	Owner Address	GIS Acreage	Sq. Ft.
113	32434031010001130	113 LIGHTHOUSE DR	0.22	9,583
114	32434031010001140	114 LIGHTHOUSE DR	0.22	9,583
115	32434031010001150	115 LIGHTHOUSE DR	0.22	9,583
116	32434031010001160	116 LIGHTHOUSE DR	0.22	9,583
	32434031010001170	117 LIGHTHOUSE DR	0.22	9,583
118	32434031010001180	118 LIGHTHOUSE DR	0.22	9,583
119	32434031010001190	119 LIGHTHOUSE DR	0.22	9,583
120	32434031010001200	<b>120 LIGHTHOUSE DR</b>	0.22	9,583
121	32434031010001210	121 LIGHTHOUSE DR	0.22	9,583
	32434031010001220	122 LIGHTHOUSE DR	0.22	9,583
123	32434031010001230	123 LIGHTHOUSE DR	0.24	10,454
124	32434031010001240	124 LIGHTHOUSE DR	0.26	11,326
125	32434031010001250	125 LIGHTHOUSE DR	0.27	11,761
126	32434031010001260	126 LIGHTHOUSE DR	0.27	11,761
127	32434031010001270	127 LIGHTHOUSE DR	0.27	11,761
128	32434031010001280	128 LIGHTHOUSE DR	0.27	11,761
129	32434031010001290	129 LIGHTHOUSE DR	0.24	10,454
130	32434031010001300	130 LIGHTHOUSE DR	0.24	10,454
131	32434031010001310	131 LIGHTHOUSE DR	0.24	10,454
132	32434031010001320	132 LIGHTHOUSE DR	0.26	11,326
133 134	32434031010001330	133 LIGHTHOUSE DR	0.26	11,326
134	32434031010001340	134 LIGHTHOUSE DR	0.25	10,890
	32434031010001350	135 LIGHTHOUSE DR	0.25	10,890
136 137	32434031010001360	136 LIGHTHOUSE DR	0.23	10,019
137	32434031010001370	137 COLONY RD	0.25	10,890
138	32434031010001380	138 BEACON LN	0.48	20,909
139	32434031010001390	139 BEACON LN	0.26	11,326
140	32434031010001400 32434031010001410	140 BEACON LN	0.25	10,890
141	32434031010001410	141 BEACON LN	0.26	11,326
142	32434031010001420	142 BEACON LN	0.26	11,326
143	32434031010001430	143 BEACON LN	0.24	10,454
145	32434031010001440	144 BEACON LN	0.24	10,454
146	32434031010001450	145 BEACON LN	0.27	11,761
147	32434031010001470	146 BEACON LN	0.30	13,068
148	32434031010001481	147 BEACON LN	0.30	13,068
149	32434031010001490	148 BEACON LN	0.26	11,326
150	32434031010001500	149 BEACON LN 150 BEACON LN	0.24	10,454
151	32434031010001510	150 BEACON LN 151 BEACON LN	0.22	9,583
152	32434031010001520	151 BEACON LN 152 BEACON LN	0.22	9,583
153	32434031010001530	152 BEACON LN	0.22	9,583
154	32434031010001540	154 BEACON LN	0.22	9,583
155	32434031010001550	155 BEACON LN	0.22	9,583
156	32434031010001560	156 BEACON LN	0.22	9,583
157	32434031010001570	157 BEACON LN	0.22	9,583
158	32434031010001580	158 BEACON LN	0.22	9,583
159	32434031010001590	159 BEACON LN	0.22	9,583
160	32434031010001600	160 BEACON LN	0.22	9,583
161	32434031010001610	161 BEACON LN	0.22	9,583
162	32434031010001620	162 BEACON LN	0.22	9,583
163	32434031010001630	163 BEACON LN	0.24	10,454
164	32434031010001640	164 LIGHTHOUSE DR	0.26	11,326
165	32434031010001650	165 BEACON LN	0.26	11,326
166	32434031010001660	166 BEACON LN	0.24	10,454
			U.24	10,454

•

•

Lot #	Parcel Number	Owner Address	GIS Acreage	Sq. Ft.
167	32434031010001670	167 BEACON LN	0.22	9,58
168	32434031010001680	168 BEACON LN	0.20	8,71
169	32434031010001690	169 BEACON LN	0.20	8,712
170	32434031010001700	170 BEACON LN	0.21	9,148
171	32434031010001710	171 BEACON LN	0.20	8,712
172	32434031010001720	172 BEACON LN	0.20	8,712
173	32434031010001730	173 BEACON LN	0.20	8,712
174	32434031010001740	174 BEACON LN	0.20	8,712
175	32434031010001750	175 BEACON LN	0.20	8,712
176	32434031010001760	176 BEACON LN	0.20	8,712
177	32434031010001770	177 BEACON LN	0.20	8,712
178	32434031010001780	178 BEACON LN	0.20	8,712
179	32434031010001790	179 BEACON LN	0.20	8,712
180	32434031010001800	180 BEACON LN	0.22	9,583
181	32434031010001810	181 BEACON LN	0.20	8,712
182	32434031010001820	182 BEACON LN	0.18	7,841
183	32434031010001830	183 BEACON LN	0.30	13,068
184	32434031010001840	184 SHELTER LN	0.20	8,712
185	32434031010001850	185 SHELTER LN	0.22	9,583
186	32434031010001860	186 SHELTER LN	0.20	8,712
187	32434031010001870	187 SHELTER LN	0.20	8,712
188	32434031010001880	188 SHELTER LN	0.20	8,712
189	32434031010001890	189 SHELTER LN	0.20	8,712
190	32434031010001900	190 SHELTER LN	0.20	8,712
191	32434031010001910	191 SHELTER LN	0.20	8,712
192	32434031010001920	192 SHELTER LN	0.20	8,712
193	32434031010001930	193 SHELTER LN	0.20	8,712
194	32434031010001940	194 SHELTER LN	0.20	8,712
195	32434031010001951	195 SHELTER LN	0.19	8,276
196	32434031010001960	196 SHELTER LN	0.20	8,712
197	32434031010001970	197 SHELTER LN	0.20	8,712
198	32434031010001980	198 SHELTER LN	0.22	9,583
199	32434031010001990	199 SHELTER LN	0.24	10,454
200	32434031010002000	200 COLONY RD	0.21	9,148
201	32434031010002010	201 COLONY RD	0.19	8,276
202	32434031010002020	202 COLONY RD	0.23	10,019
203	32434031010002030	203 COLONY RD	0.30	13,068
204	32434031010002040	204 SHELTER LN	0.20	8,712
205	32434031010002050	205 COLONY RD	0.20	8,712
206	32434031010002060	206 COLONY RD	0.24	10,454
207	32434031010002070	207 SHELTER LN	0.24	10,454
208	32434031010002080	208 SHELTER LN	0.23	10,019
209	32434031010002090	209 TREASURE PL	0.24	10,454
210	32434031010002100	210 COLONY RD	0.18	7,841
211	32434031010002110	211 COLONY RD	0.23	10,019
212	32434031010002120	212 TREASURE PL	0.19	8,276
213	32434031010002130	213 TREASURE PL	0.19	8,276
214	32434031010002140	214 SHELTER LN	0.19	8,276
215	32434031010002150	215 PIRATES PL	0.22	9,583
216	32434031010002160	216 PIRATES PL	0.23	10,019
217	32434031010002170	217 PIRATES PL	0.23	10,019
218	32434031010002180	218 PIRATES PL	0.23	10,019
219	32434031010002190	219 COLONY RD	0.21	9,148
220	32434031010002200	220 PIRATES PL	0.21	9,148

•

•

Lot #	Parcel Number	Owner Address	GIS Acreage	Sq. Ft.
221	32434031010002210	221 PIRATES PL	0.21	
222	32434031010002220	222 PIRATES PL	0.21	9,148
223	32434031010002230	223 PIRATES PL	0.21	9,148
224	32434031010002240	224 SHELTER LN	0.23	9,148
225	32434031010002250	225 COVE PL	0.23	10,019
226	32434031010002260	226 COVE PL	0.23	10,019
227	32434031010002270	227 COVE PL	0.23	10,019
228	32434031010002280	228 COLONY RD	0.25	10,019
229	32434031010002290	229 COLONY RD	0.24	10,890
230	32434031010002300	230 COVE PL	0.22	10,454
231	32434031010002310	231 COVE PL	0.22	9,583
232	32434031010002320	232 COVE PL	0.21	9,583
233	32434031010002330	233 COVE PL	0.21	9,148
234	32434031010002340	234 SHELTER LN	0.21	9,148
235	32434031010002350	235 BEACON LN	0.22	9,583
236	32434031010002360	236 BEACON LN	0.20	8,712
237	32434031010002370	237 BEACON LN	0.23	10,019
238	32434031010002380	238 BEACON LN	0.25	10,454
239	32434031010002390	239 BEACON LN	0.25	10,890
240	32434031010002400	240 COLONY RD	0.23	10,890
241	32434031100002410	241 OCEAN DR	0.50	10,019
242	32434031100002420	242 OCEAN DR	0.50	21,780
243	32434031100002430	243 OCEAN DR	0.50	21,780
BC	32434031100002440	244 OCEAN DR	2.79	21,780
			2.13	121,532

.

ţ

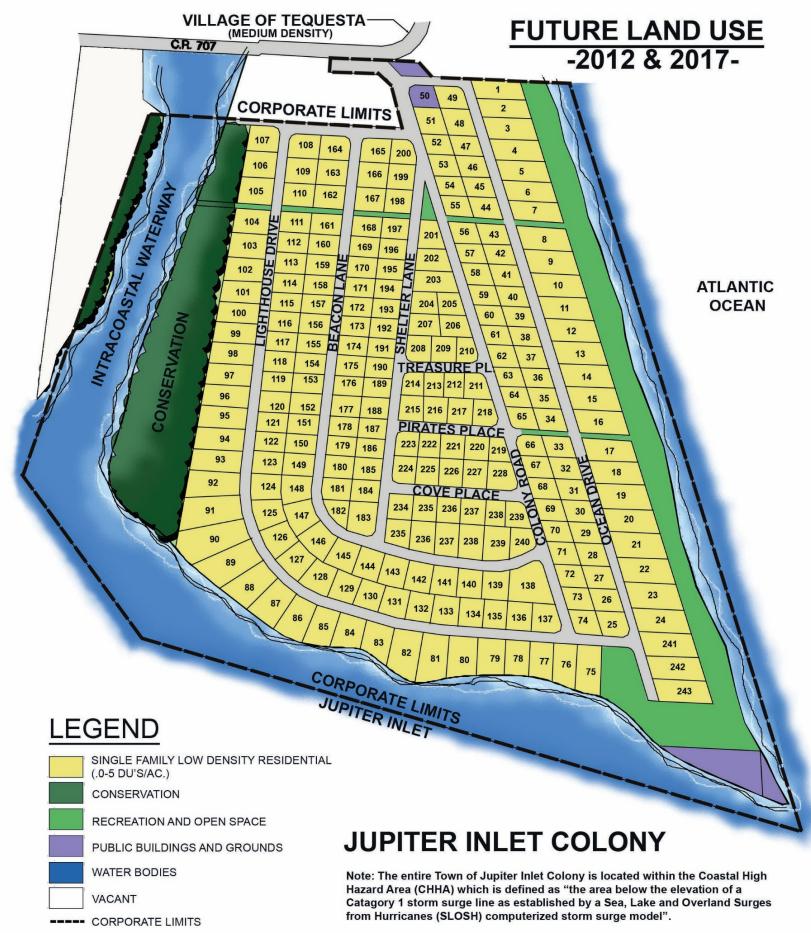


FIGURE 2 SOURCE: TOWN OF JUPITER INLET COLONY + JLH. ASSOCIATES 12/07

# 500 250 0 200 400 600



#### TOWN OF JUPITER INLET COLONY BUILDING AND ZONING COMMITTEE MEETING SEPTEMBER 21, 2023

#### WORKSHOP MINUTES

- 1. Call to Order. Earl Fischer, Chair called the workshop to order at 5:03 pm
- 2. Roll Call:

Earl Fischer (Chair), Present Russell Bourne (Vice Chair), Present Butch Harper, Present William Gilbane, on the phone Brad Eavenson, Absent Roger Siboni, Absent Bill Muir, Present Planning and Zoning Administrator: Bill Whiteford – Present

Also in attendance: Sherry Karas, 137 Colony Rd.

3. Public Comments - items not on the agenda (3 minutes).

Sherry Karas: Had a question about new builds and major renovations, do we need to bring everything up to code? Bill offered an explanation for the committee. Mrs. Karas suggested that as a community we should have it established that with new/major construction everything is brought up to code. Discussion on maintaining fences, etc. that have degraded.

- 4. Discussion Item:
  - Permit Fees and Extensions, Ordinance 2019-07 (continued from 08-17-2023)
     Bill Whiteford reviewed the Building Permit Fees and Extensions Municipal Comparison, and how to structure fees. Butch Harper asked if there is a way to eliminate the Final Cost Affidavit by requiring a higher cost per square foot when the permit application is submitted to the Town.

#### STATE MANDATED STATEMENT

If a person decides to appeal any decision made by the board, agency, or Commission with respect to any matter considered at such meeting or hearing, he/she will need a record of the proceedings, and that, for such purpose, he/she may need to ensure that a verbatim record of the proceedings is made, which record includes the testimony and evidence upon which the appeal is to be based.



Committee discussion on this, Bill Whiteford mentioned the report that the Town Accountant is producing that would show how much we are collecting and to ensure that we do not have an excessive surplus. Further discussion on fees, how the money is allocated.

The Chair, Earl Fischer led the Committee in a line-item discussion on the revisions to Resolution 2019-07 as follows:

PERMIT FEES / PERMIT EXTENSIONS - PROPOSED REVISIONS TO RESOLUTION 2019-07

- 1. PERMIT FEES Unanimous Agreement
- a. New Construction: \$650.00 per sf. Fees: 3% of construction cost.
- b. Existing Structure or Building, Exterior Remodel or Rebuild: \$450.00 per sf. Fees: 3% of construction cost.
- c. Existing Structure or Building, Interior Renovation: \$250.00 per sf. Fees: 3% of construction cost.

2. TIME TO COMPLETE CONSTRUCTION – Unanimous Agreement after discussion on changes.

- a. NEW CONSTRUCTION
  - 4,000 sf and under 12 months 15 months
  - 4,001 sf and over 18 months 20 months
- b. REMODEL OR REBUILD
  - Remodel or rebuild 12 months
- c. PERMIT EXTENSIONS
  - 1st Extension: 6 months; 3% of cost to complete work 3 months
  - 2nd Extension: 6 months; 3% of original permit 3 months
  - 3<sup>rd</sup> Extension: Full Fee Renewal; 6 months

#### STATE MANDATED STATEMENT

If a person decides to appeal any decision made by the board, agency, or Commission with respect to any matter considered at such meeting or hearing, he/she will need a record of the proceedings, and that, for such purpose, he/she may need to ensure that a verbatim record of the proceedings is made, which record includes the testimony and evidence upon which the appeal is to be based.



A MUNICIPALCORPORATION

- 3. PERMIT APPLICATIONS Unanimous Agreement after discussion on changes.
  - a. At time of application, builder shall submit a detailed construction schedule of phase and times to complete project on time. Bill Gilbane suggested a critical path measure.
  - b. Updates on construction to be monitored by the Town Building Official.
  - c. Town to notify builder/contractor of record and property owner 45 days prior to the expiration date of an active permit. Butch Harper suggested that notification be sent by registered mail.
  - d. Builder and property owner should determine in advance who is responsible for payment of all fees, including permit extension fees and change orders to the Town.
  - e. Any fees not paid prior to the expiration date of a permit will result in a Stop Work Order issued by the Town Building Official. check with Buck
  - f. No CO, temporary CO, CC, or right to occupy a building or utilize a structure shall be issued by the Town Building Official until all outstanding fees are paid to the Town. Discussion on time limit for TCO.
  - g. Homes constructed on pilings are subject to special review by the Building and Zoning Committee. Additional time to complete construction may be allotted by the Committee on a case-by-case basis.
- 4. Any Other Matters. None.
- 5. The Chair, Earl Fischer, called for a Motion to Adjourn. Butch Harper moved to adjourn, motion was seconded by Bill Muir, motion carried unanimously 5-0, and the meeting adjourned at 6:17 p.m.

Approved,


Attest,

Earl Fischer, Chair

Kathi Cornelius, Deputy Town Clerk

#### STATE MANDATED STATEMENT

If a person decides to appeal any decision made by the board, agency, or Commission with respect to any matter considered at such meeting or hearing, he/she will need a record of the proceedings, and that, for such purpose, he/she may need to ensure that a verbatim record of the proceedings is made, which record includes the testimony and evidence upon which the appeal is to be based.

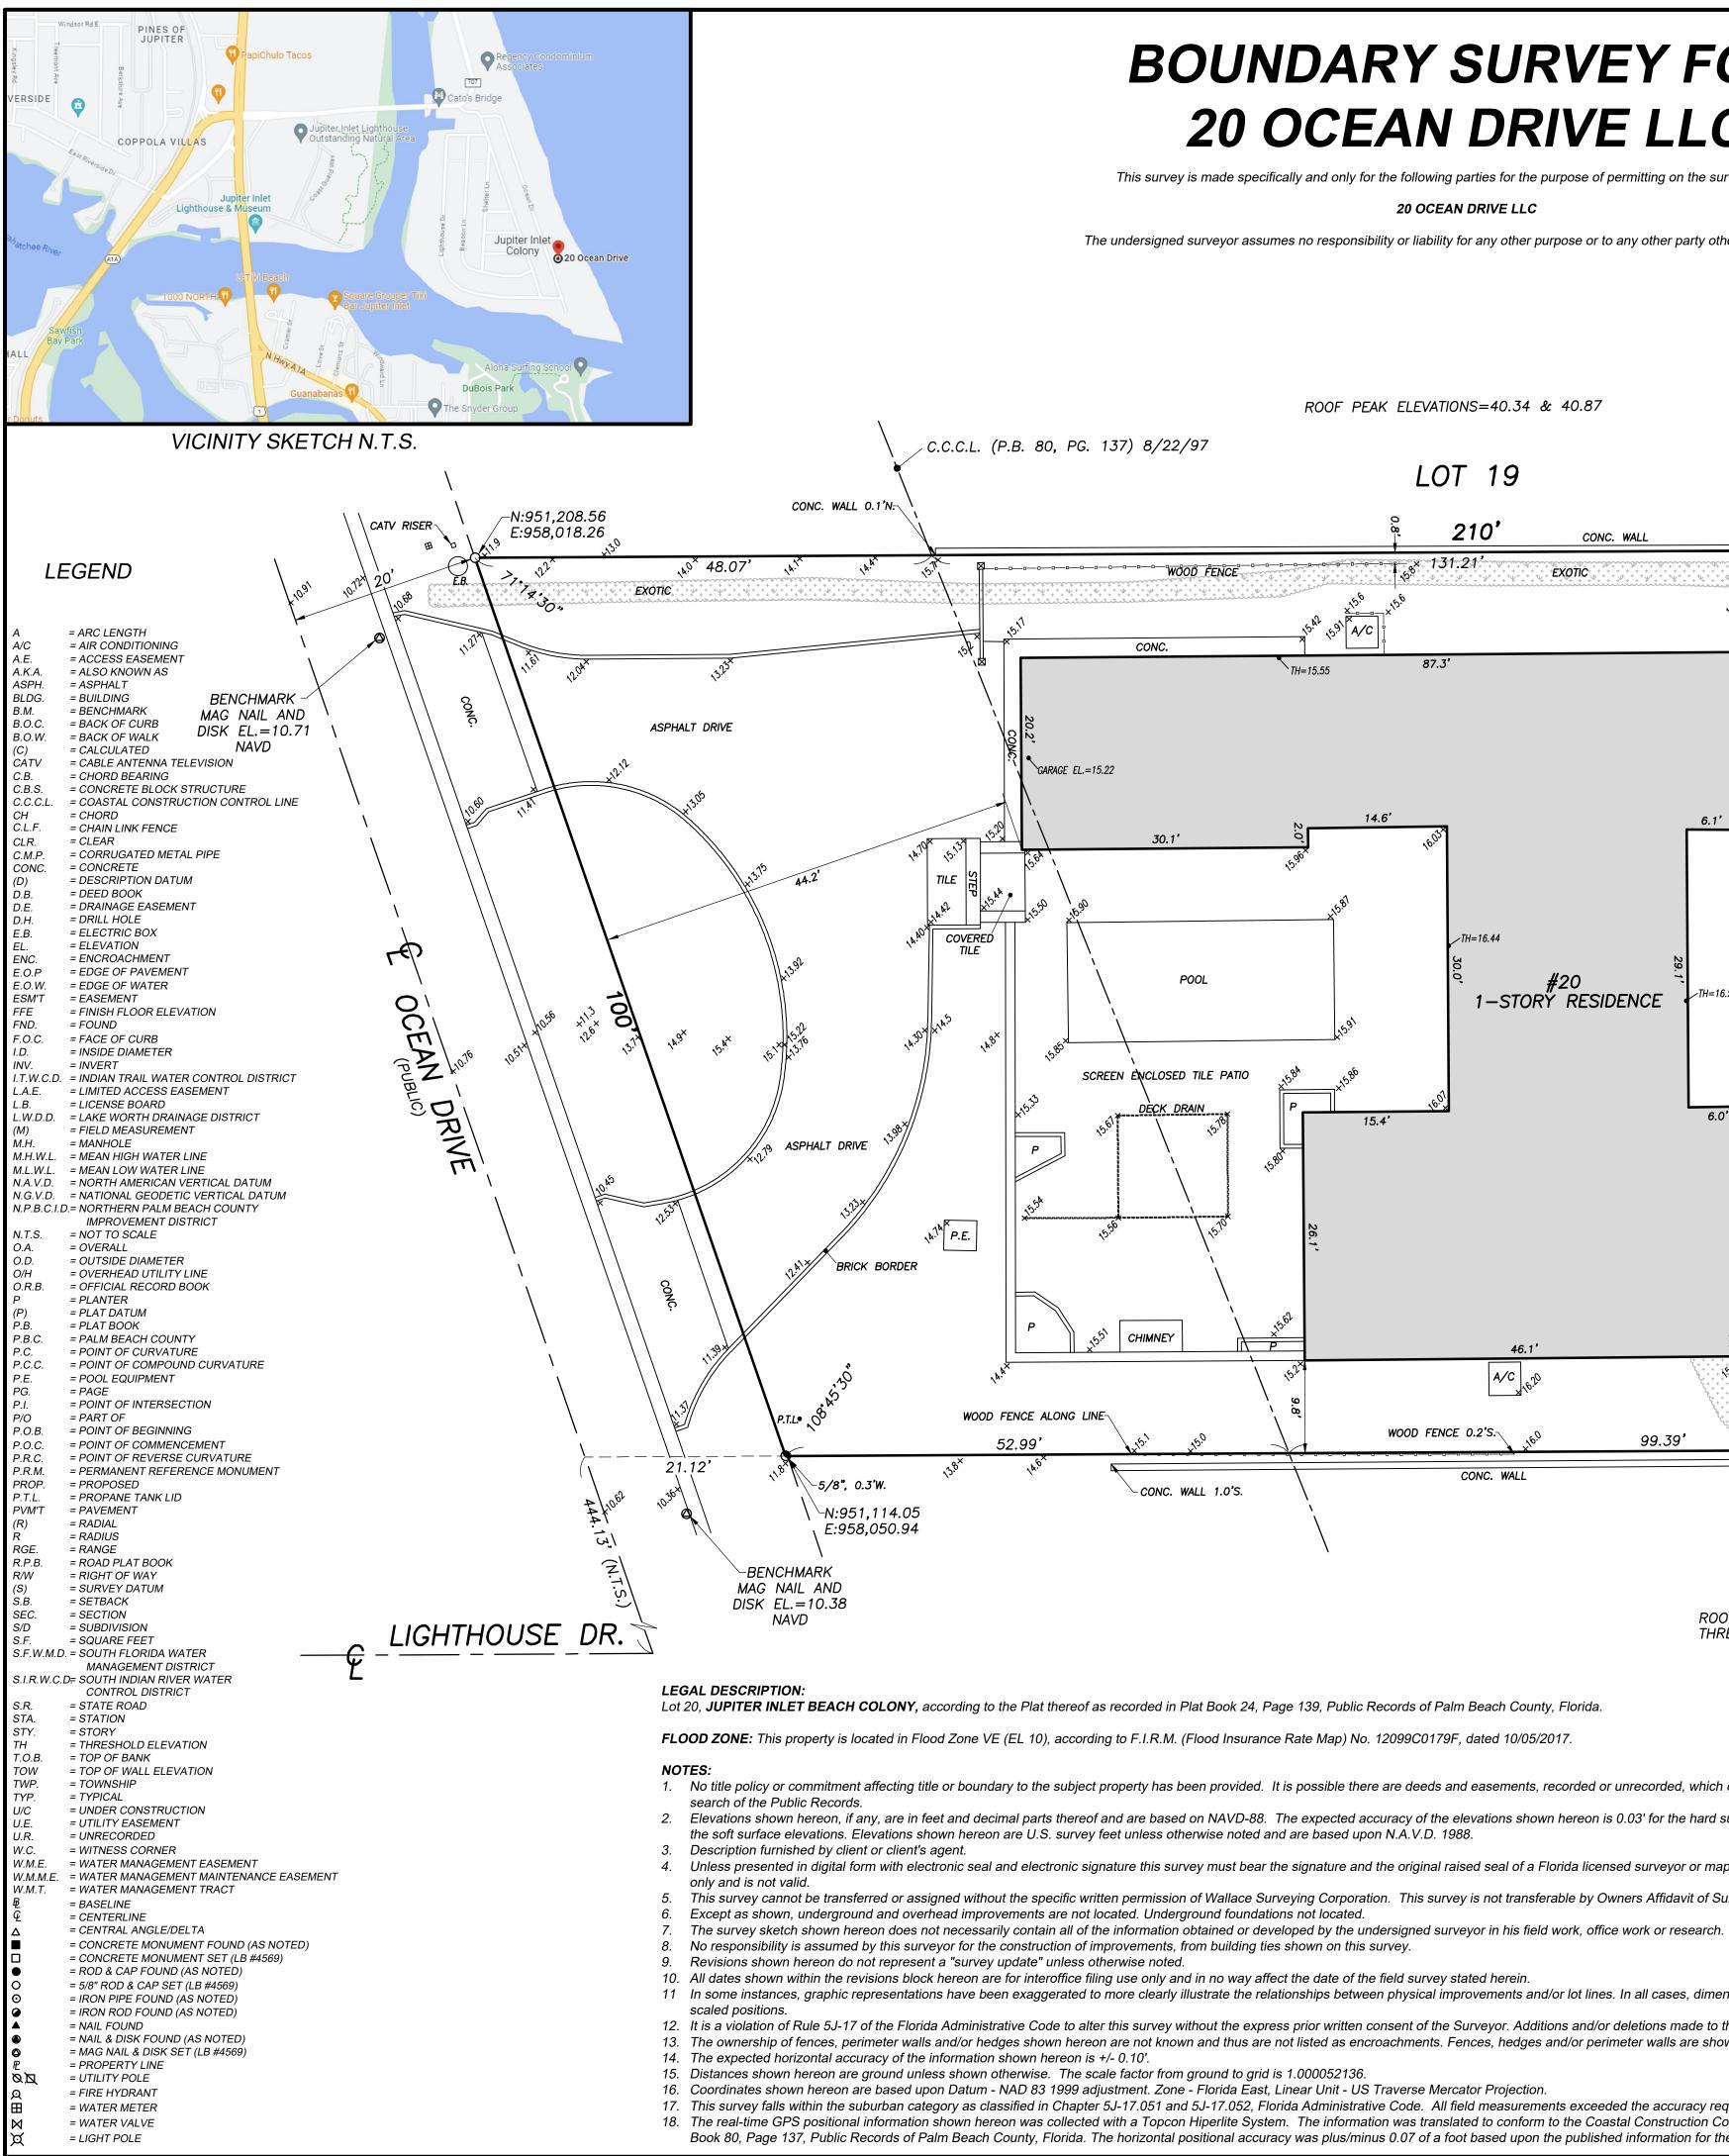

# **BOUNDARY SURVEY FOR:** 20 OCEAN DRIVE LLC

This survey is made specifically and only for the following parties for the purpose of permitting on the surveyed property.

20 OCEAN DRIVE LLC

The undersigned surveyor assumes no responsibility or liability for any other purpose or to any other party other than stated above.

ROOF PEAK ELEVATIONS=40.34 & 40.87

LOT 19 CONC. WALL 0.1' 210' CONC. WALL WOOD FENCE EXOTIC EXOTIC CONC. 87.3 TH=15 55 CANTILEVER GARAGE EL.=15.22 30.1 TH=16.44 COVERED TILE P00 #20 1–STORY RESIDENCE TH=16.51 GRASS SCREEN ENCLOSED TILE PATIO LOT 20 11.3' 19,884 S.F. CANTILEVER 11.8' CHIMNEY \_\_\_\_\_P 46.1' A/C n EXOTIC EXOTIC WOOD FENCE 0.2'S.~ 99.39**'** CONC. WALL 210' WALL CORNER ALONG LINE~ CONC. WALL 1.0'S. BRICK WALL LOT 21

> ROOF PEAK EL.=42.59 THRESHOLD EL.=18.11

FLOOD ZONE: This property is located in Flood Zone VE (EL 10), according to F.I.R.M. (Flood Insurance Rate Map) No. 12099C0179F, dated 10/05/2017.

1. No title policy or commitment affecting title or boundary to the subject property has been provided. It is possible there are deeds and easements, recorded or unrecorded, which could affect this survey and boundaries. This office has made no

2. Elevations shown hereon, if any, are in feet and decimal parts thereof and are based on NAVD-88. The expected accuracy of the elevations shown hereon is 0.03' for the hard surface elevations (shown thus x 0.00) and 0.1' (shown thus x 0.0) for the soft surface elevations. Elevations shown hereon are U.S. survey feet unless otherwise noted and are based upon N.A.V.D. 1988.

4. Unless presented in digital form with electronic seal and electronic signature this survey must bear the signature and the original raised seal of a Florida licensed surveyor or mapper this drawing, sketch, plat or map is for informational purposes

5. This survey cannot be transferred or assigned without the specific written permission of Wallace Surveying Corporation. This survey is not transferable by Owners Affidavit of Survey or similar instrument.

11 In some instances, graphic representations have been exaggerated to more clearly illustrate the relationships between physical improvements and/or lot lines. In all cases, dimensions shown shall control the location of the improvements over

12. It is a violation of Rule 5J-17 of the Florida Administrative Code to alter this survey without the express prior written consent of the Surveyor. Additions and/or deletions made to the face of this survey will make this survey invalid. 13. The ownership of fences, perimeter walls and/or hedges shown hereon are not known and thus are not listed as encroachments. Fences, hedges and/or perimeter walls are shown in their relative position to the boundary.


16. Coordinates shown hereon are based upon Datum - NAD 83 1999 adjustment. Zone - Florida East, Linear Unit - US Traverse Mercator Projection.

17. This survey falls within the suburban category as classified in Chapter 5J-17.051 and 5J-17.052, Florida Administrative Code. All field measurements exceeded the accuracy requirements for this classification.

18. The real-time GPS positional information shown hereon was collected with a Topcon Hiperlite System. The information was translated to conform to the Coastal Construction Control Line, permanent reference monuments as recorded in Plat

Book 80, Page 137, Public Records of Palm Beach County, Florida. The horizontal positional accuracy was plus/minus 0.07 of a foot based upon the published information for the permanent reference monuments.

20 Ocean Drive Jupiter, FL 33469

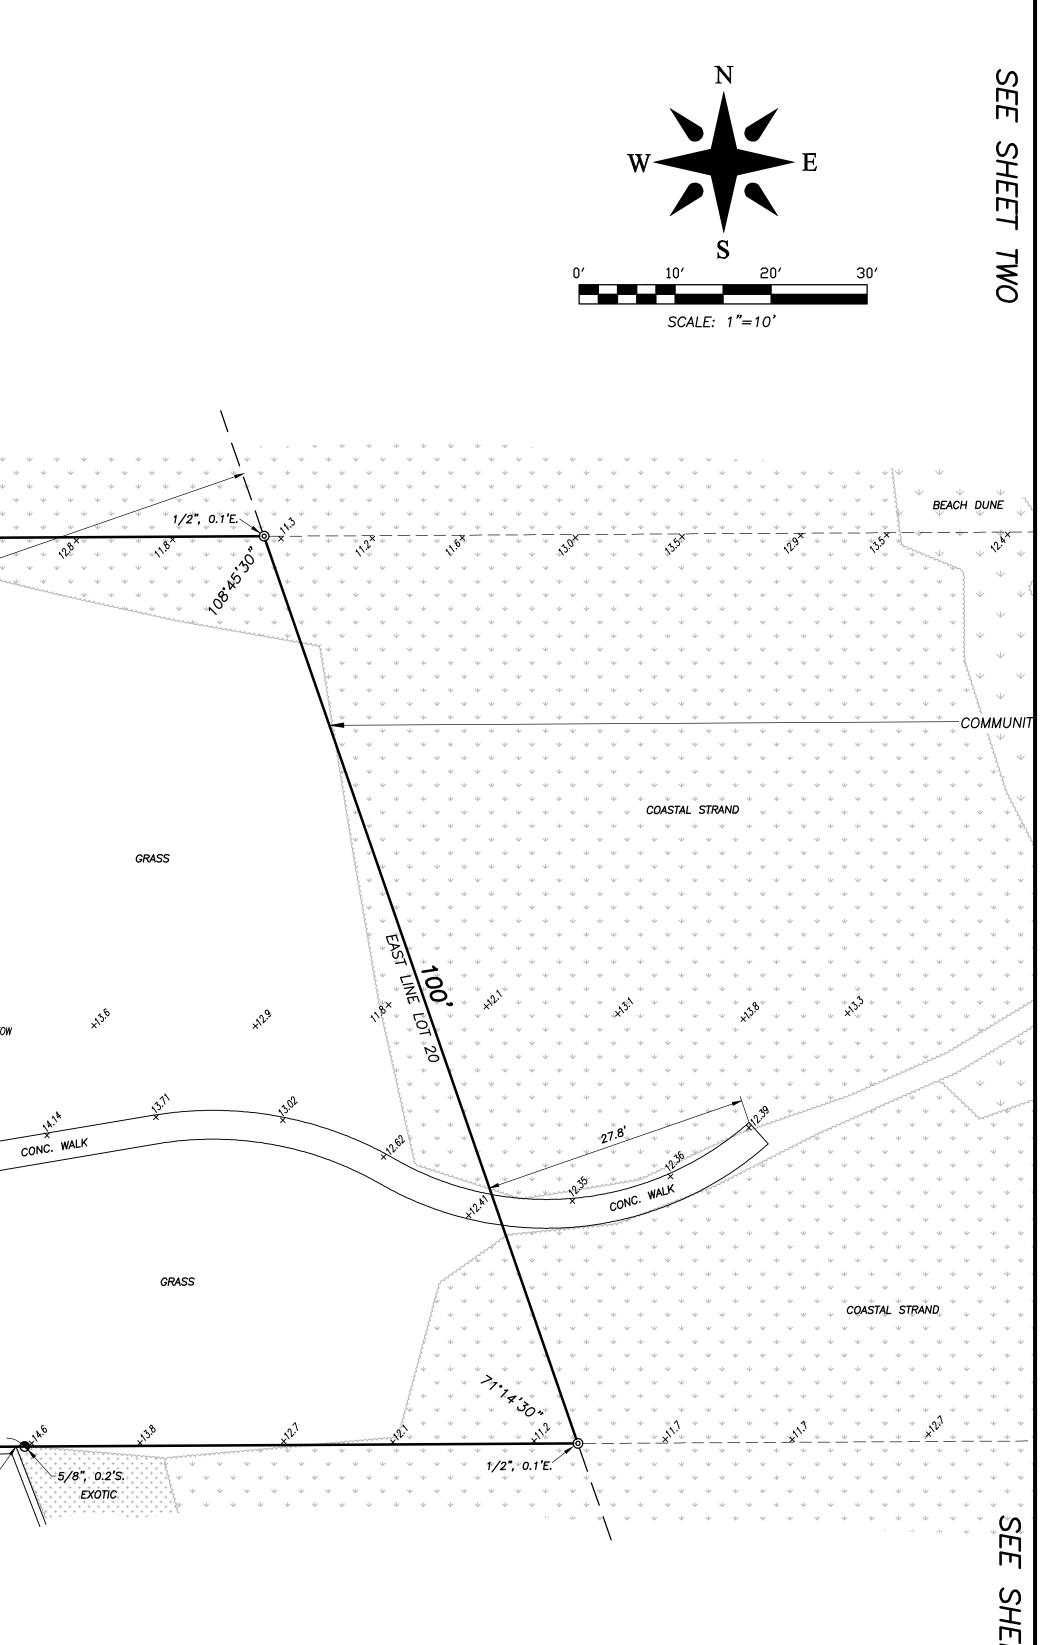

**PROPERTY ADDRESS:** 

### **CERTIFICATION:**

**I HEREBY ATTEST** that the survey shown hereon conforms to the Standards of Practice set forth by the Florida Board of Professional Surveyors and Mappers adopted in Rule 5J-17, Florida Administrative Code pursuant to Section 472.027, Florida Statutes, effective September 1, 1981.

DATE OF LAST FIELD SURVEY: 6/17/2023

Craig L. Wallace Professional Surveyor and Mapper Florida Certificate No. 3357


## 02/02/24 ADJACENT ROOF HEIGHTS B.M./M.B. J105/52

01/03/24 LOCATE ADJACENT RESIDENCE C.E./M.B. 23-1247.3 J105/48

### **BOUNDARY SURVEY FOR:**

## 20 OCEAN DRIVE LLC

		5553 VIL			ORP. LICENSED	<b>EVITLE</b> BUSINESS # 4569 (561) 640-4551
FIELD	В.М.		JOB NO.:	23–1247.1	F.B. J1(	06 <sup>pg.</sup> 21
OFFICE	М.В.		DATE	6/17/23	DWG. NO.	23–1247
כיא׳)	C.W.		REF: 2	23–1247.DWG	SHEET	1 <sup>of</sup> 3

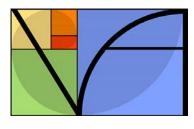

### VILLAGE ARCHITECTS AIA

#### CHRIS ANDRUS

400 N. Cypress Drive, Suite 21 Tequesta, Florida 33469 (561)743-4959 ph (561)743-1225 fax Chris.Andrus@Village-Architects.com www.Village-Architects.com

#### 3-5-24

Jupiter Inlet Colony Plan Review

Re: Resubmittal of the Aiello residence

Below is a list of plan changes and the revised sheets

#### SP1 - Site Plan

- Revised motorcourt
- Revised Summer Kitchen
- Revised pool patio
- Revise Lot coverage and square footage calculations

#### A1 – First Floor plan

- Extended the Summer Kitchen eastward approx. 8'
- Removed the stairs down to the now removed basement
- Added storage mezzanines in both garages

#### A2 – Second Floor Plan

• Extended the open balcony off of Guest Suite #2 approx 8' to match the change below to the summer kitchen

## All A-sheets from this point on have been renumbered as the previous A3 sheet with the basement has been removed

#### A3 – Roof Plan

• Extended the open balcony off of Guest Suite #2 approx 8' to match the change below to the summer kitchen

#### A4 – Front and Rear Elevations

#### **Front Elevation**

• The dashed outline of the stairs down to the basement has been removed

#### A5 – Left and Right elevations

#### Left Elevation

• The summer kitchen and open balcony above have been extended approx 8' eastward. A new upper window has been placed in the space as well.

#### **A6– Building Sections**

• The basement has been removed from sections A and B

#### A7 – Building Sections


• The summer kitchen and open balcony above have been extended approx 8' eastward.

#### A9 – Details

• The basement details have been removed from details 4/A9 and 5/A9

#### A10 – Details

• A Storage Mezzanine has been added to the garage details. Detail 10/A10 has been omitted.

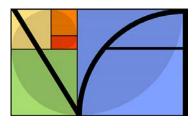

### VILLAGE ARCHITECTS AIA

#### CHRIS ANDRUS

400 N. Cypress Drive, Suite 21 Tequesta, Florida 33469 (561)743-4959 ph (561)743-1225 fax Chris.Andrus@Village-Architects.com www.Village-Architects.com

#### A11 – Details

• Summer kitchen detail 14/A11 has been modified to reflect the change to the summer kitchen and open balcony.

#### A12 – Details

• Main stair detail 16/A12 has been revised to remove the basement from the detail.

#### A13 – Details

• A new storage mezzanine has been added at garage #2

#### A14 – Details

• Stair detail 19/A14 has been revised to remove the stairs down to the basement.

#### A15 – Details

• A new storage mezzanine has been added at garage #1

#### E1 – First Floor Electrical Plan

• Extended the Summer Kitchen eastward approx. 8' and reconfigured the lighting in the summer kitchen.

#### E2 – Second Floor Electrical Plan

• Extended the open balcony off of Guest Suite #2 approx 8' to match the change below to the summer kitchen and added an additional step light.

#### **E3– Electric Schedules**

• Previously the basement electric plan, sheet E3 is now the Electrical Schedules.

#### S1 – Grade Beam and Pile plan

• Previously the basement structural sheet, sheet S1 is now the grade beam and pile plan for the first floor structure.

#### S2 – 1st Floor wall reinforcement plan


- Extended the Summer Kitchen eastward approx. 8'
- Removed the stairs down to the now removed basement
- Provided structure for the newly added storage mezzanines in both garages


#### S3 – Lower Framing Plan


- Extended the Summer Kitchen eastward approx. 8'
- Provided structure for the newly added storage mezzanines in both garages


#### S4 – 2<sup>nd</sup> Floor Wall Reinf Plan


• Extended the open balcony off of Guest Suite #2 approx 8' to match the change below to the summer kitchen

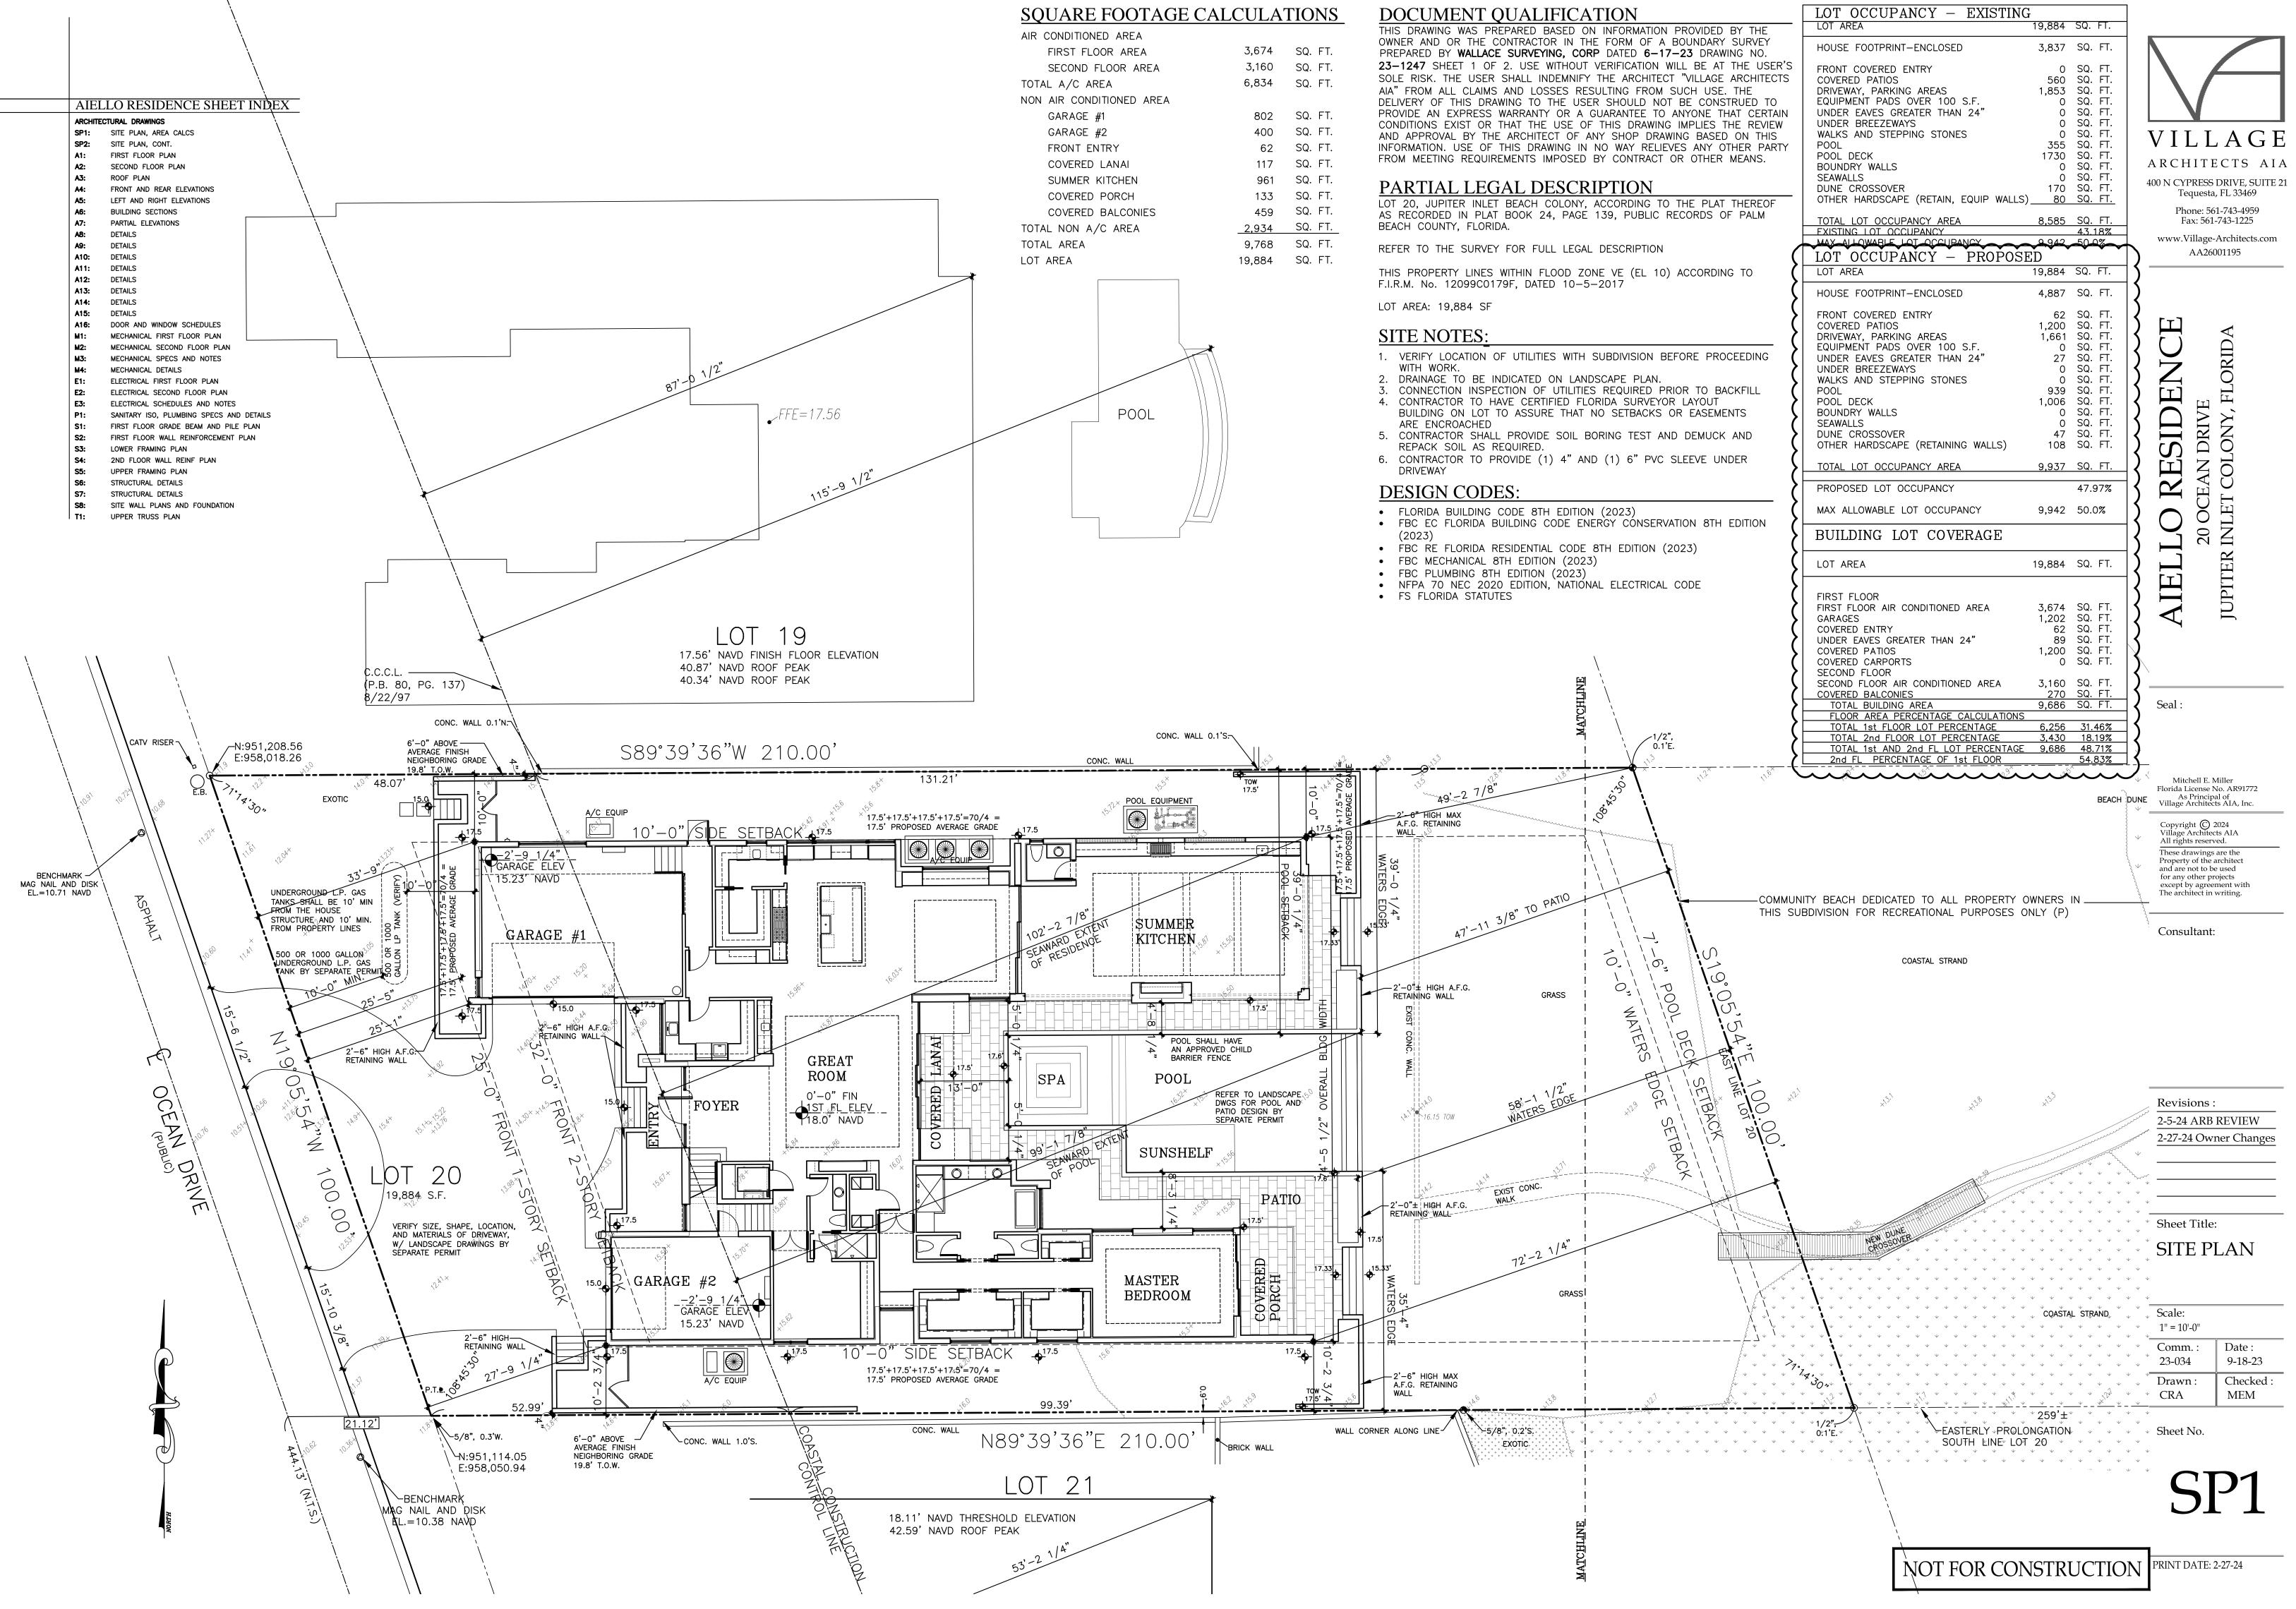


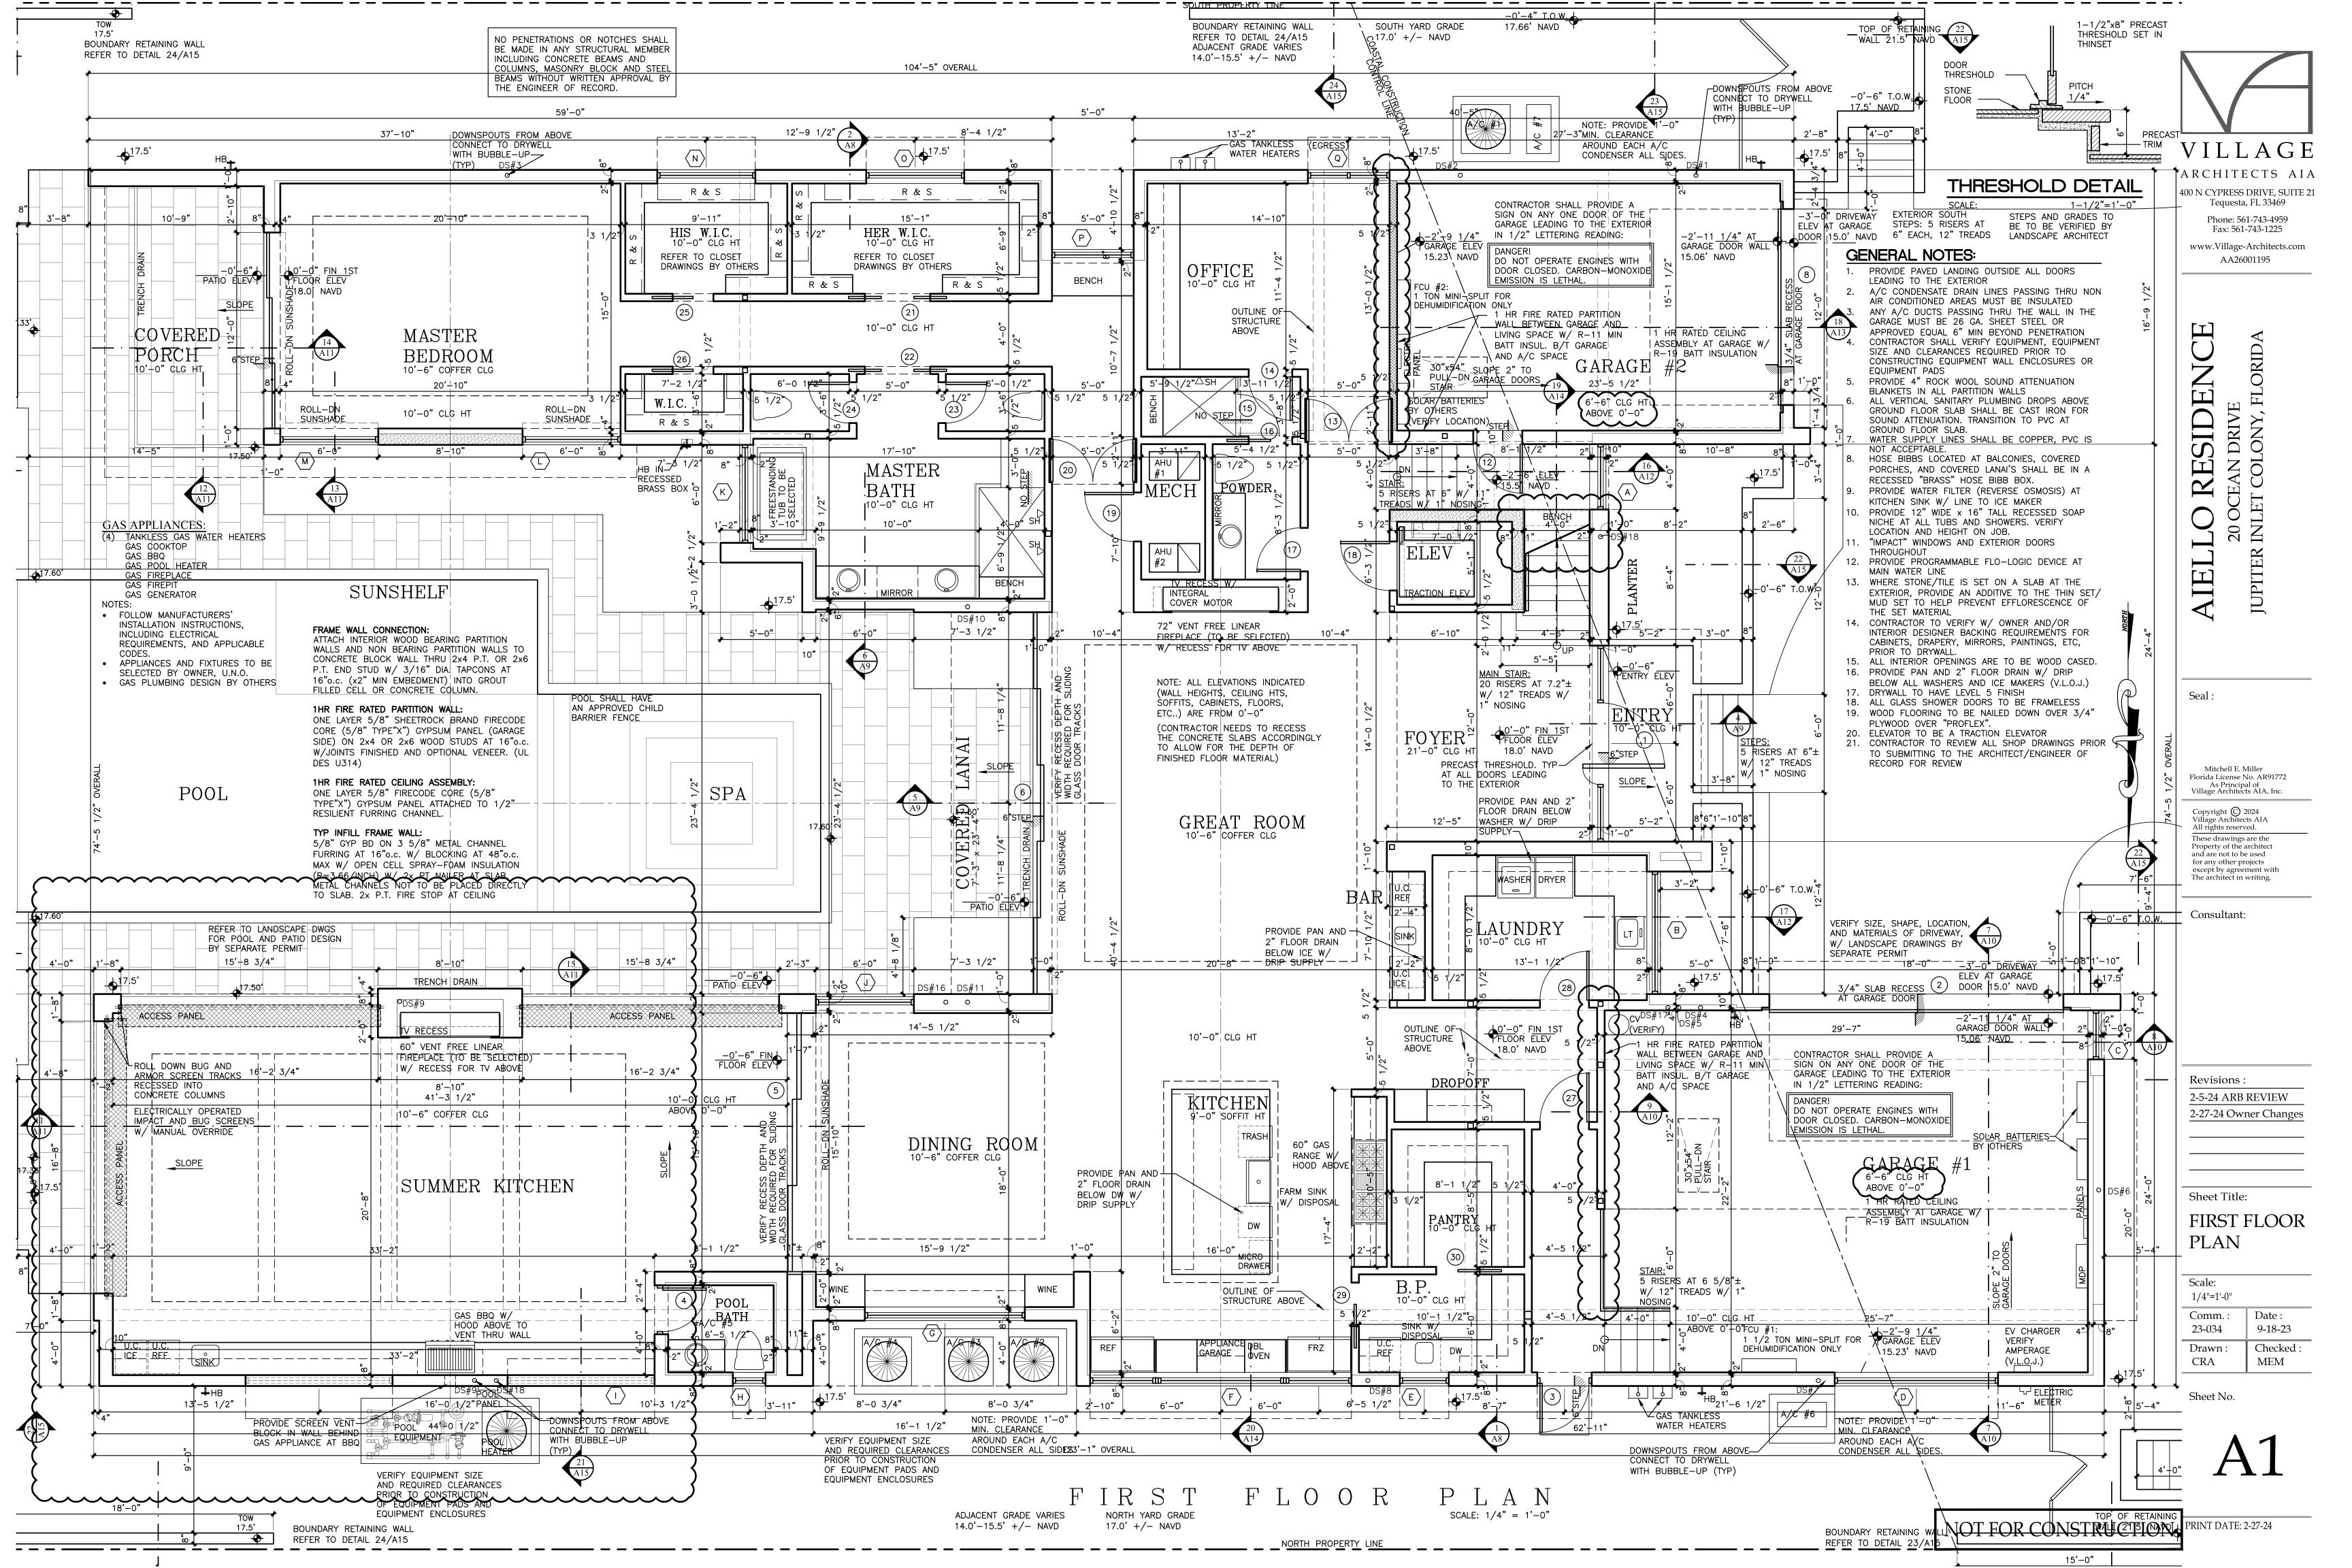


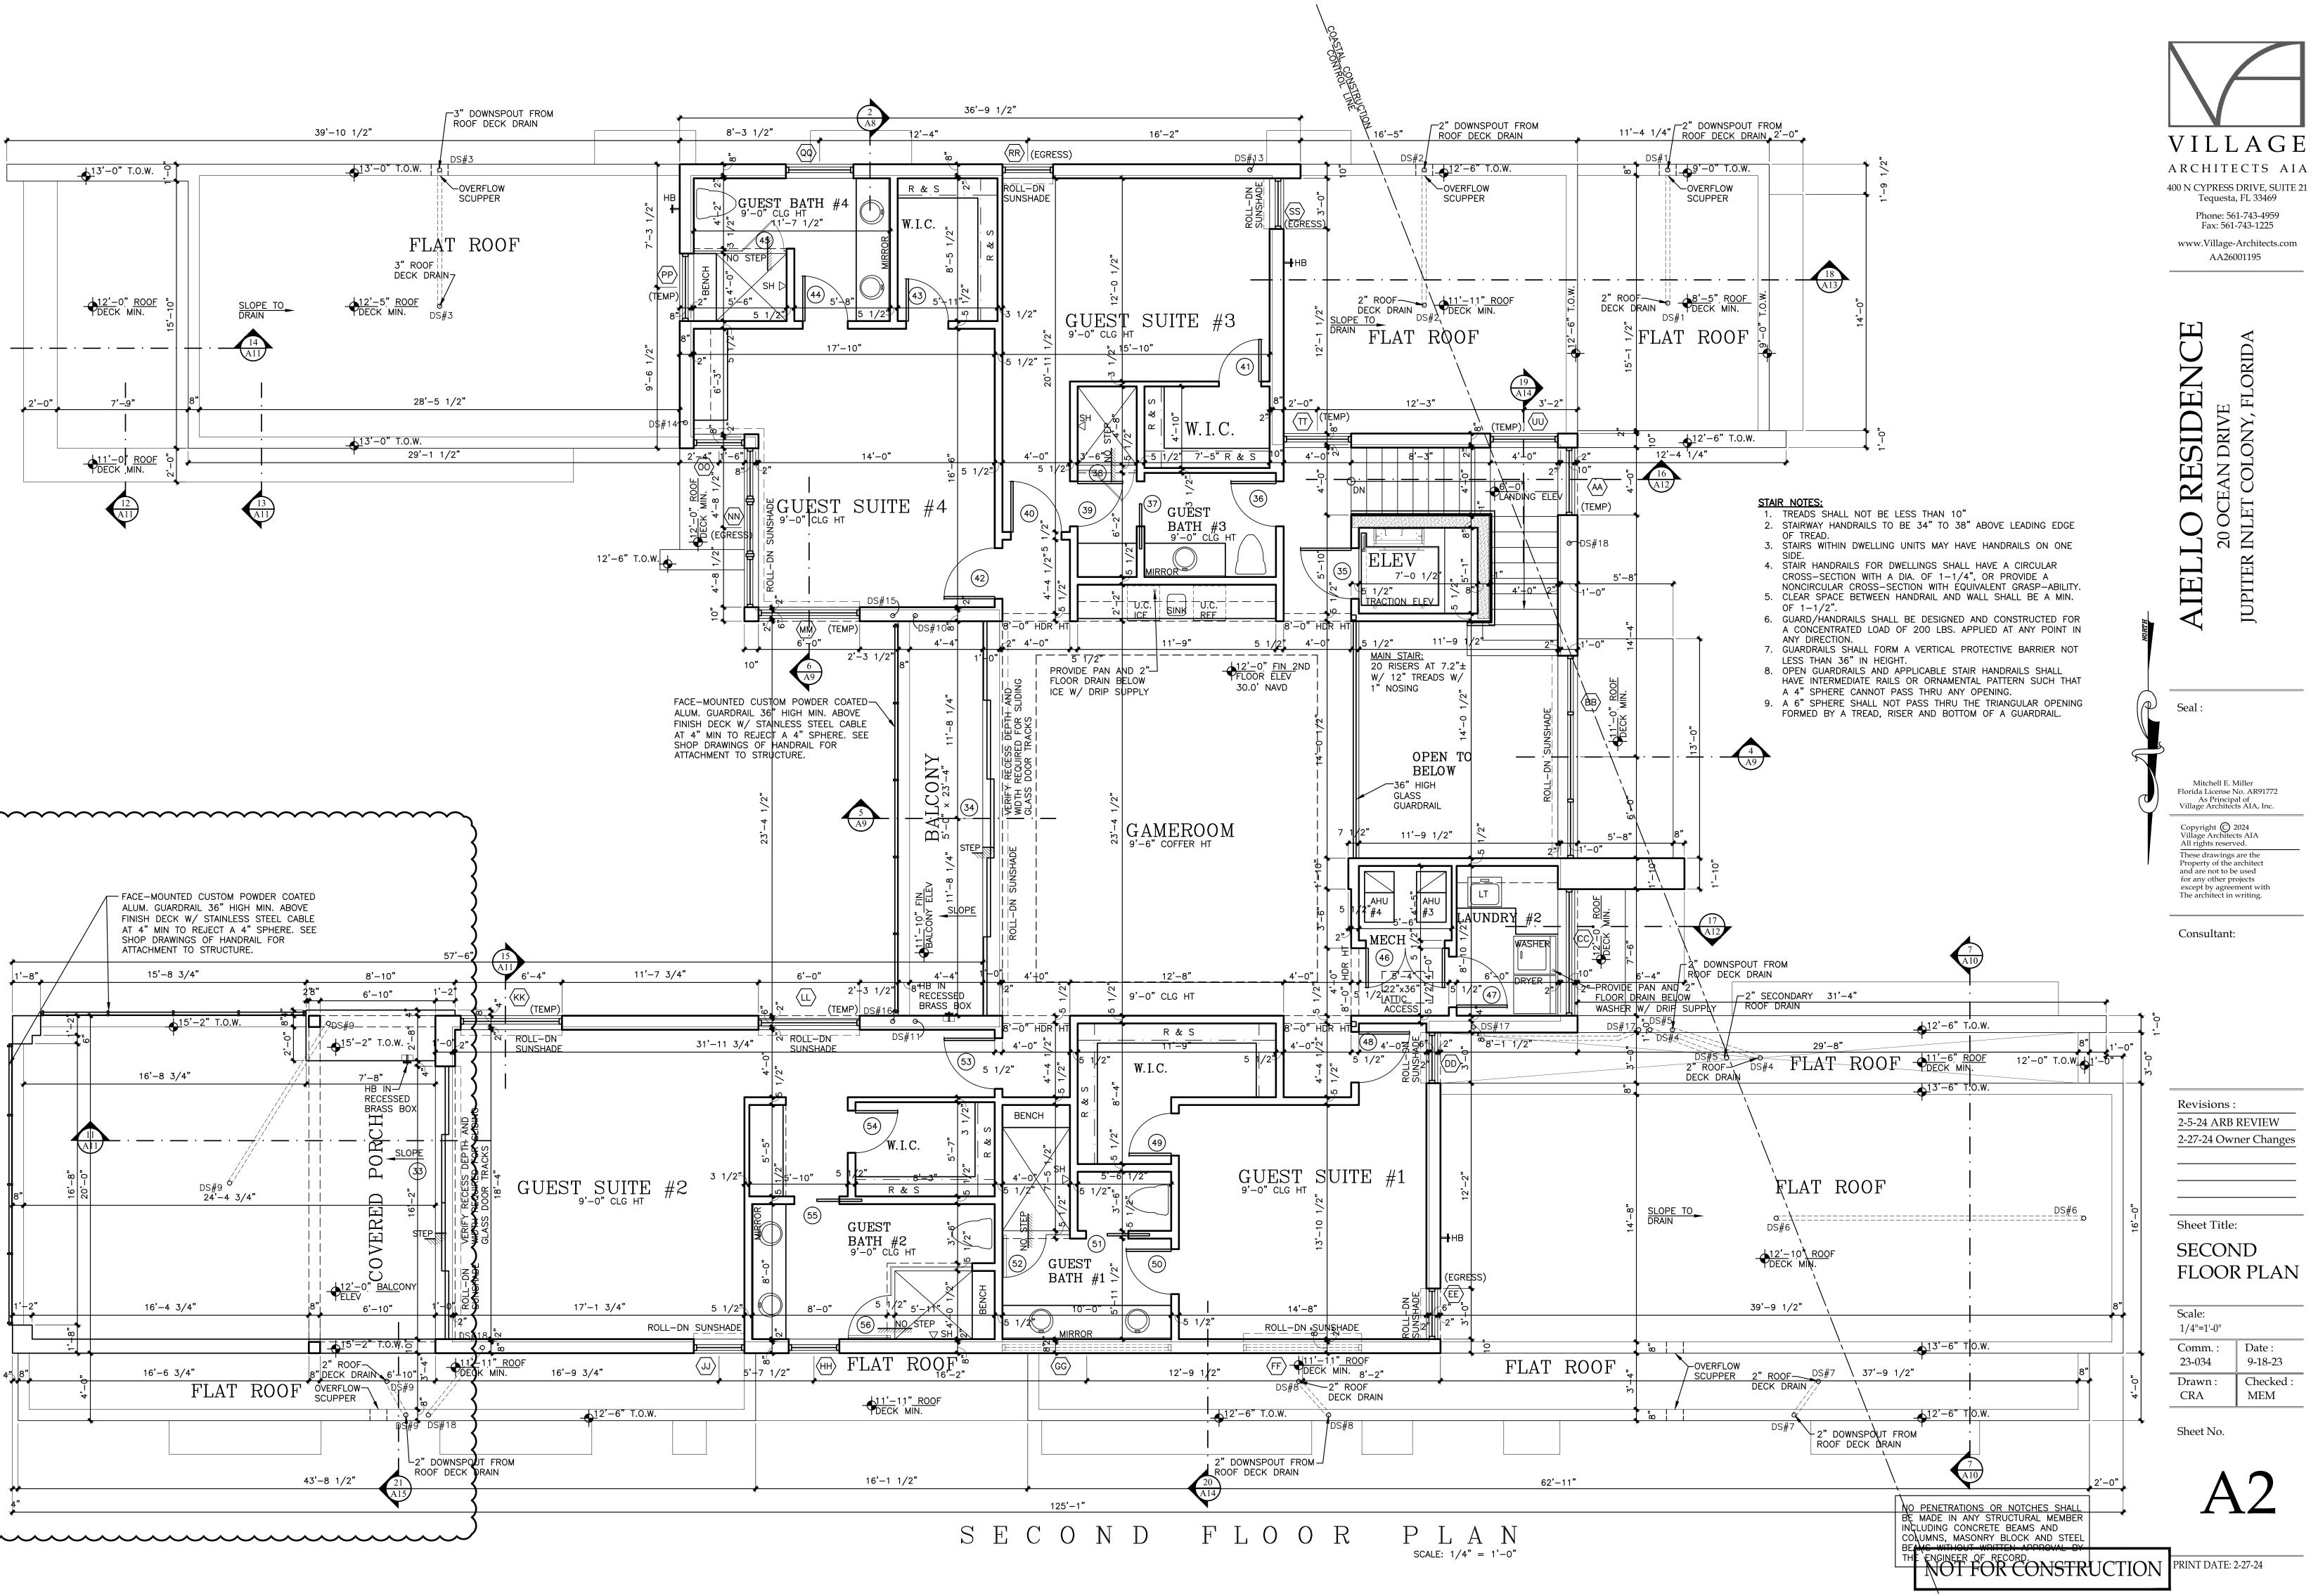

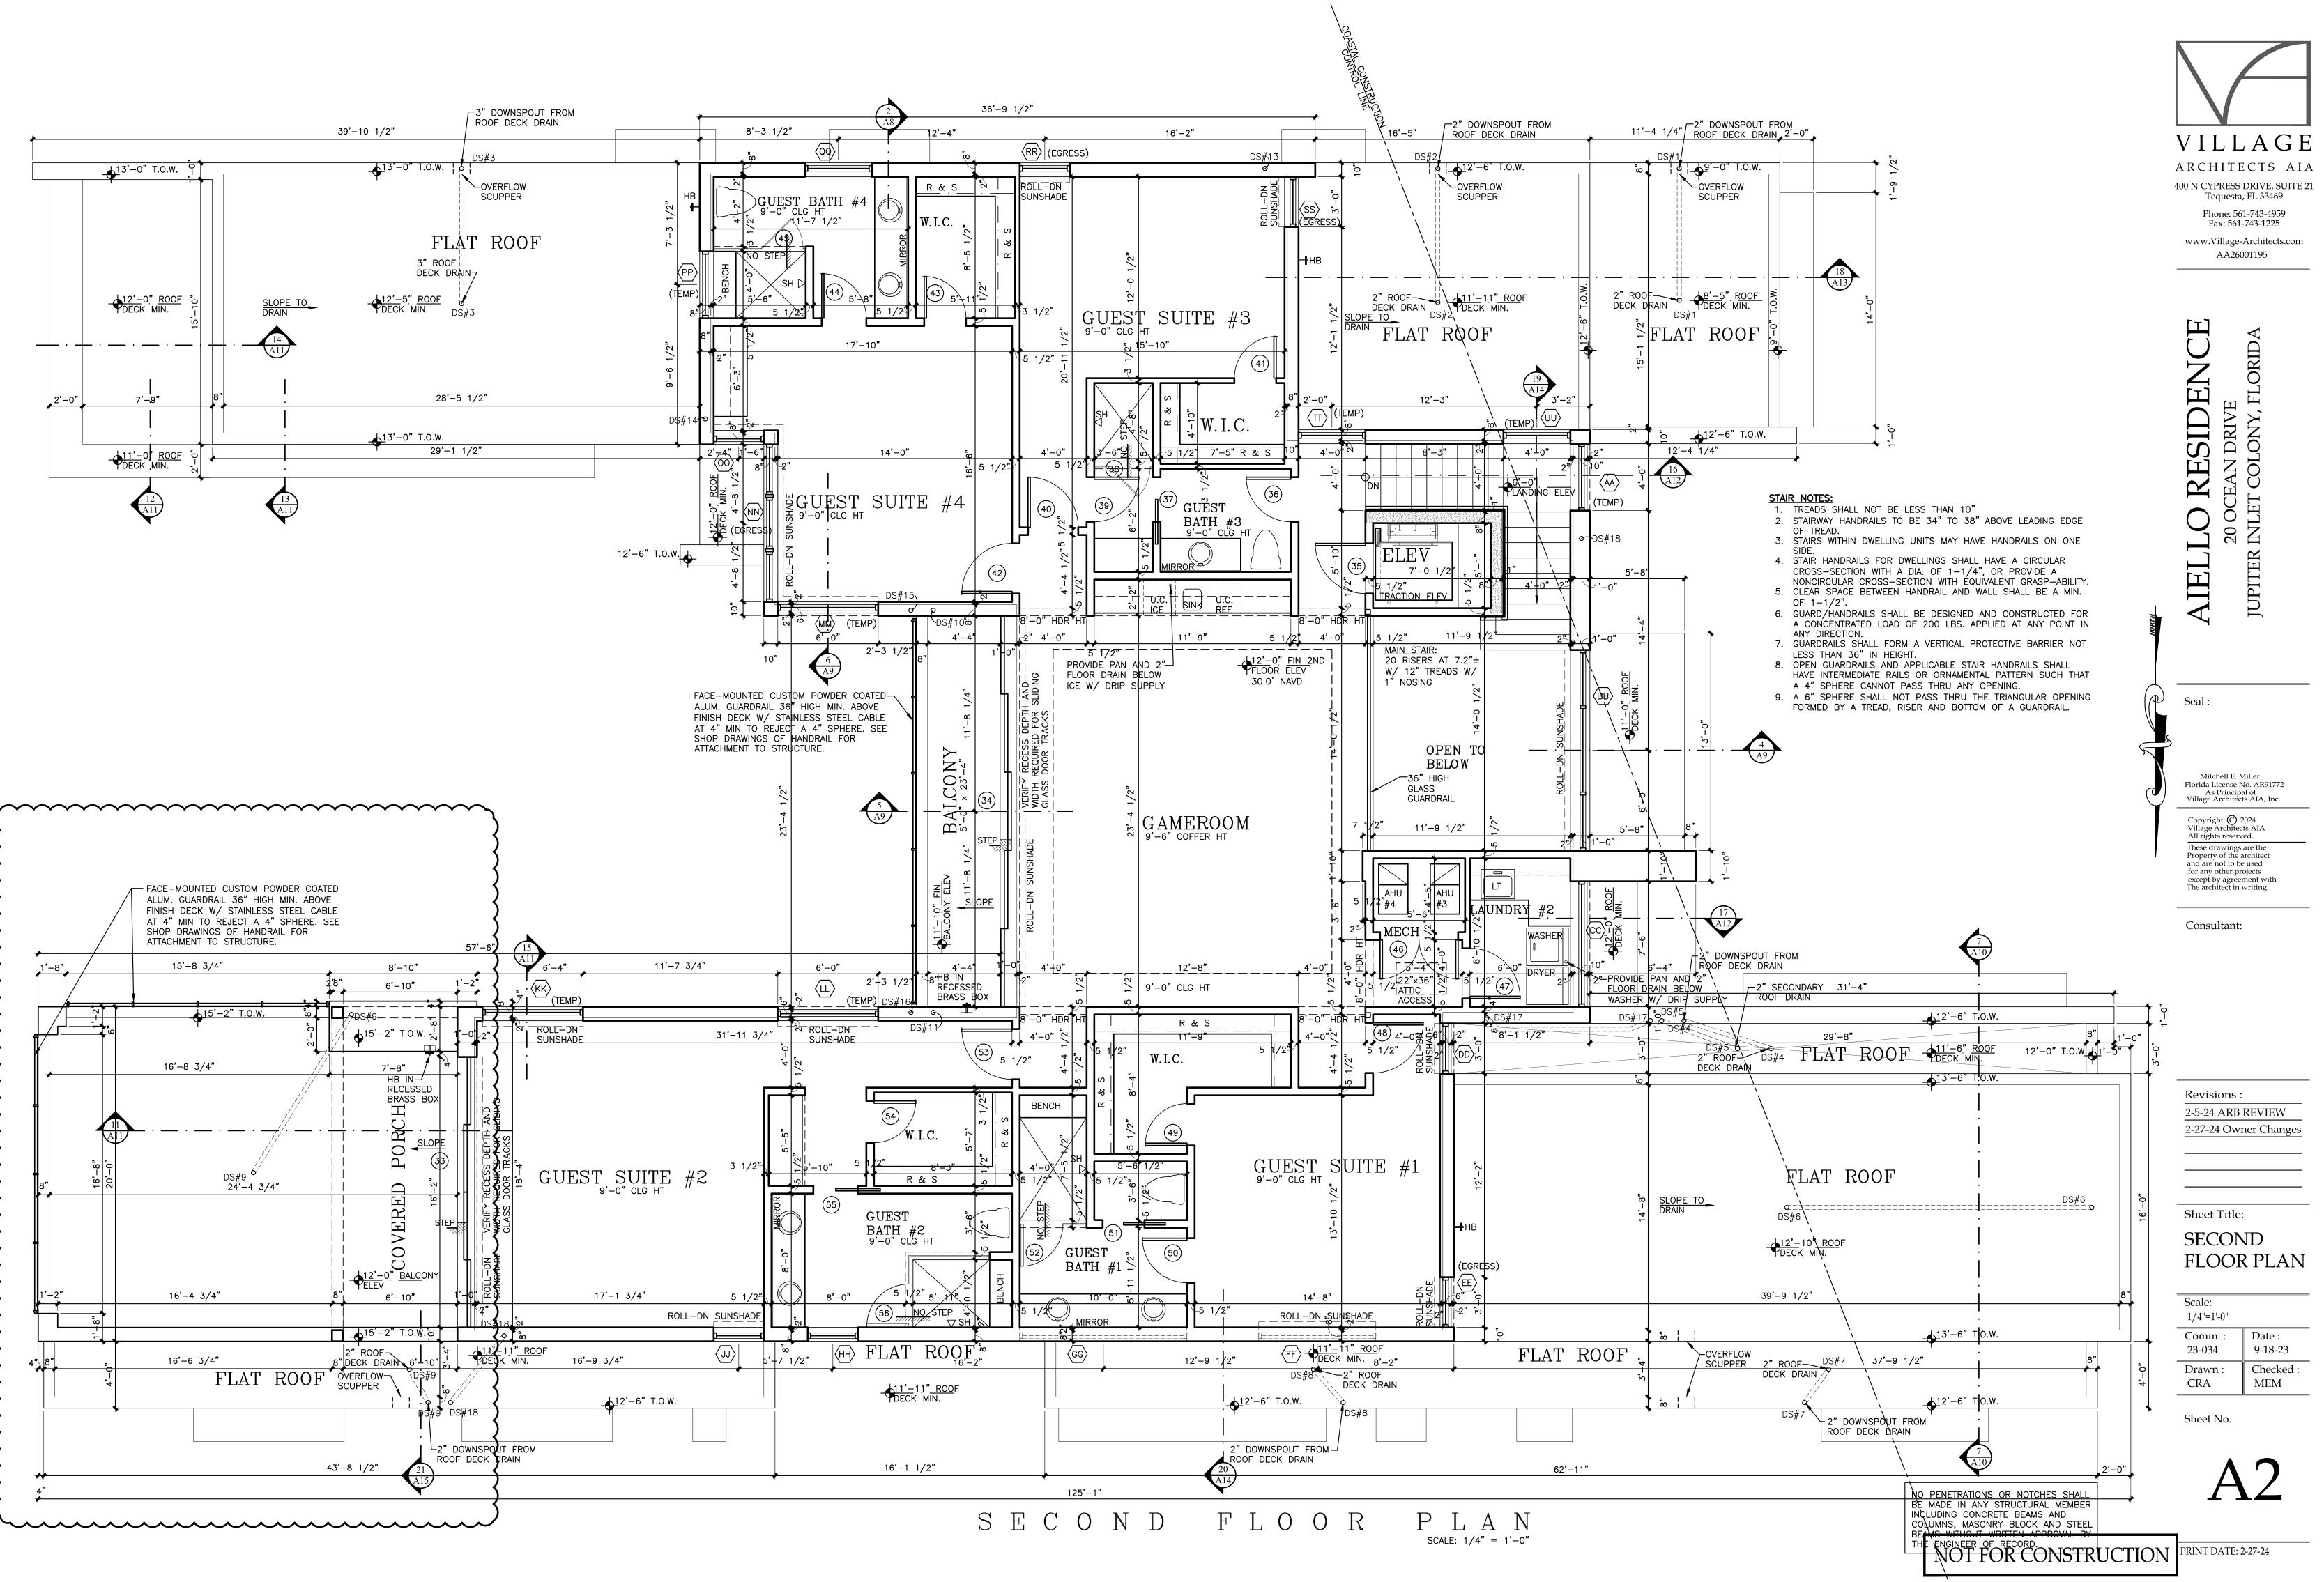

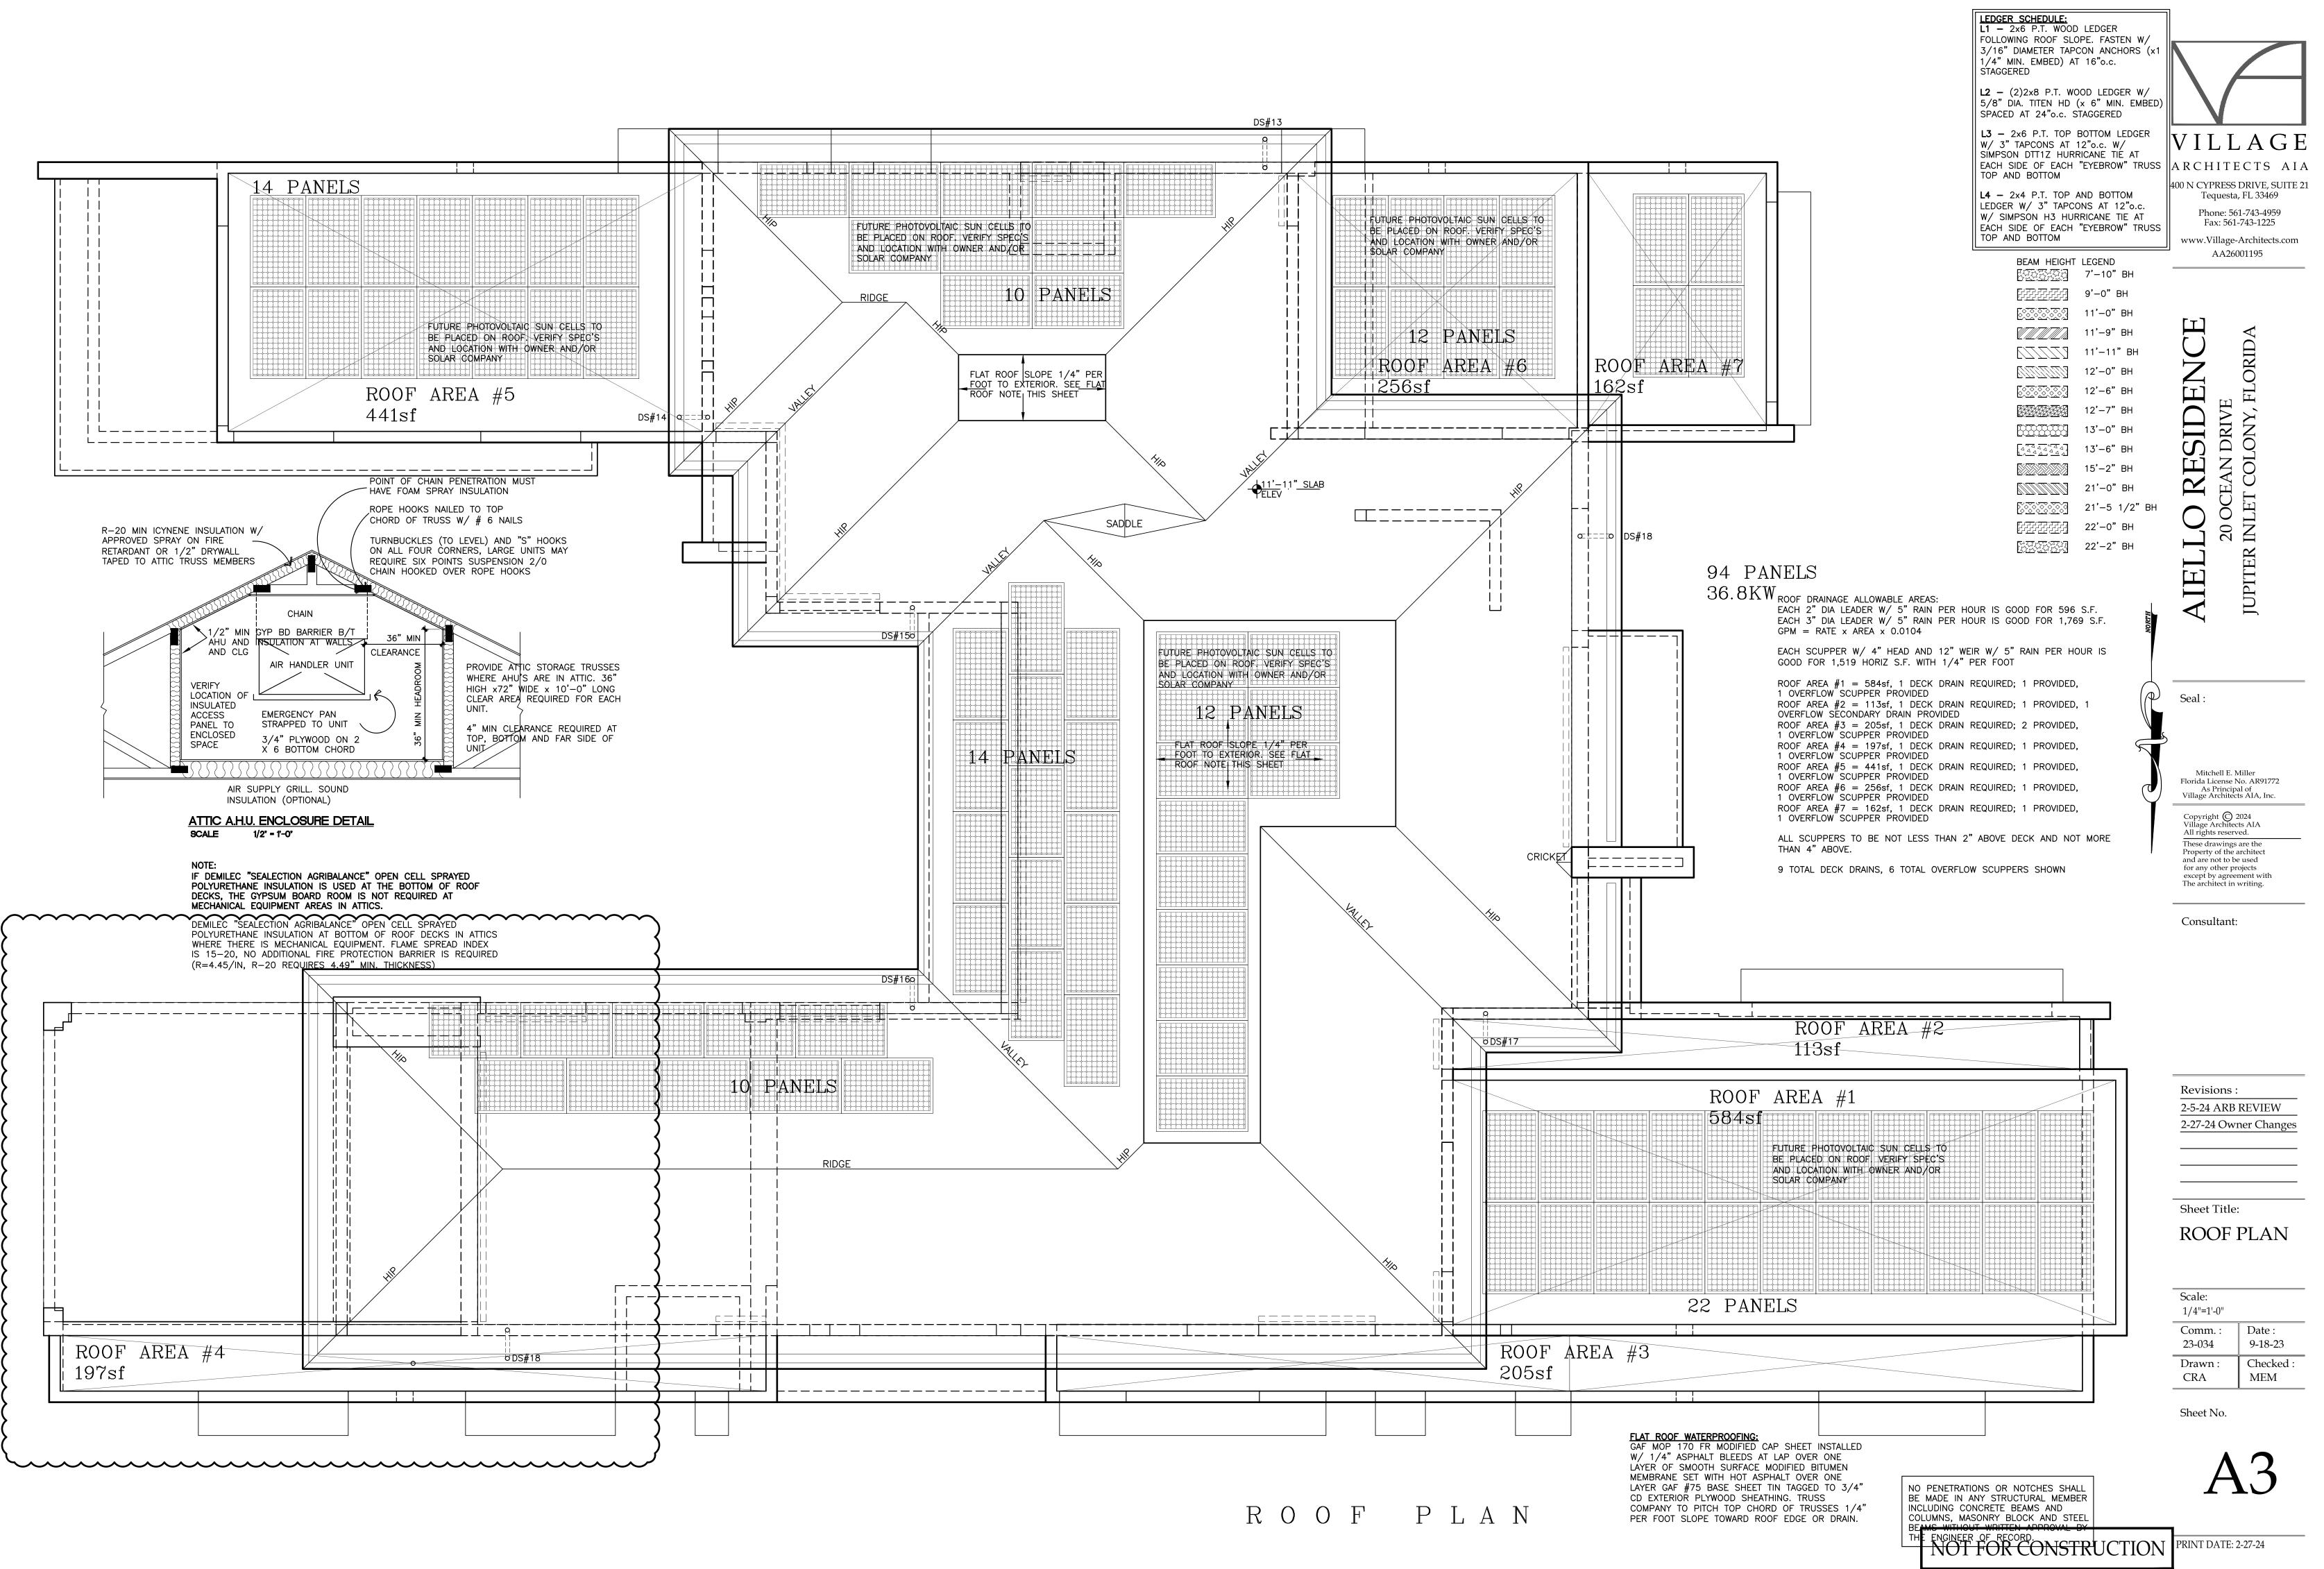

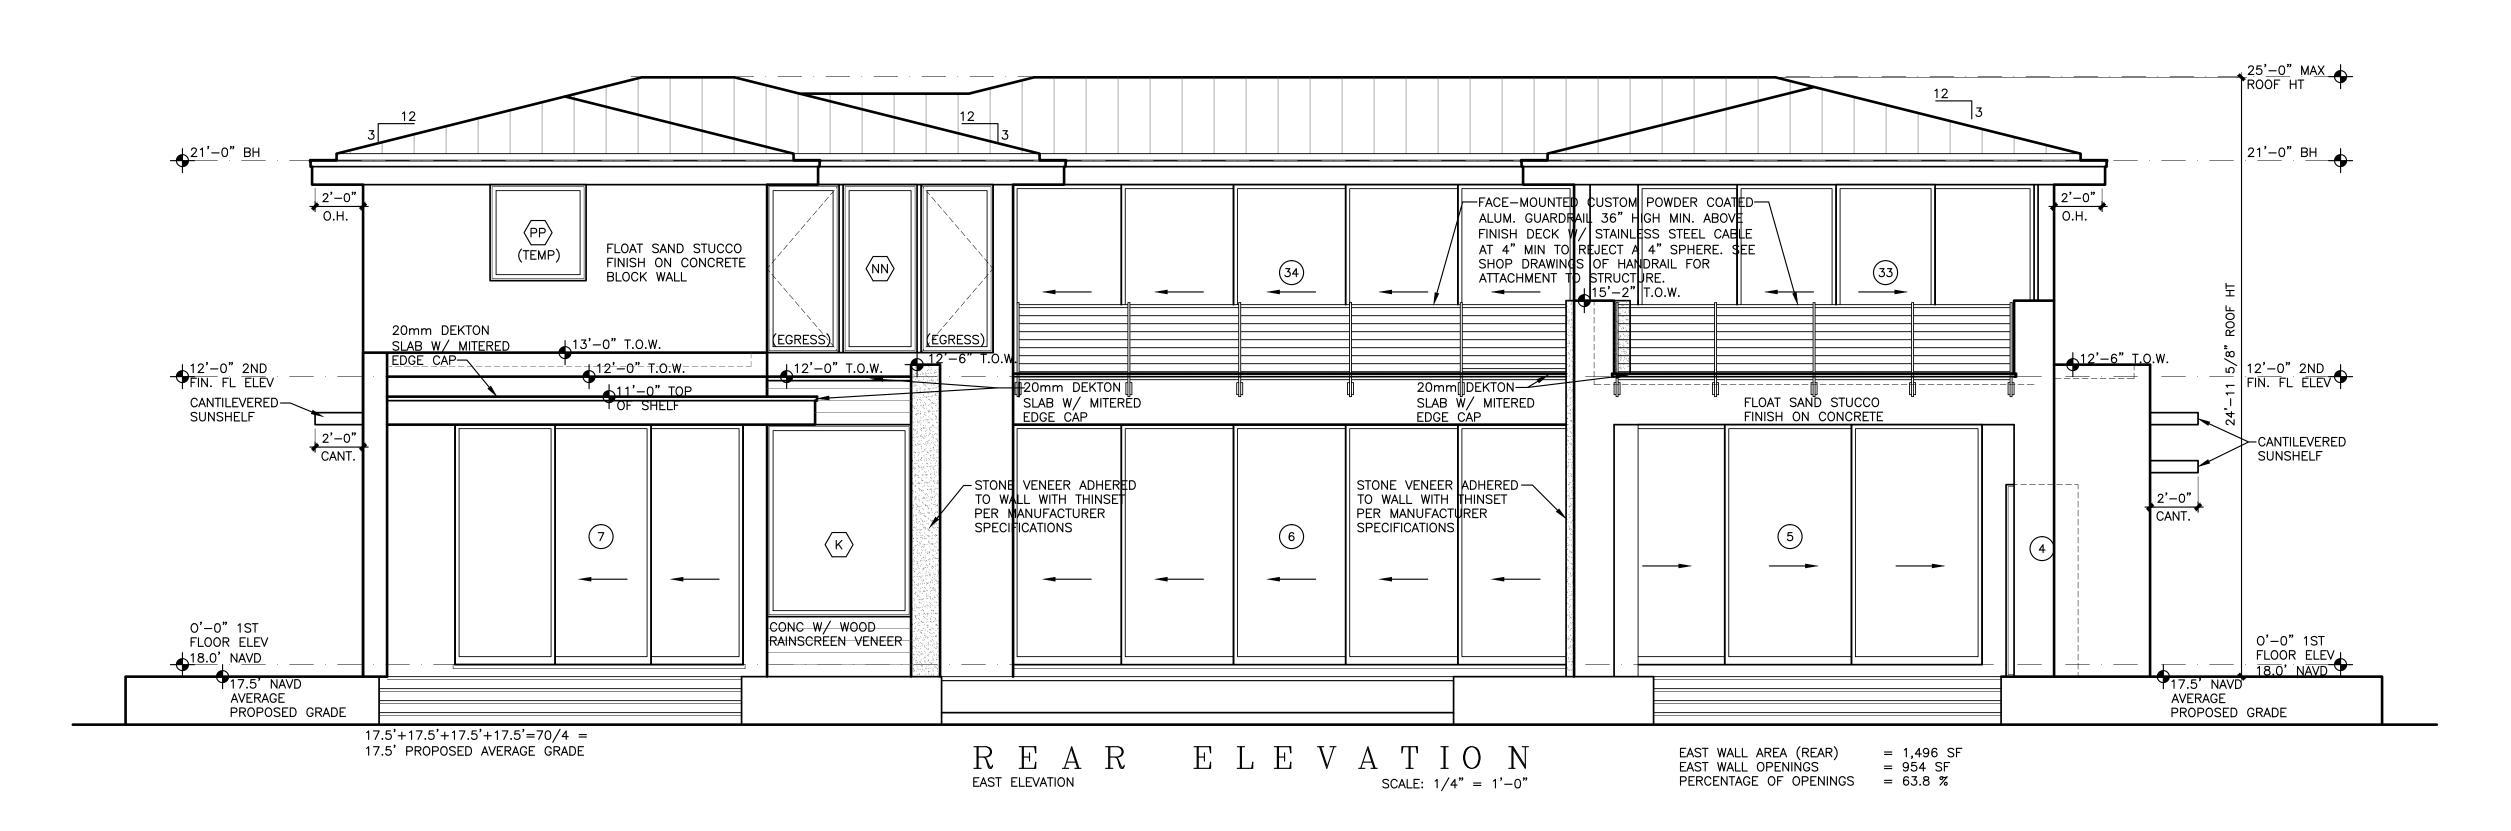

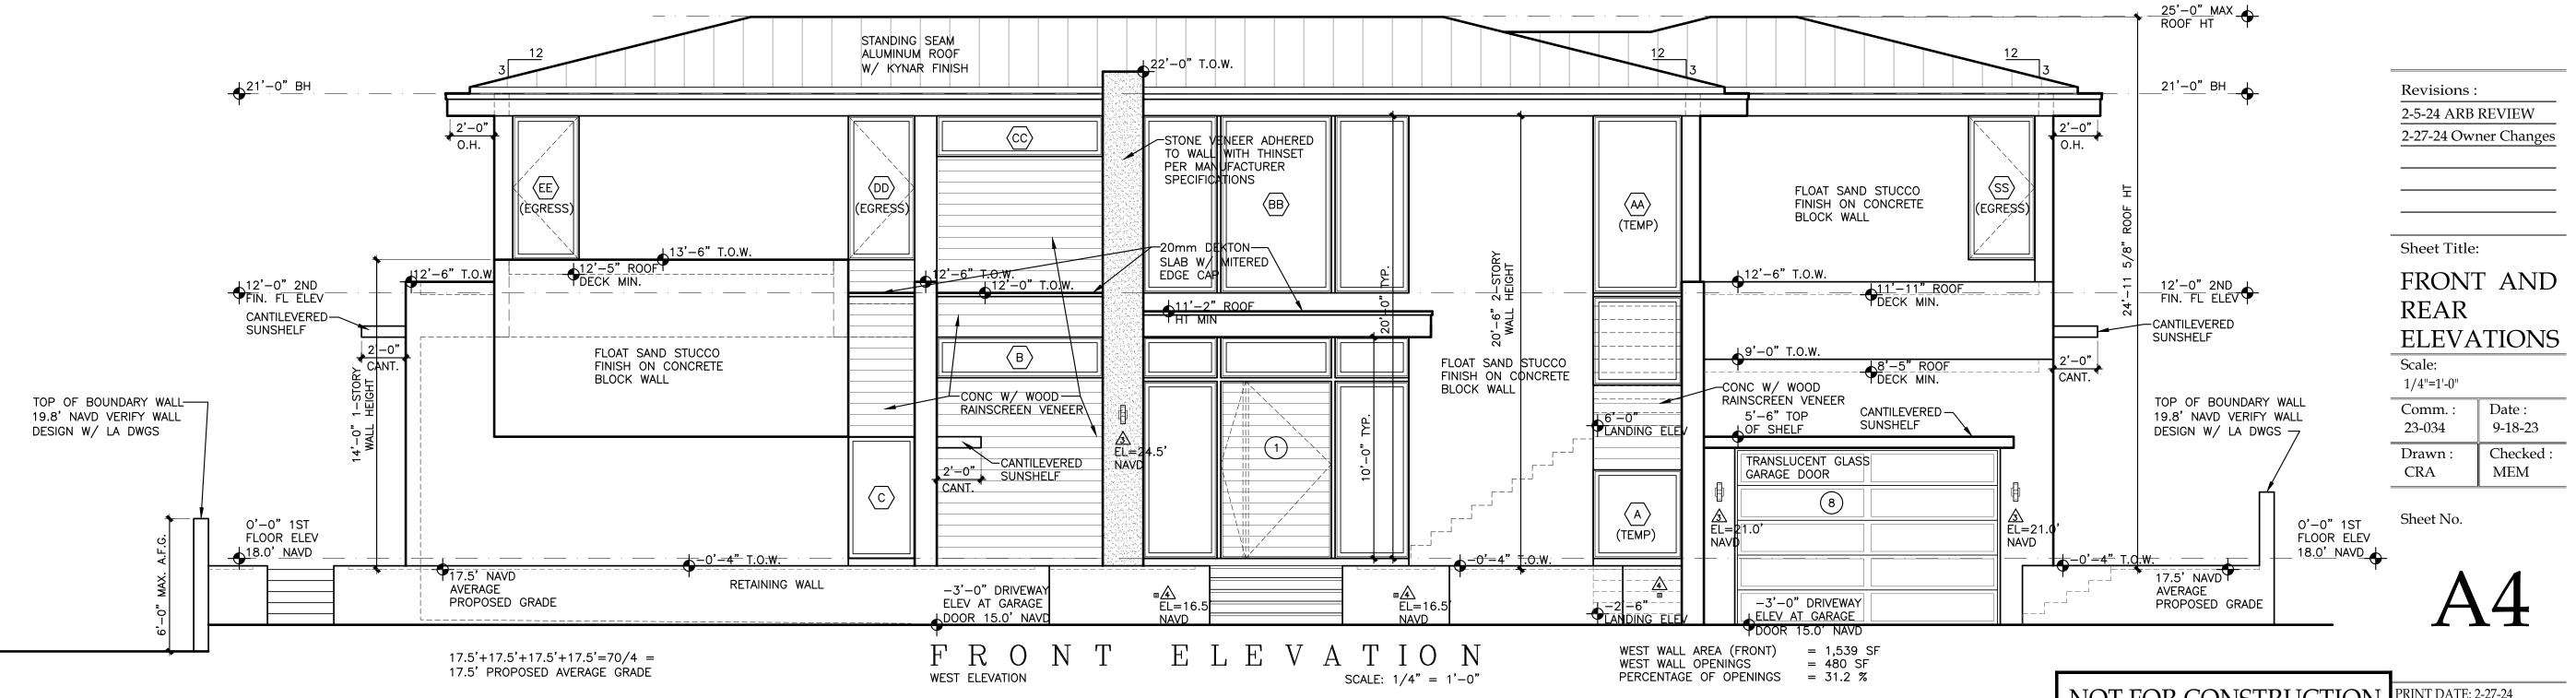






Seal :


Mitchell E. Miller Florida License No. AR91772 As Principal of Village Architects AIA, Inc.


Copyright () 2024 Village Architects AIA All rights reserved. These drawings are the Property of the architect and are not to be used for any other projects except by agreement with The architect in writing.


Consultant:


NOT FOR CONSTRUCTION PRINT DATE: 2-27-24

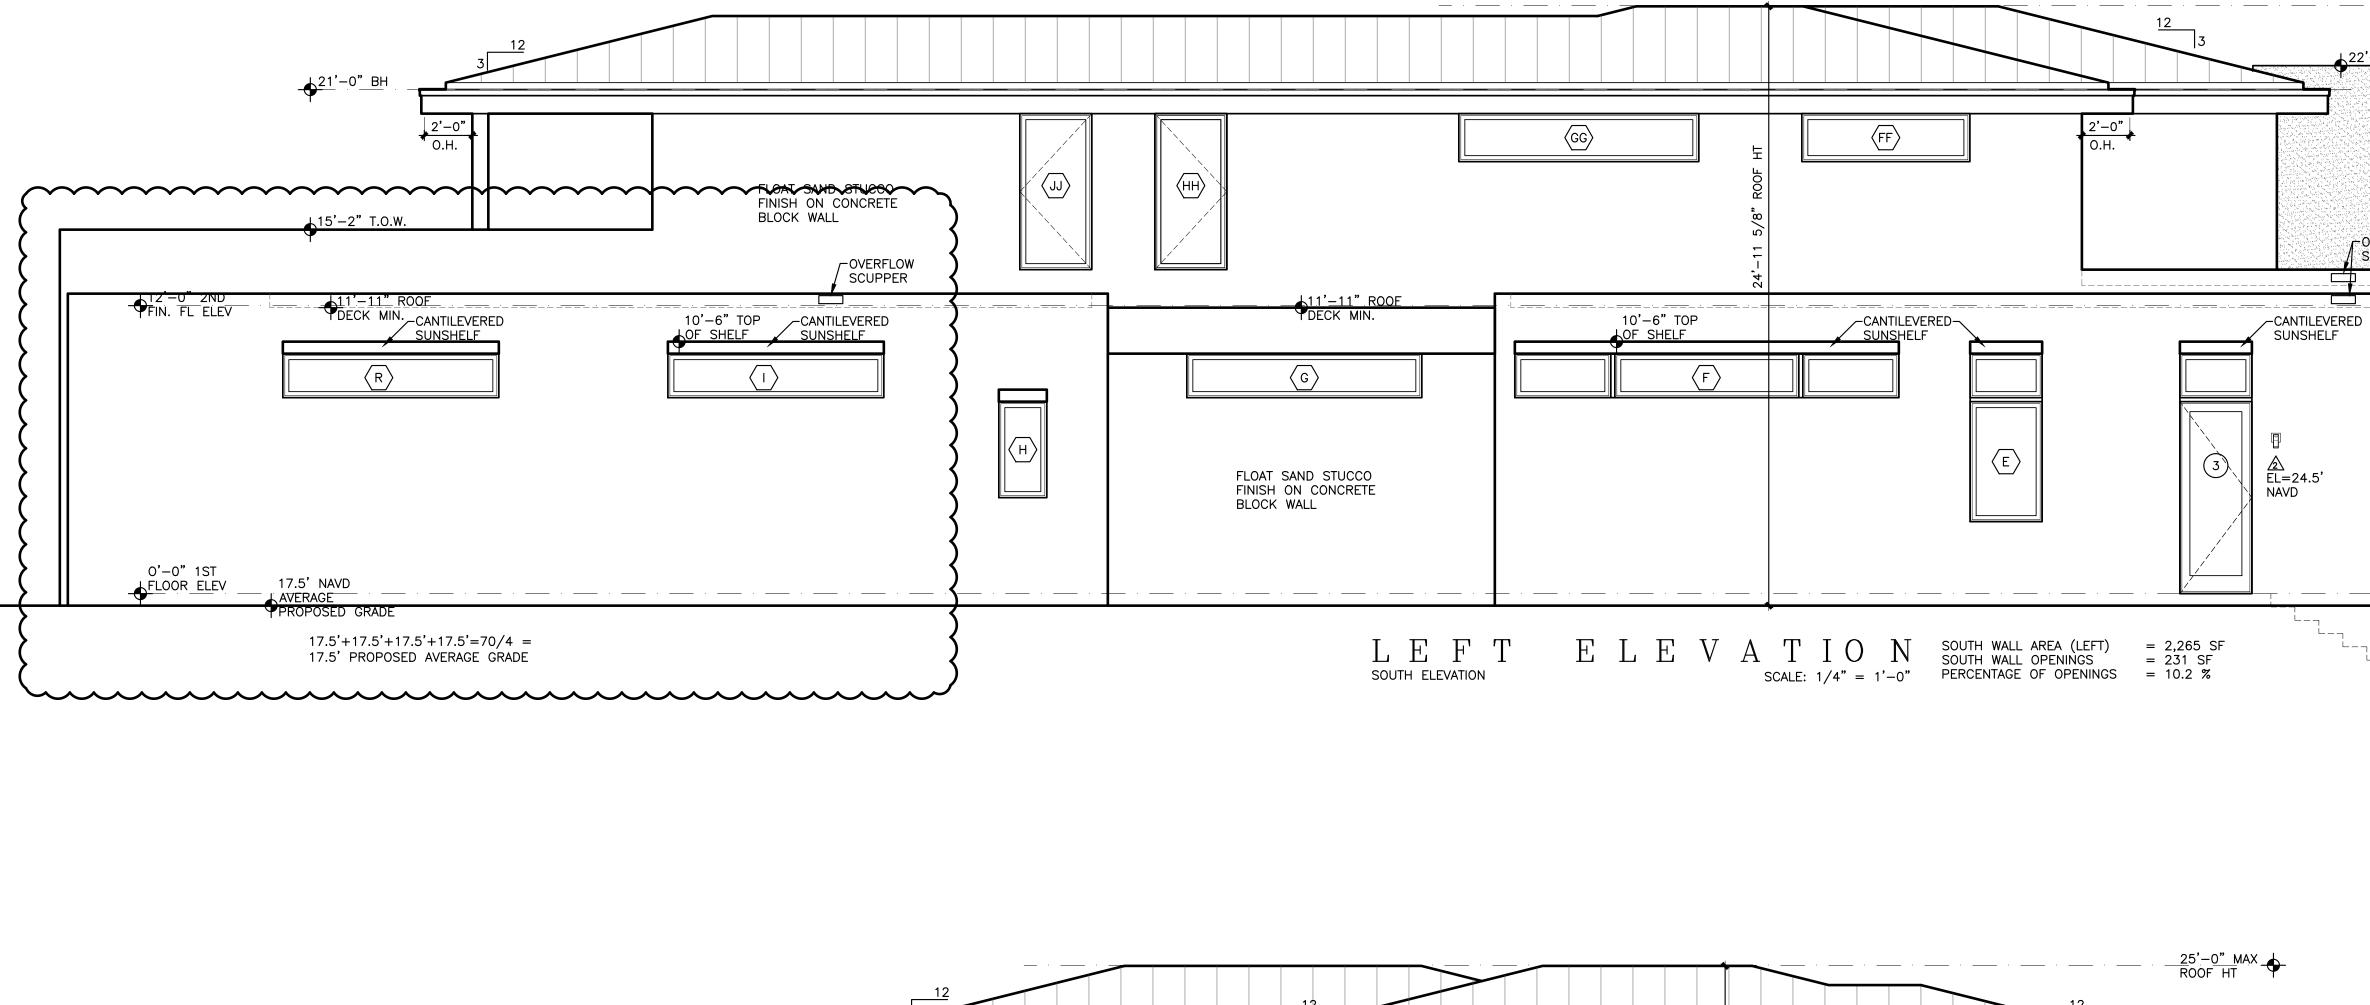


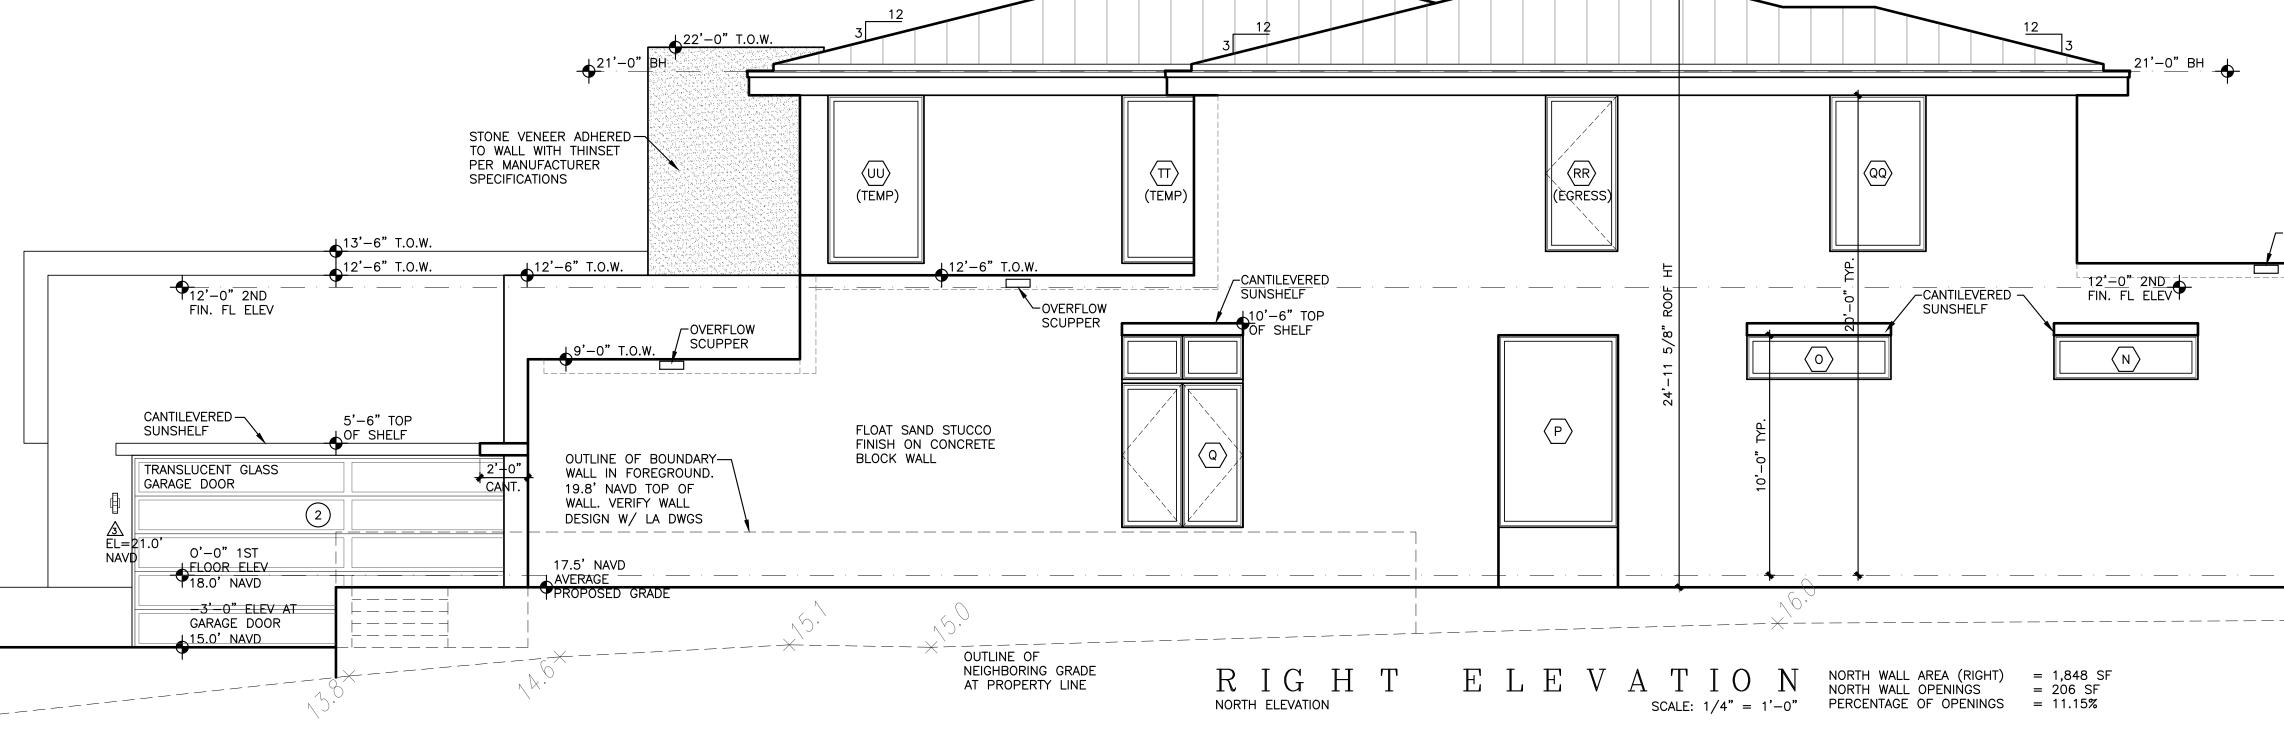

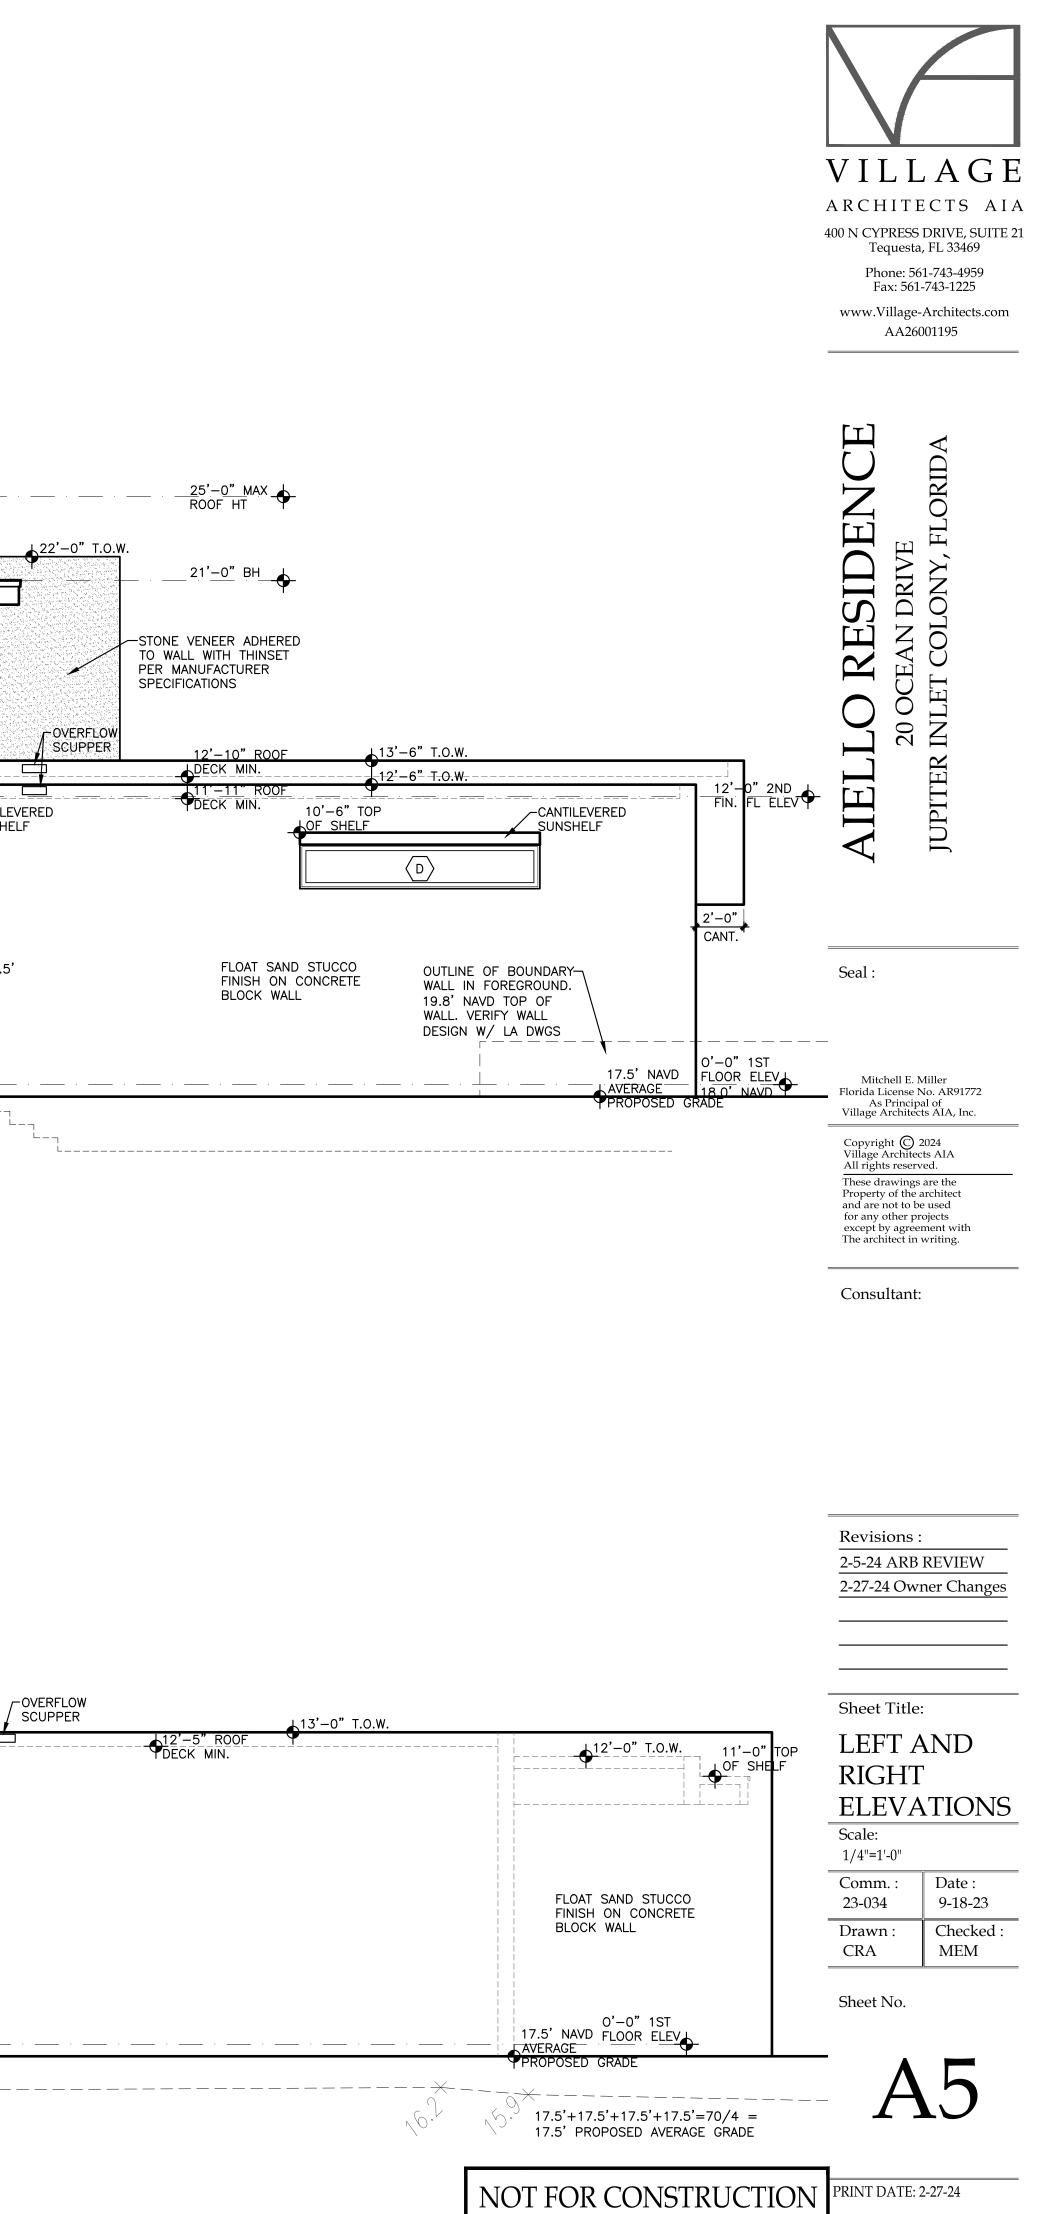

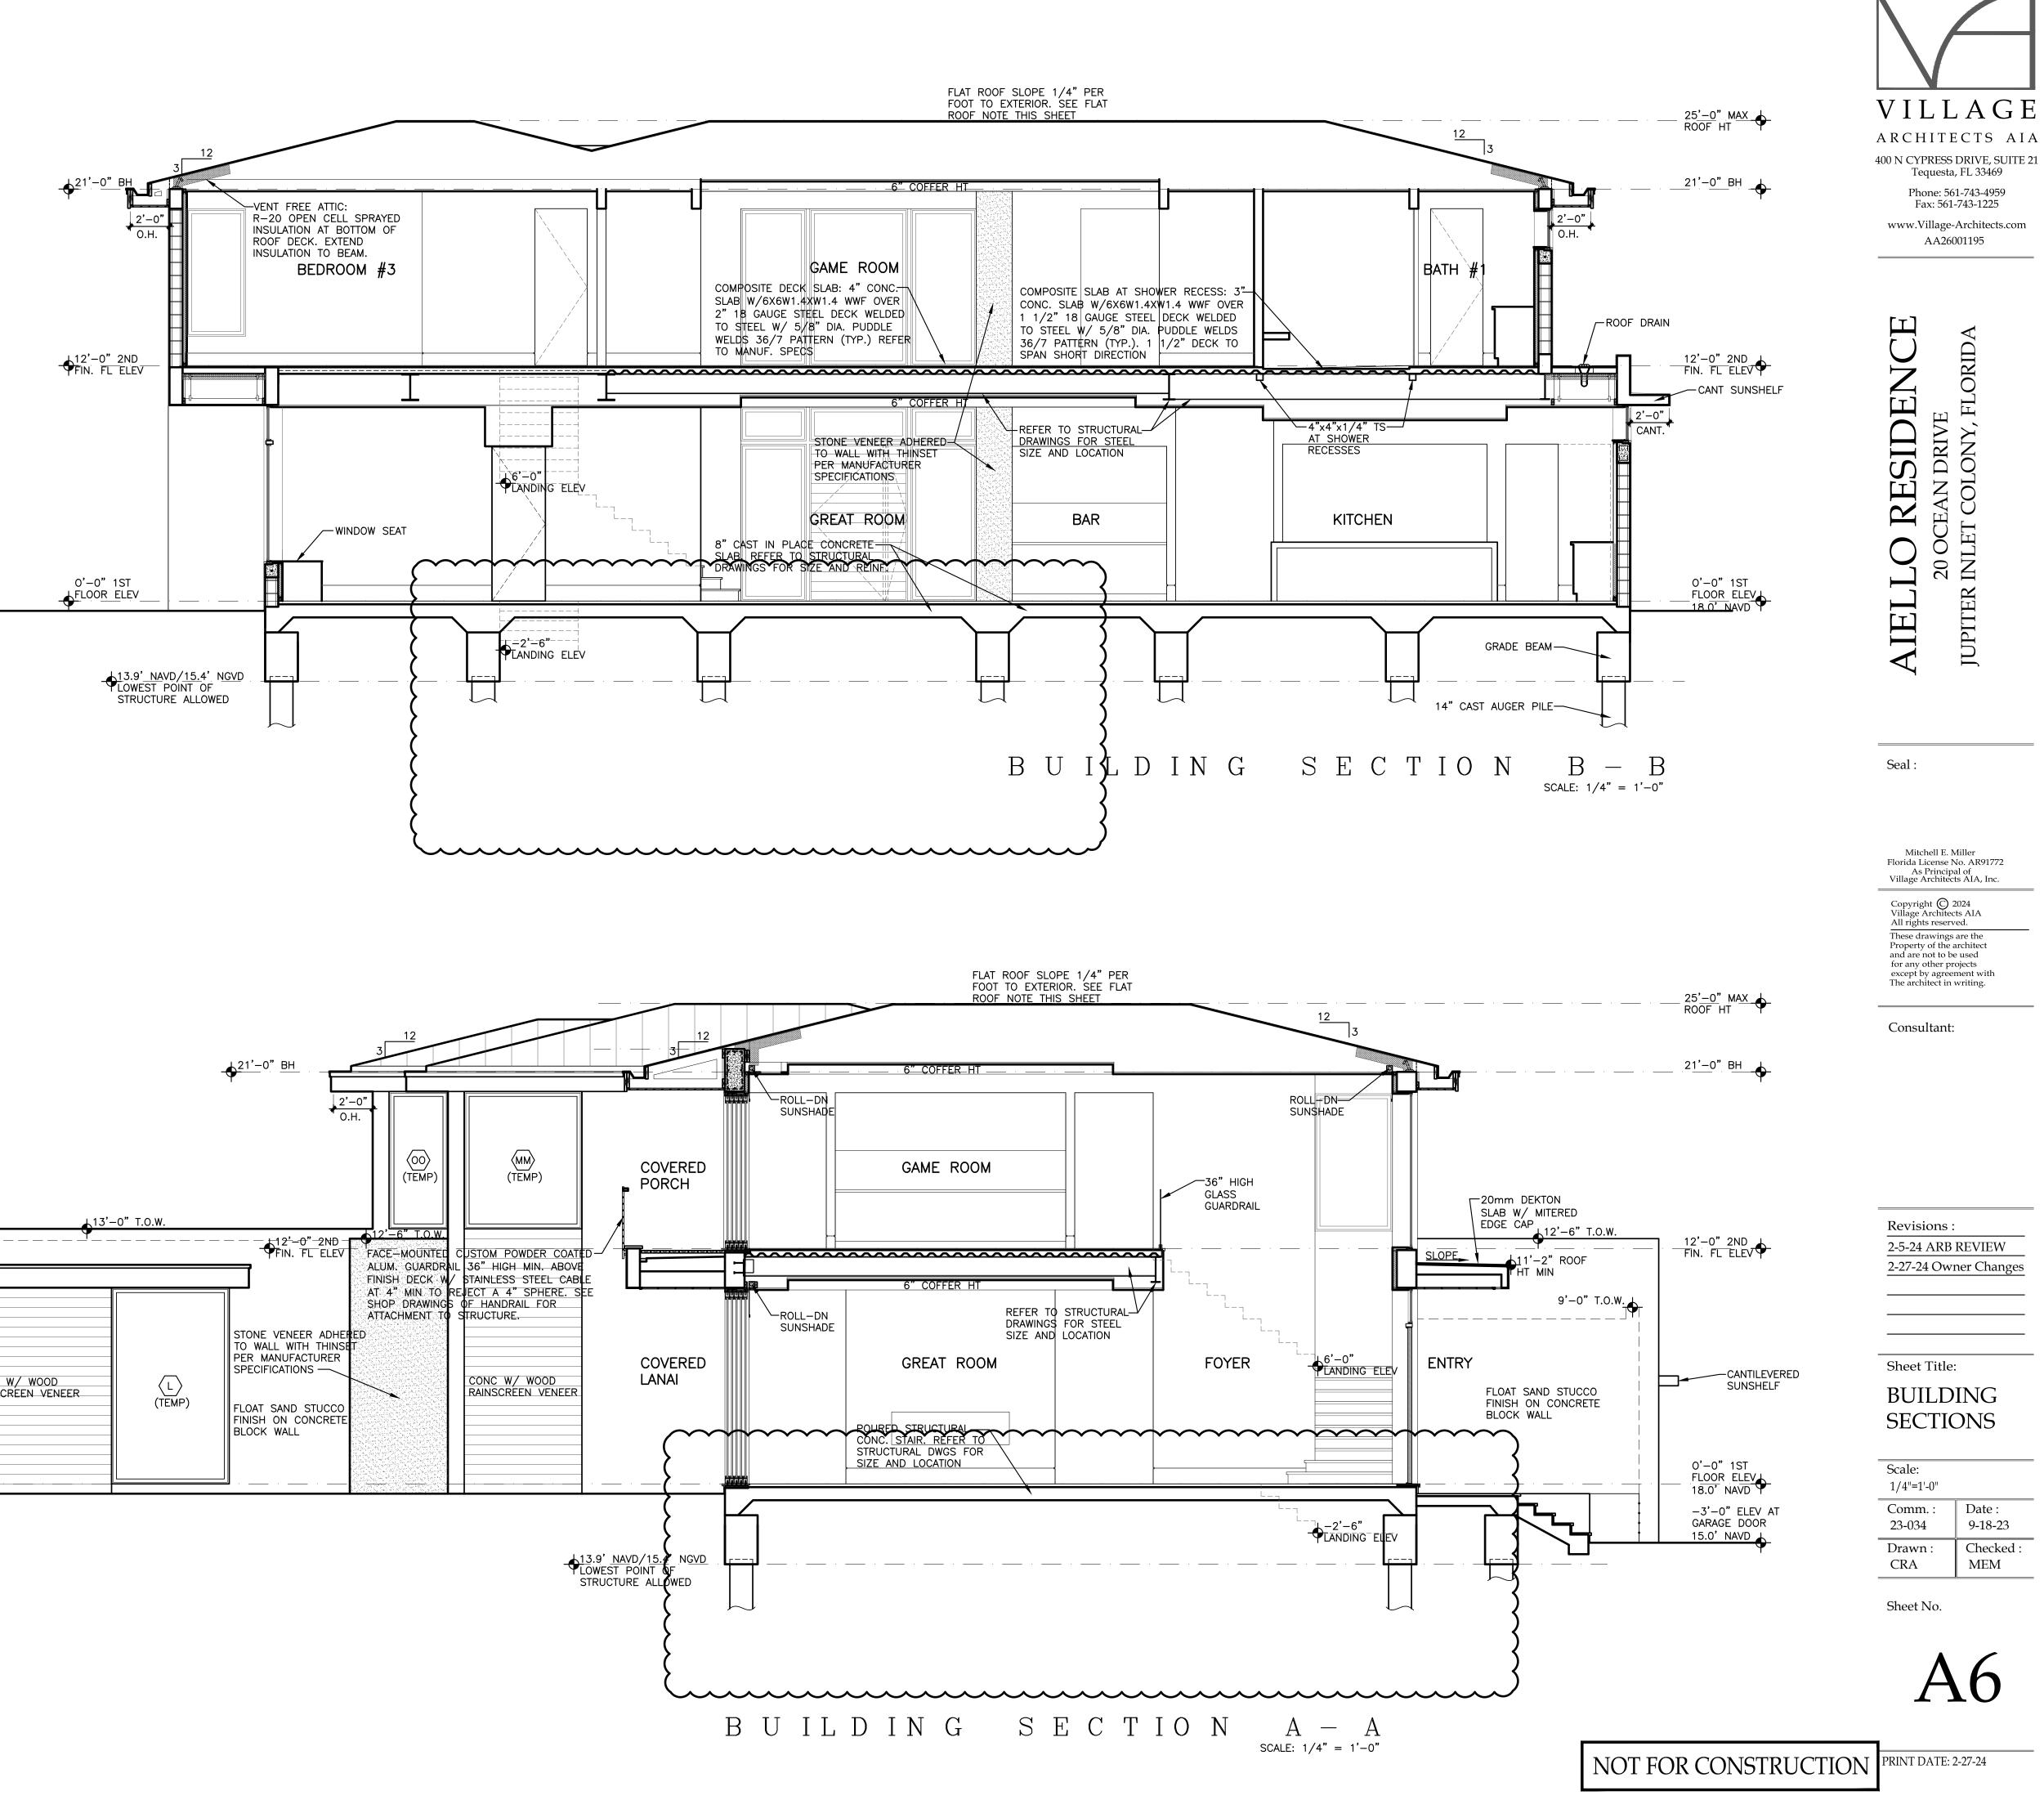


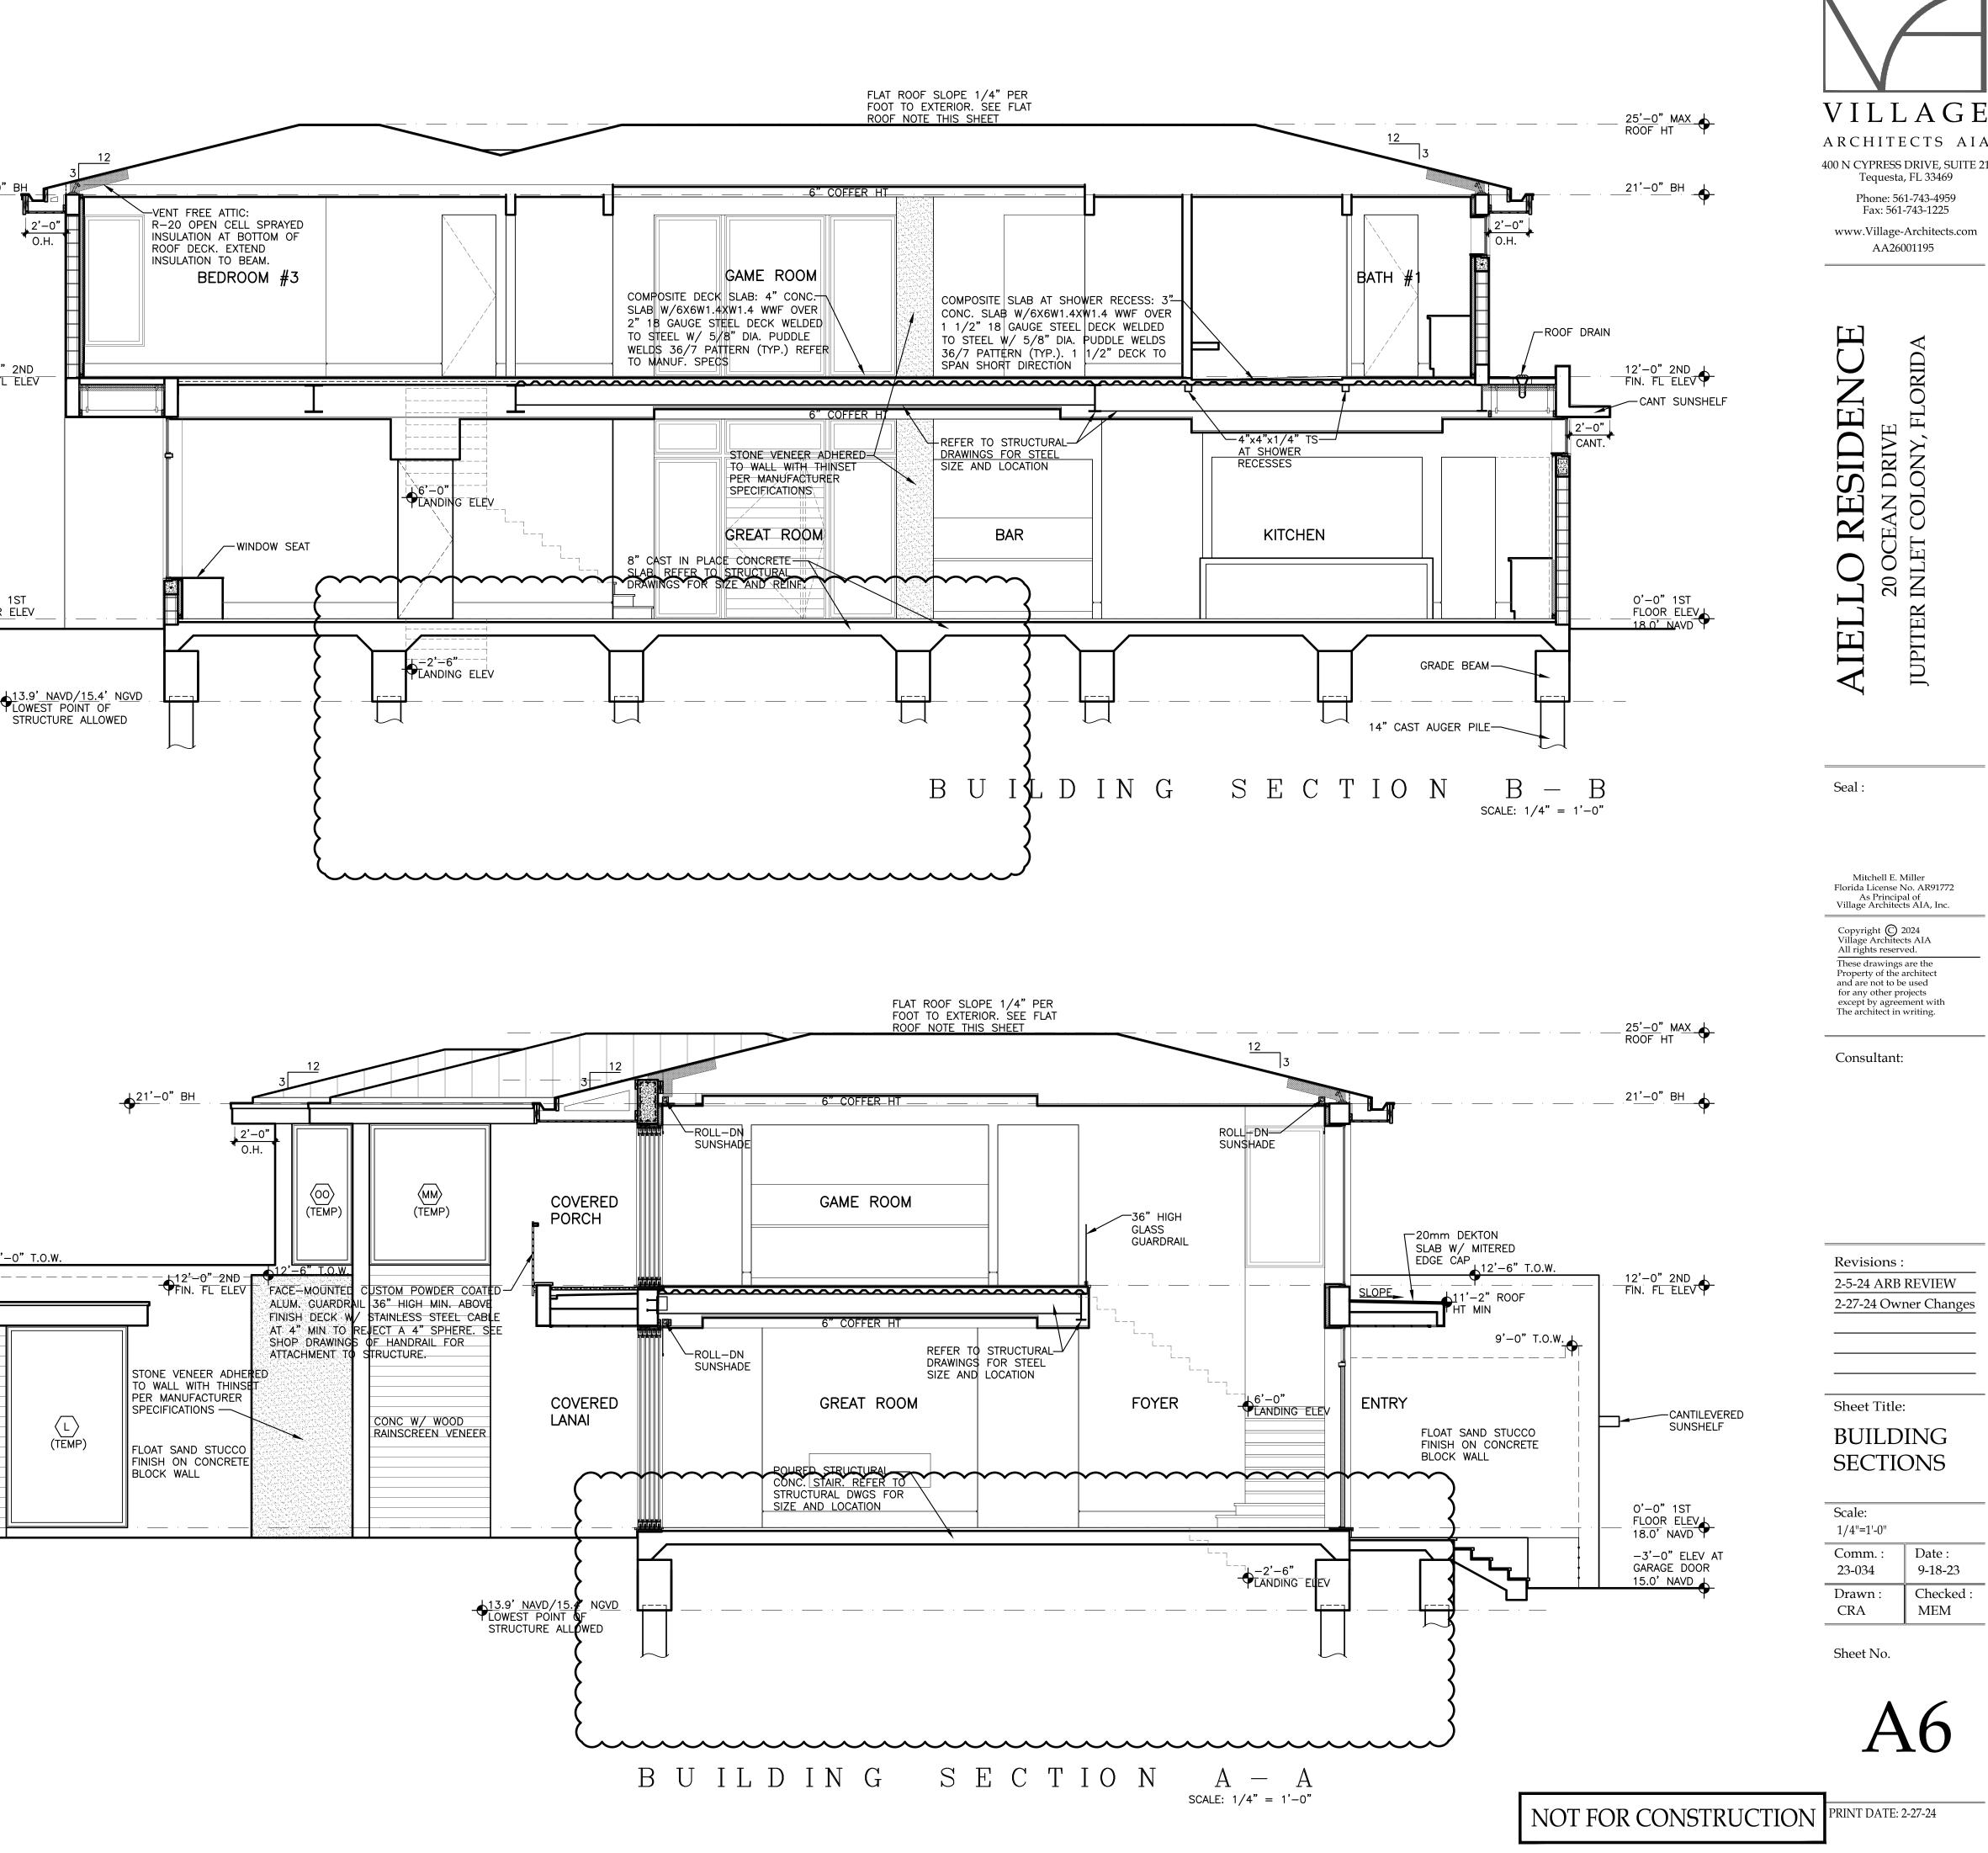


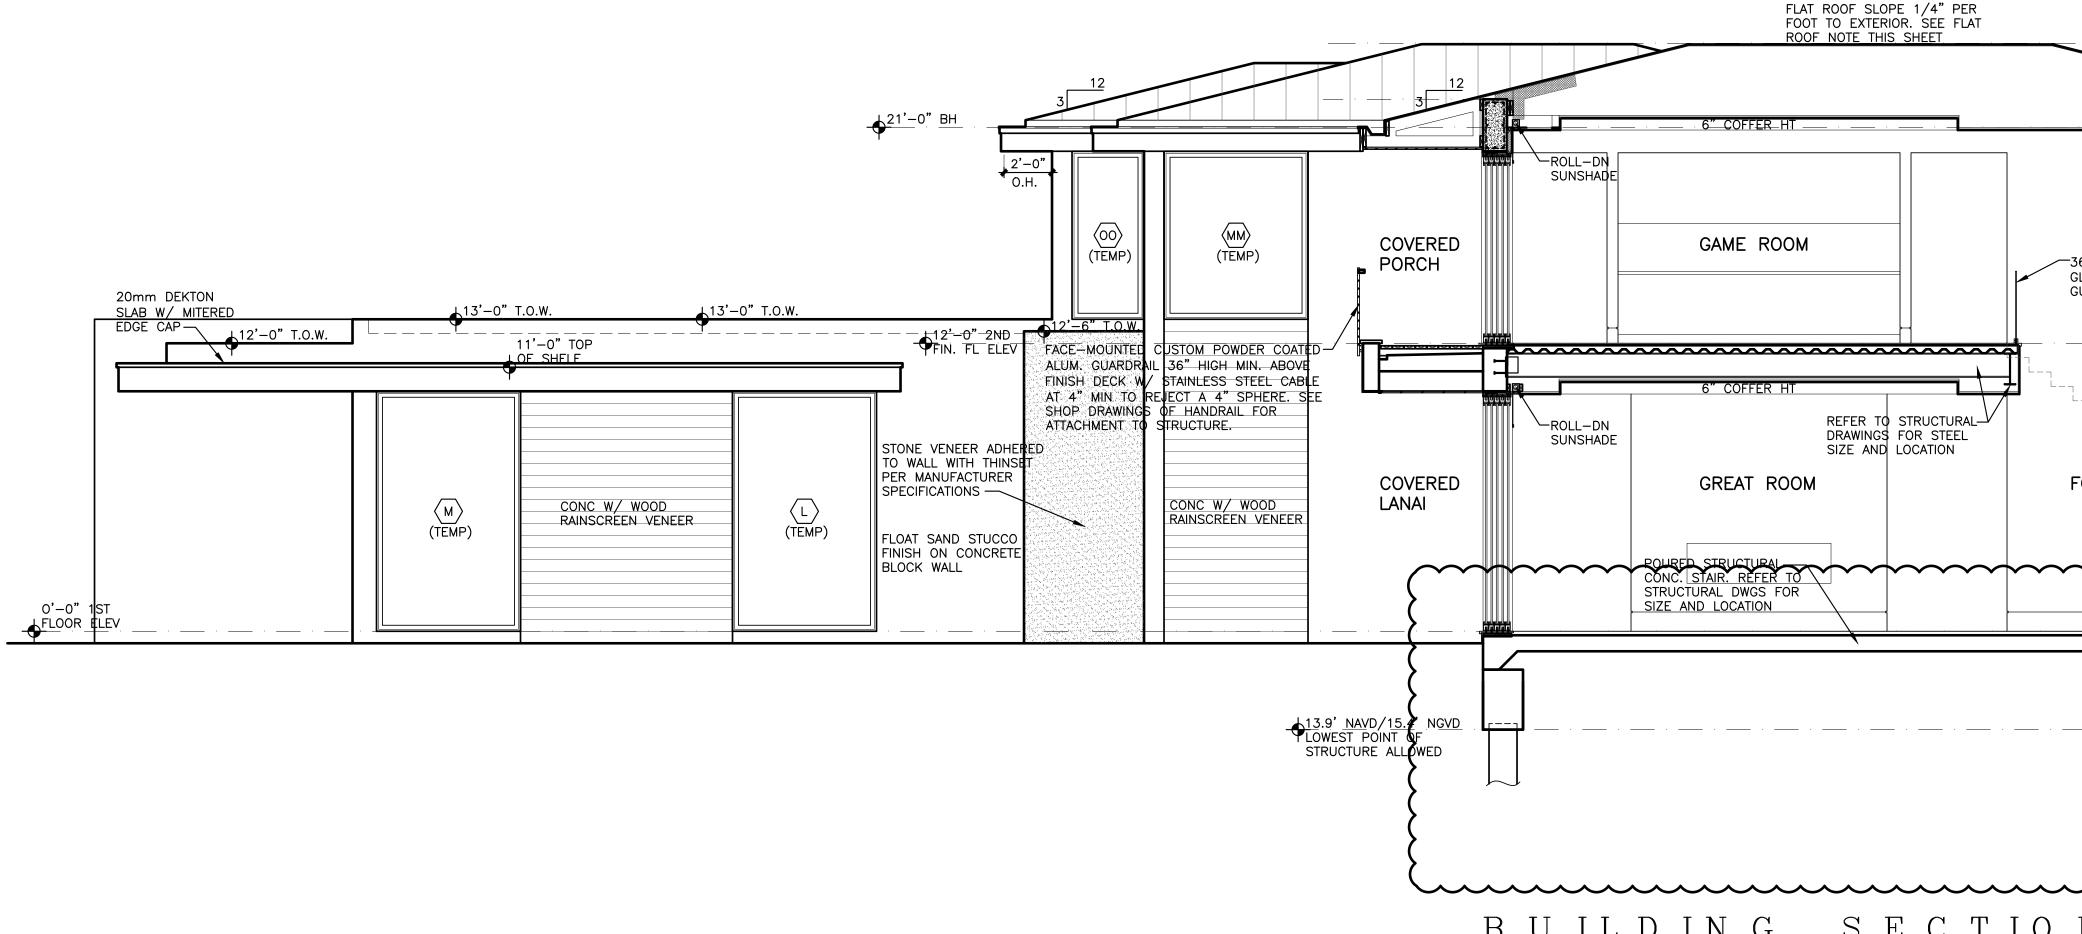



Scale: 1/4"=1'-0"	
Comm. :	Date :
23-034	9-18-23
Drawn :	Checked :
CRA	MEM

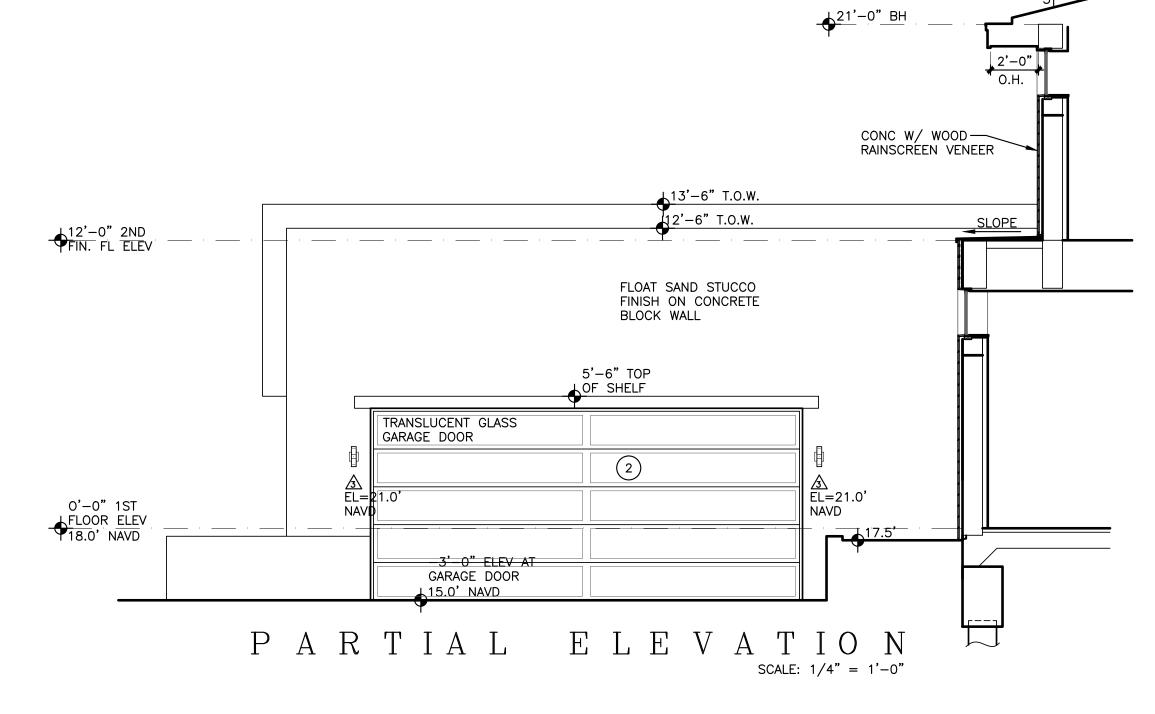

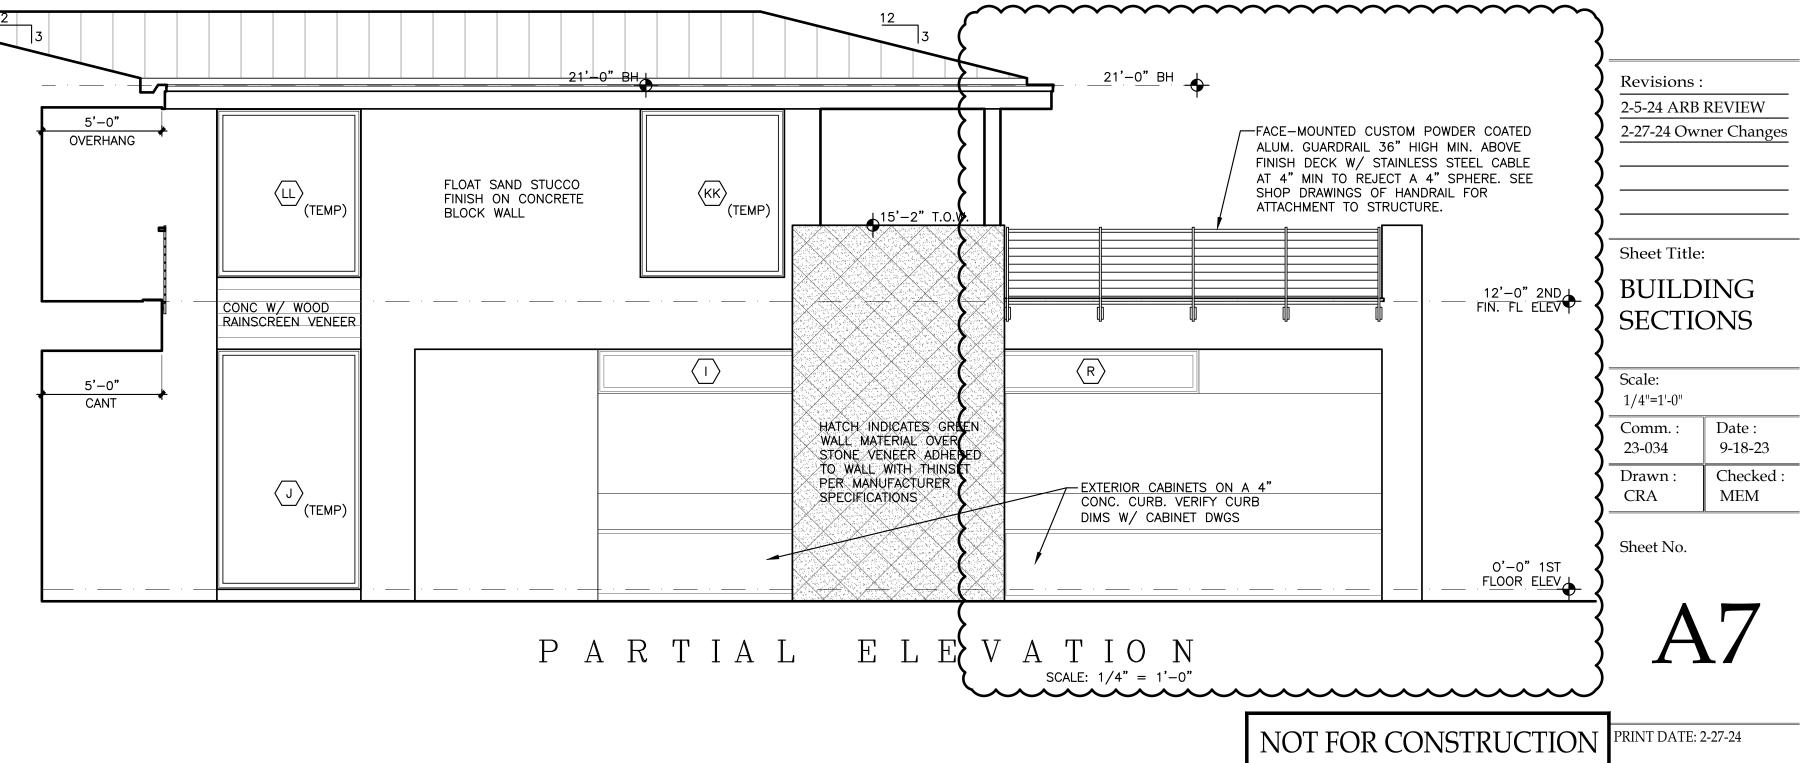

VILLAGE ARCHITECTS AIA 400 N CYPRESS DRIVE, SUITE 21 Tequesta, FL 33469 Phone: 561-743-4959 Fax: 561-743-1225 www.Village-Architects.com AA26001195

## E RESIDENC ORID Η DRIVE COL 20 OC INLE ر ا JUPITER Ε


Seal :


\_\_\_\_

Mitchell E. Miller Florida License No. AR91772 As Principal of Village Architects AIA, Inc.


Copyright 🔘 2024 Village Architects AIA All rights reserved. These drawings are the Property of the architect and are not to be used for any other projects except by agreement with The architect in writing.


Consultant:

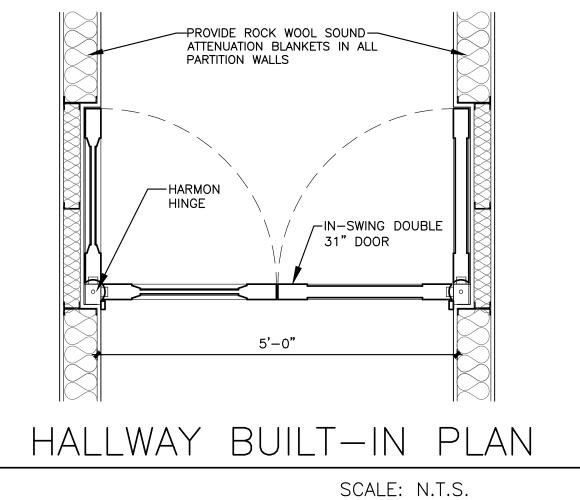

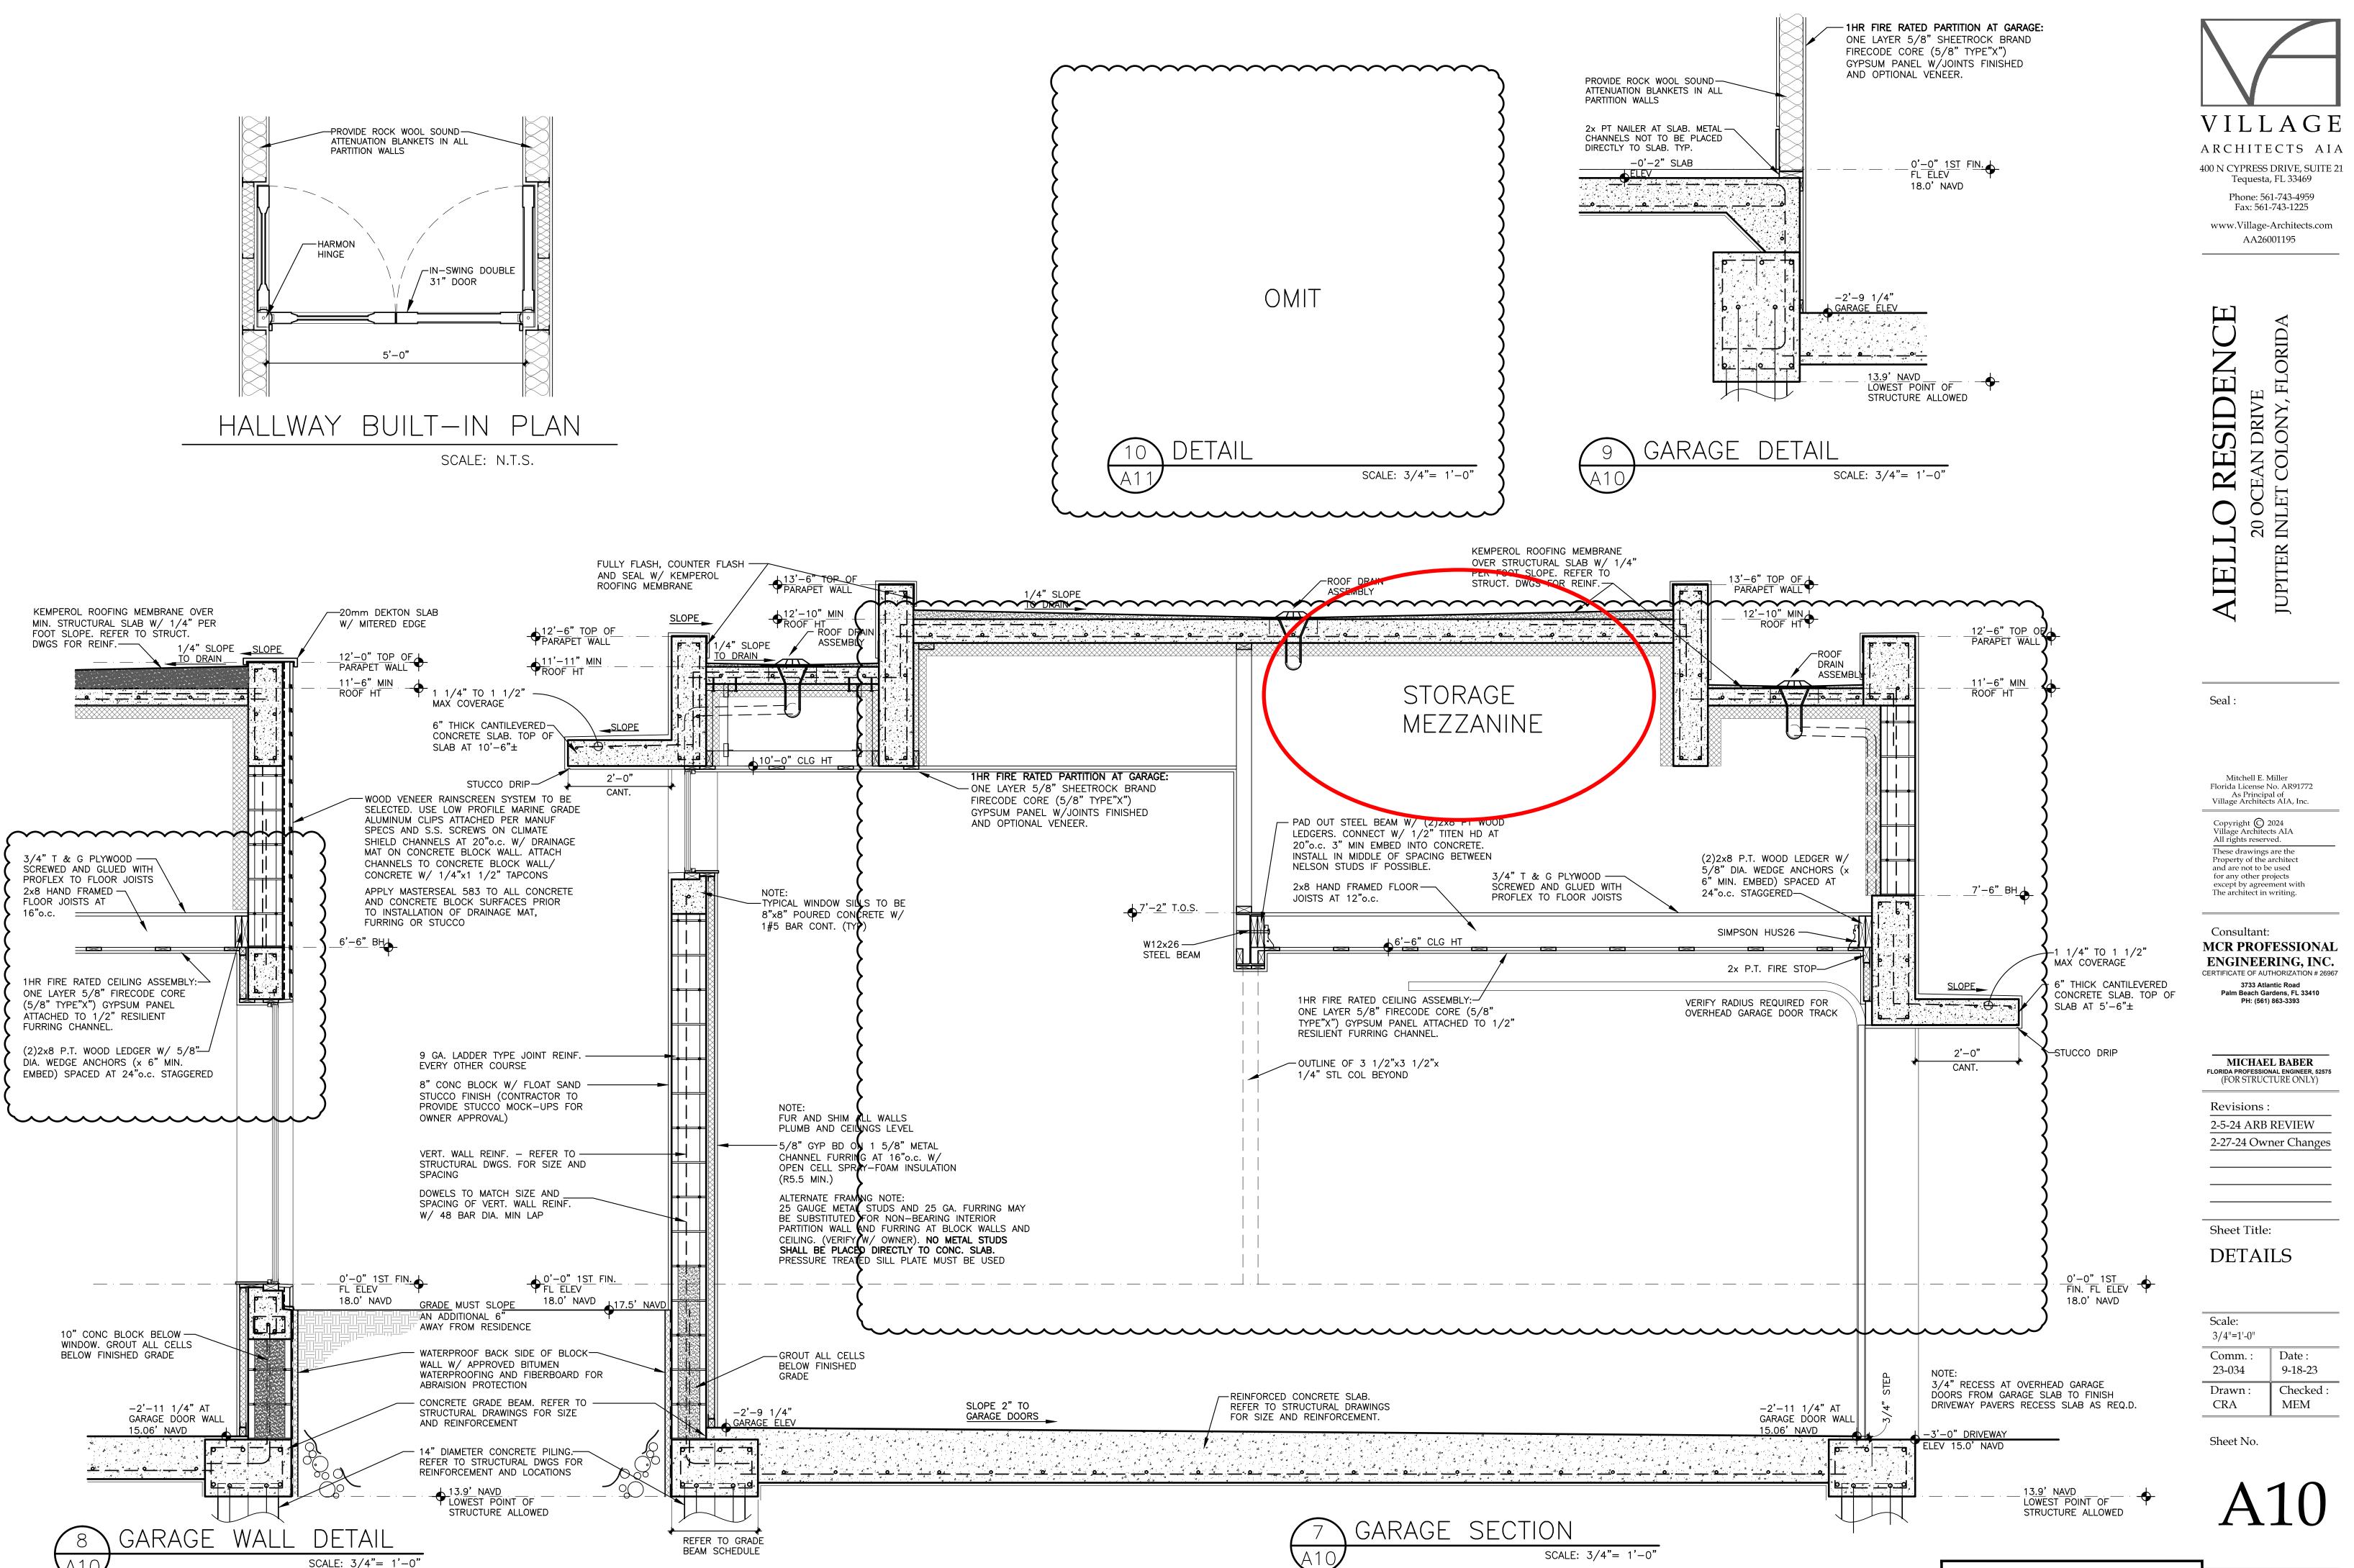


NOT FOR CONSTRUCTION PRINT DATE: 2-27-24

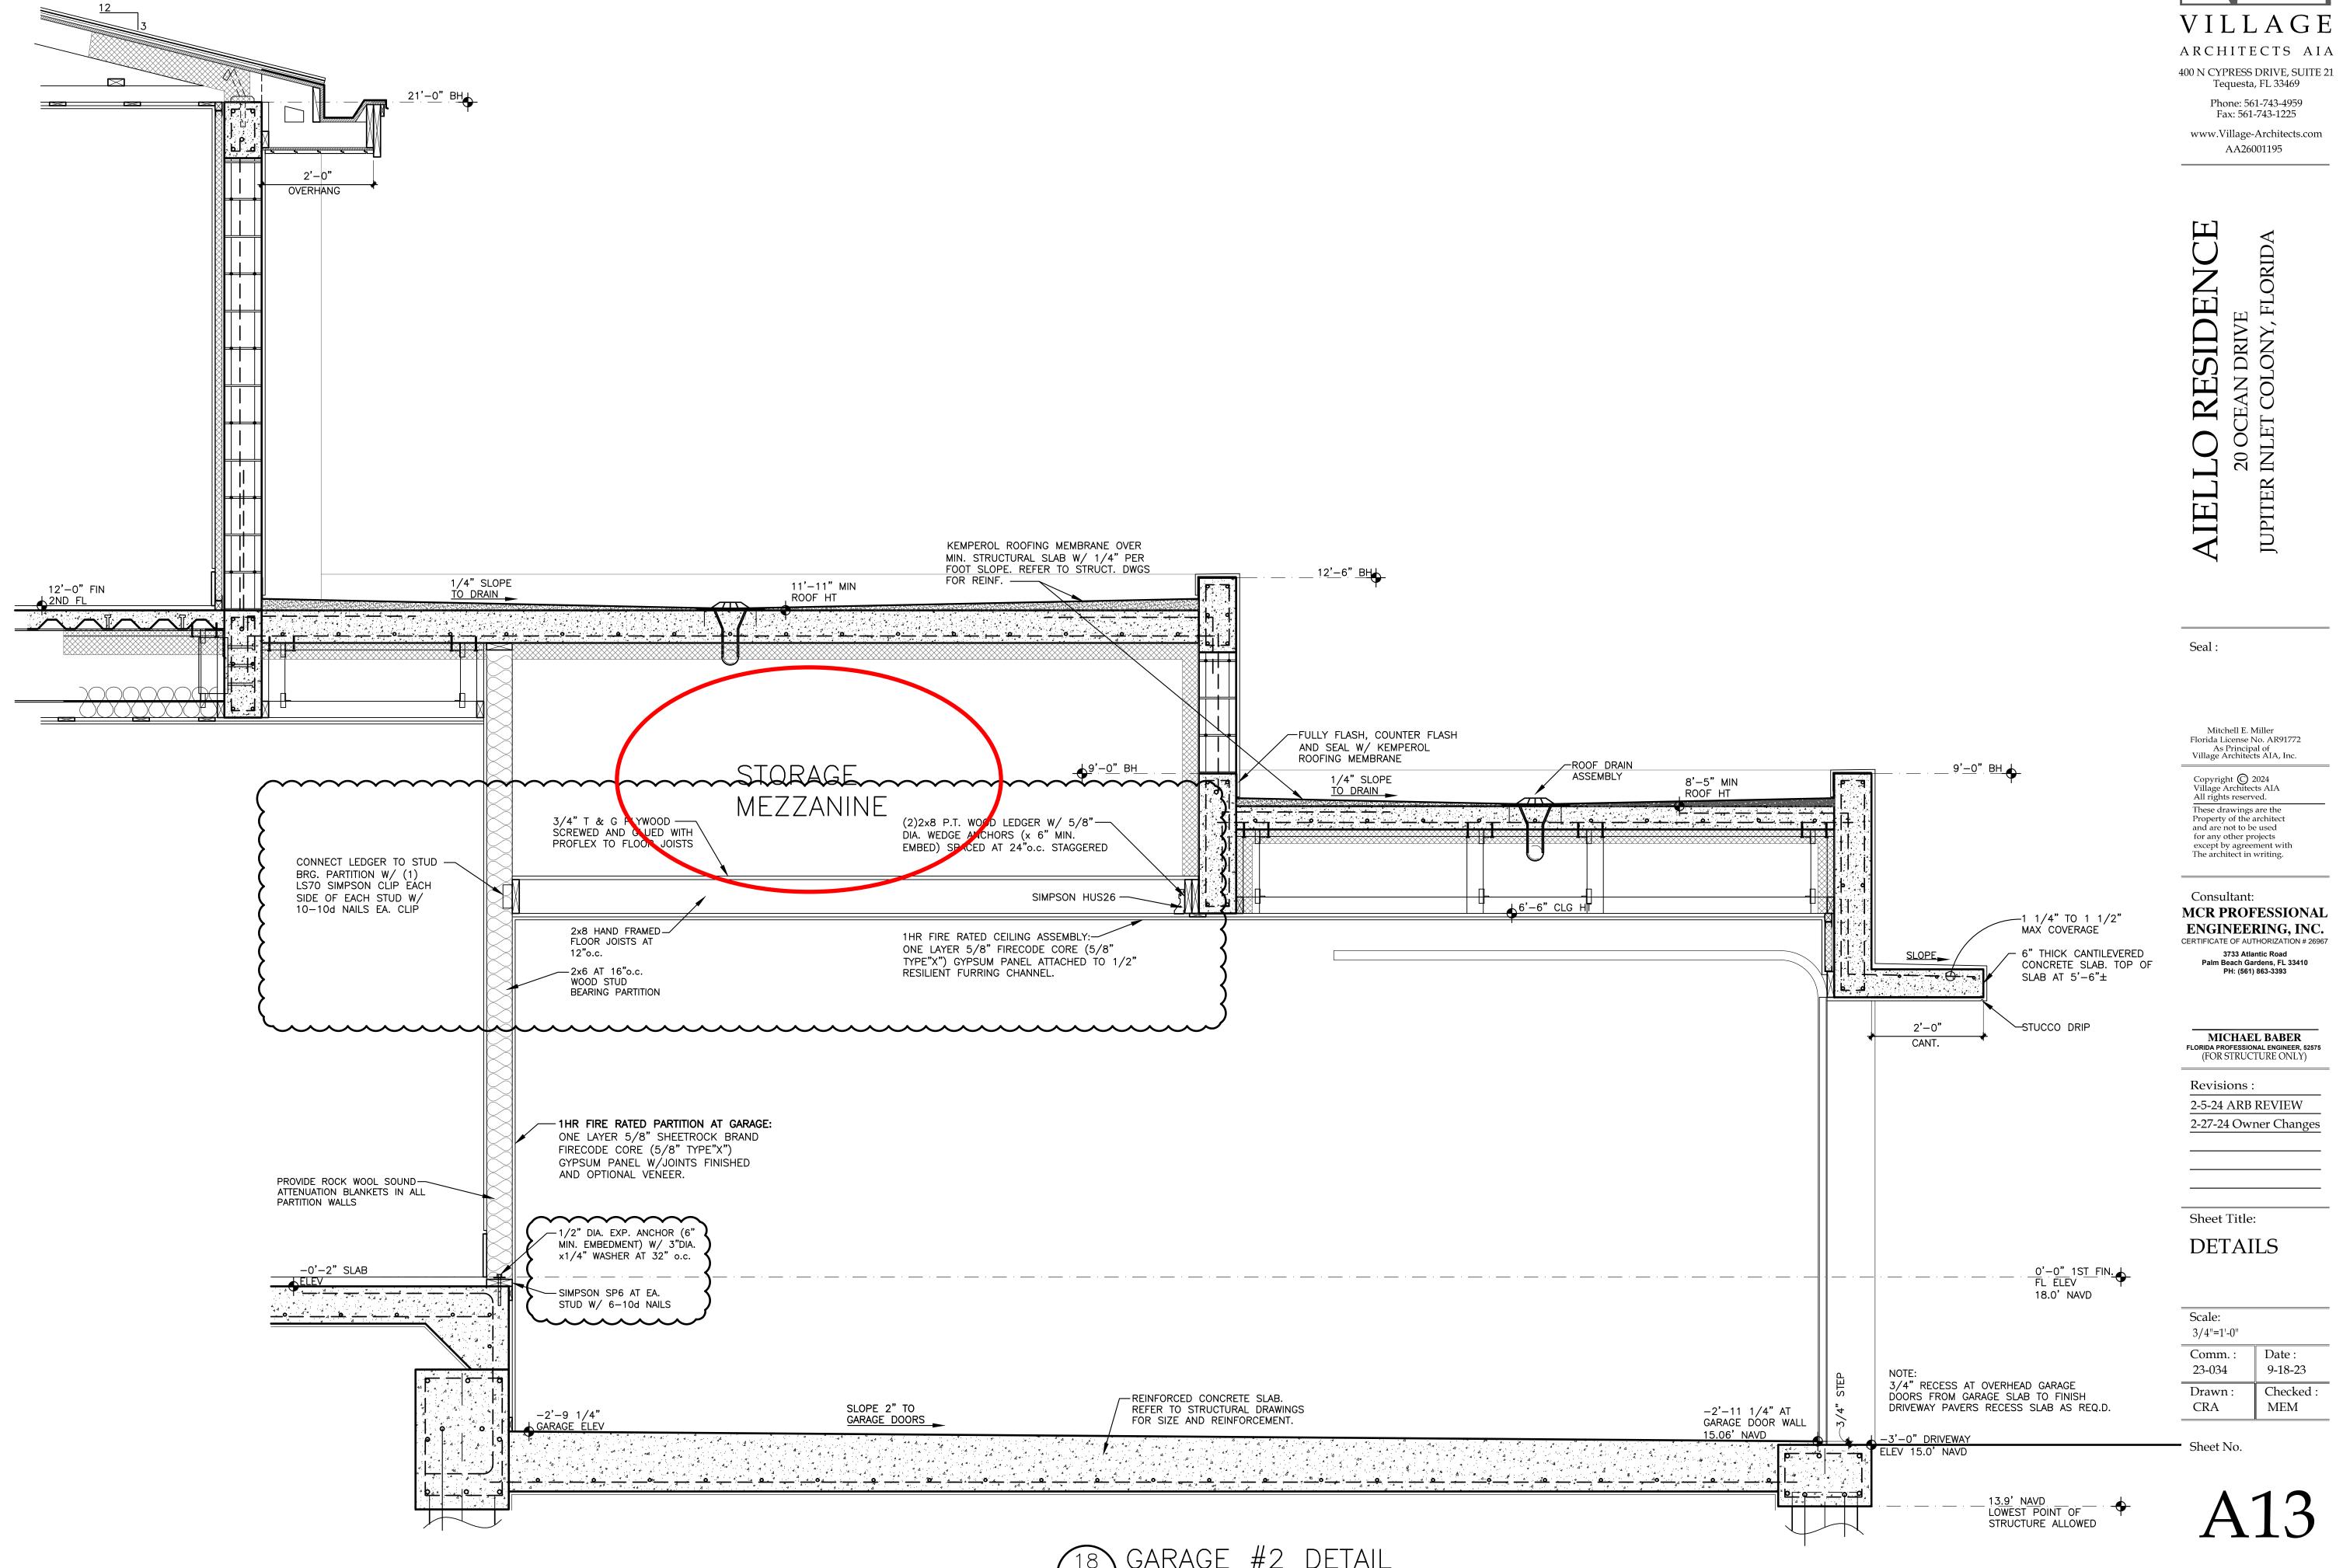


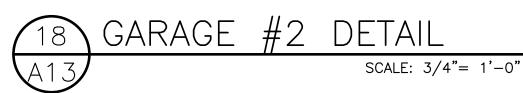






NOT FOR CONSTRUCTION PRINT DATE: 2-27-24

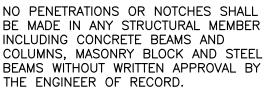


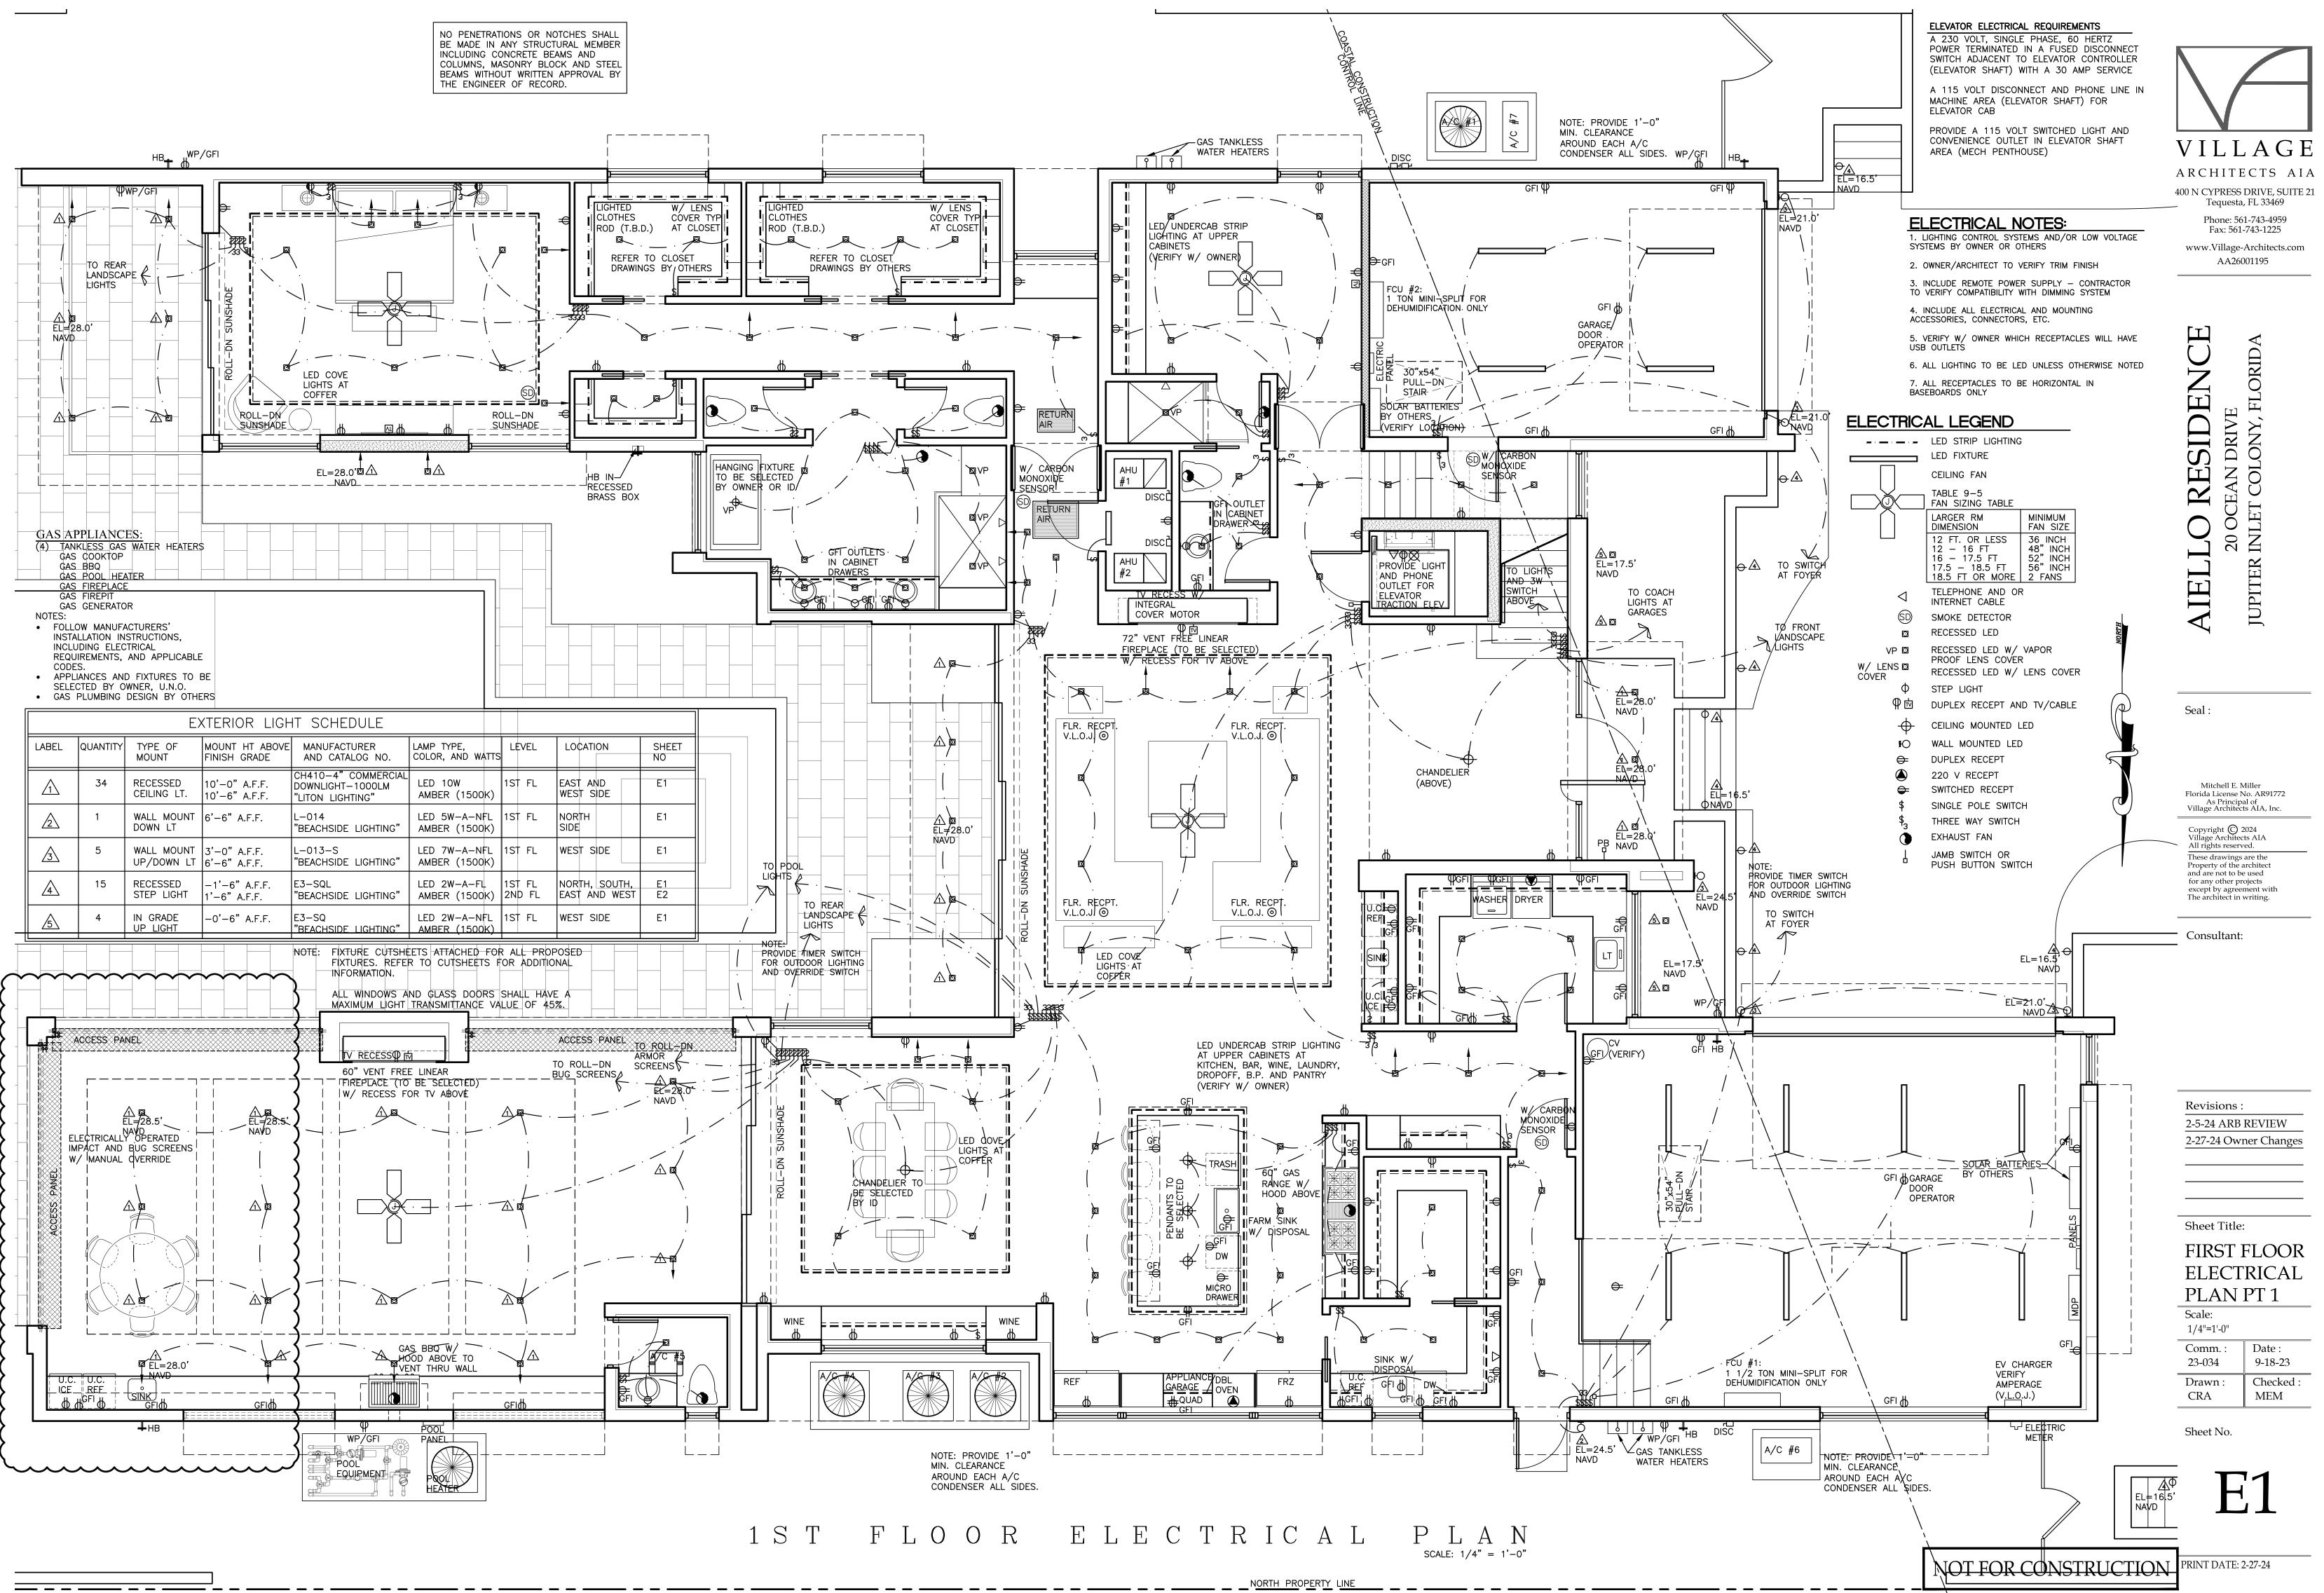


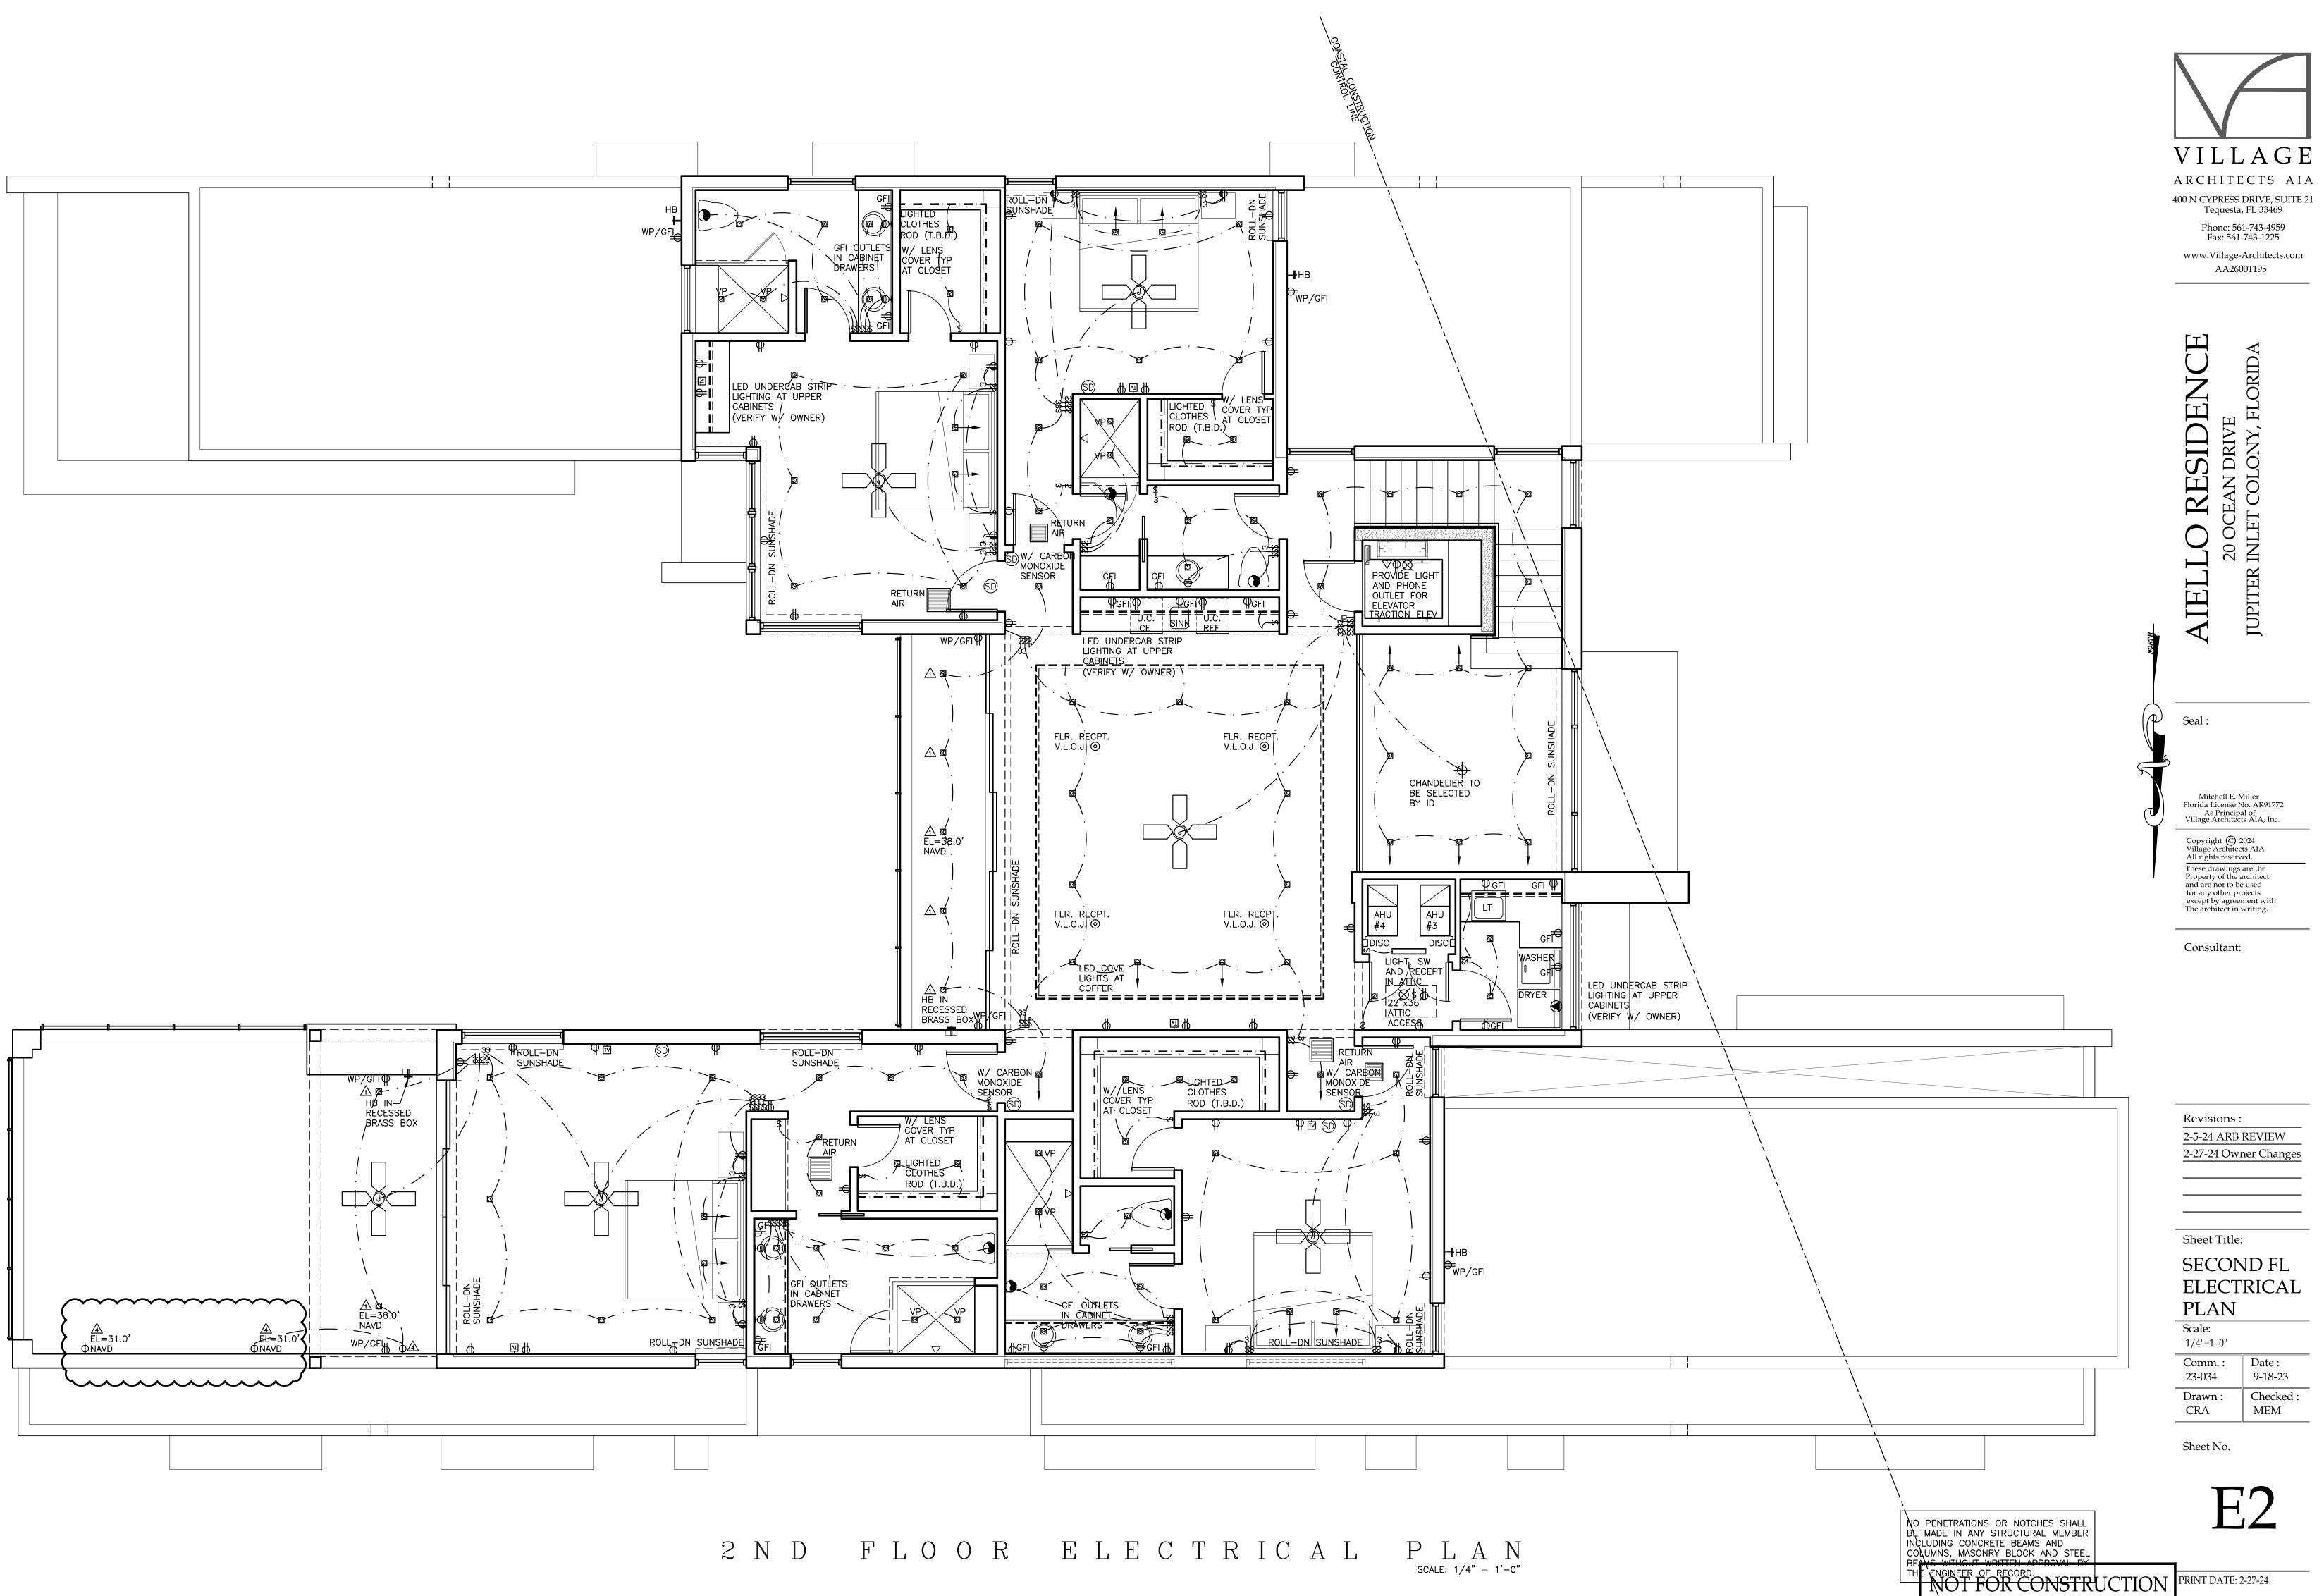


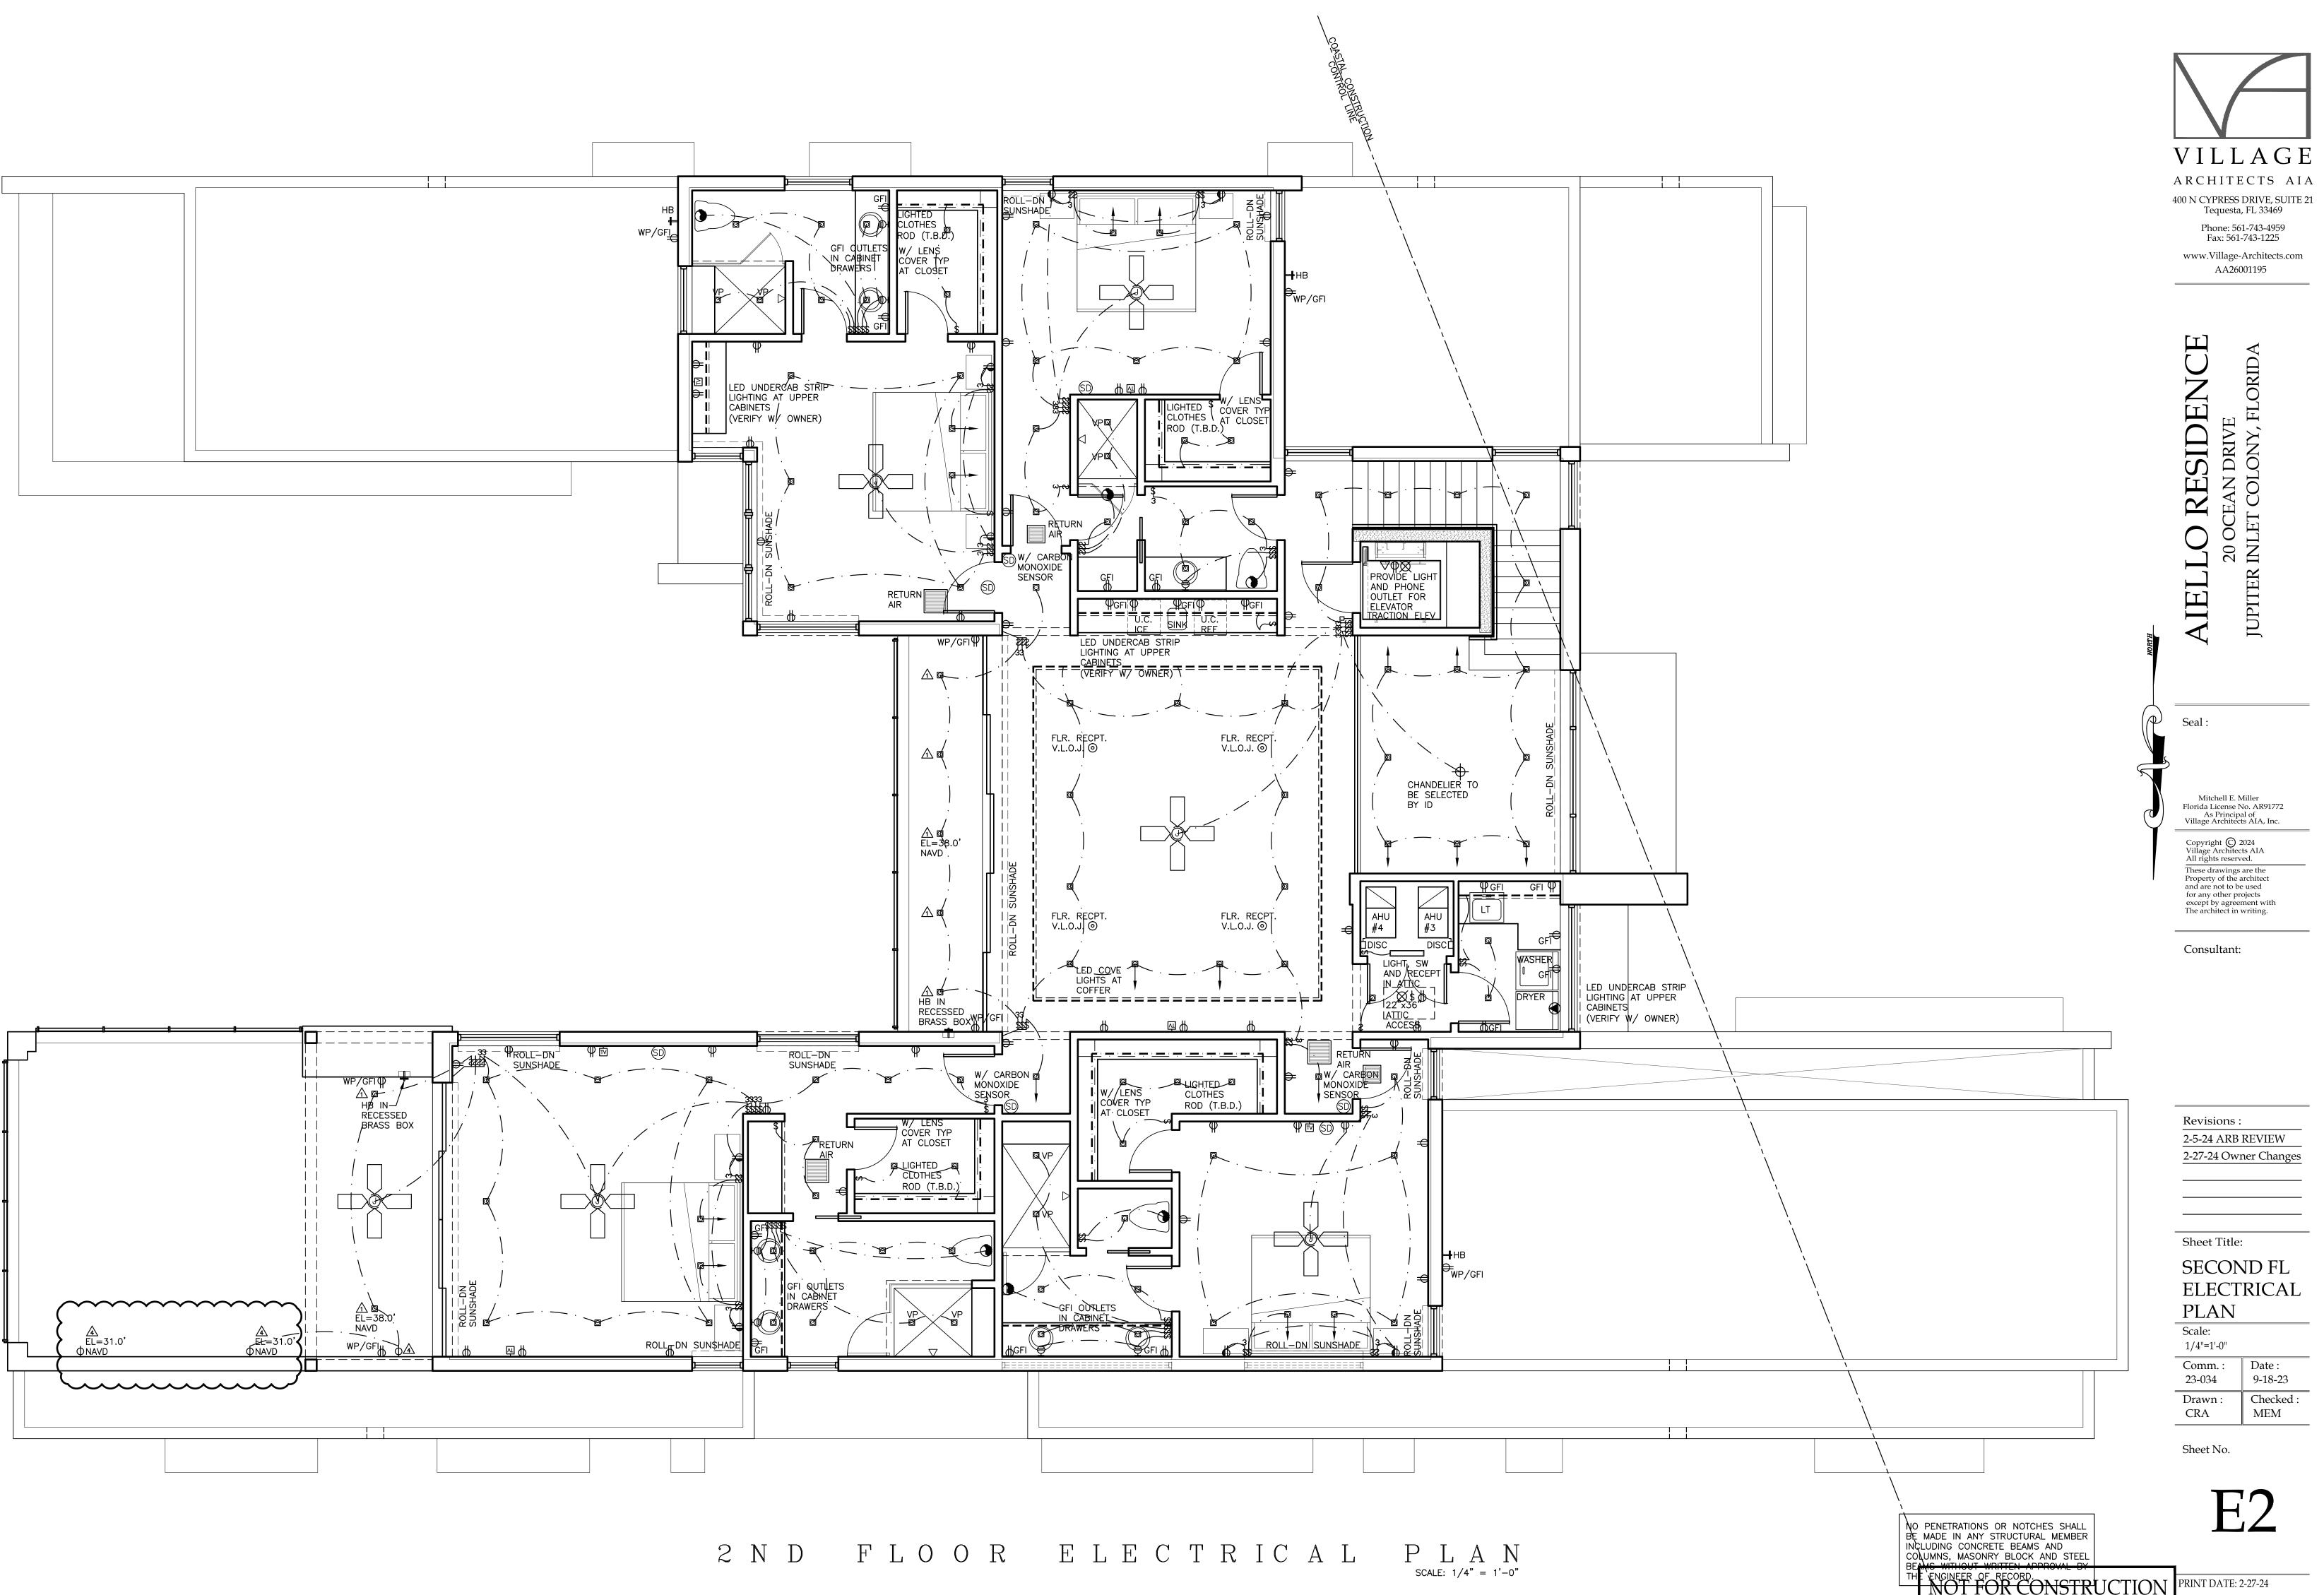

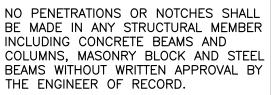


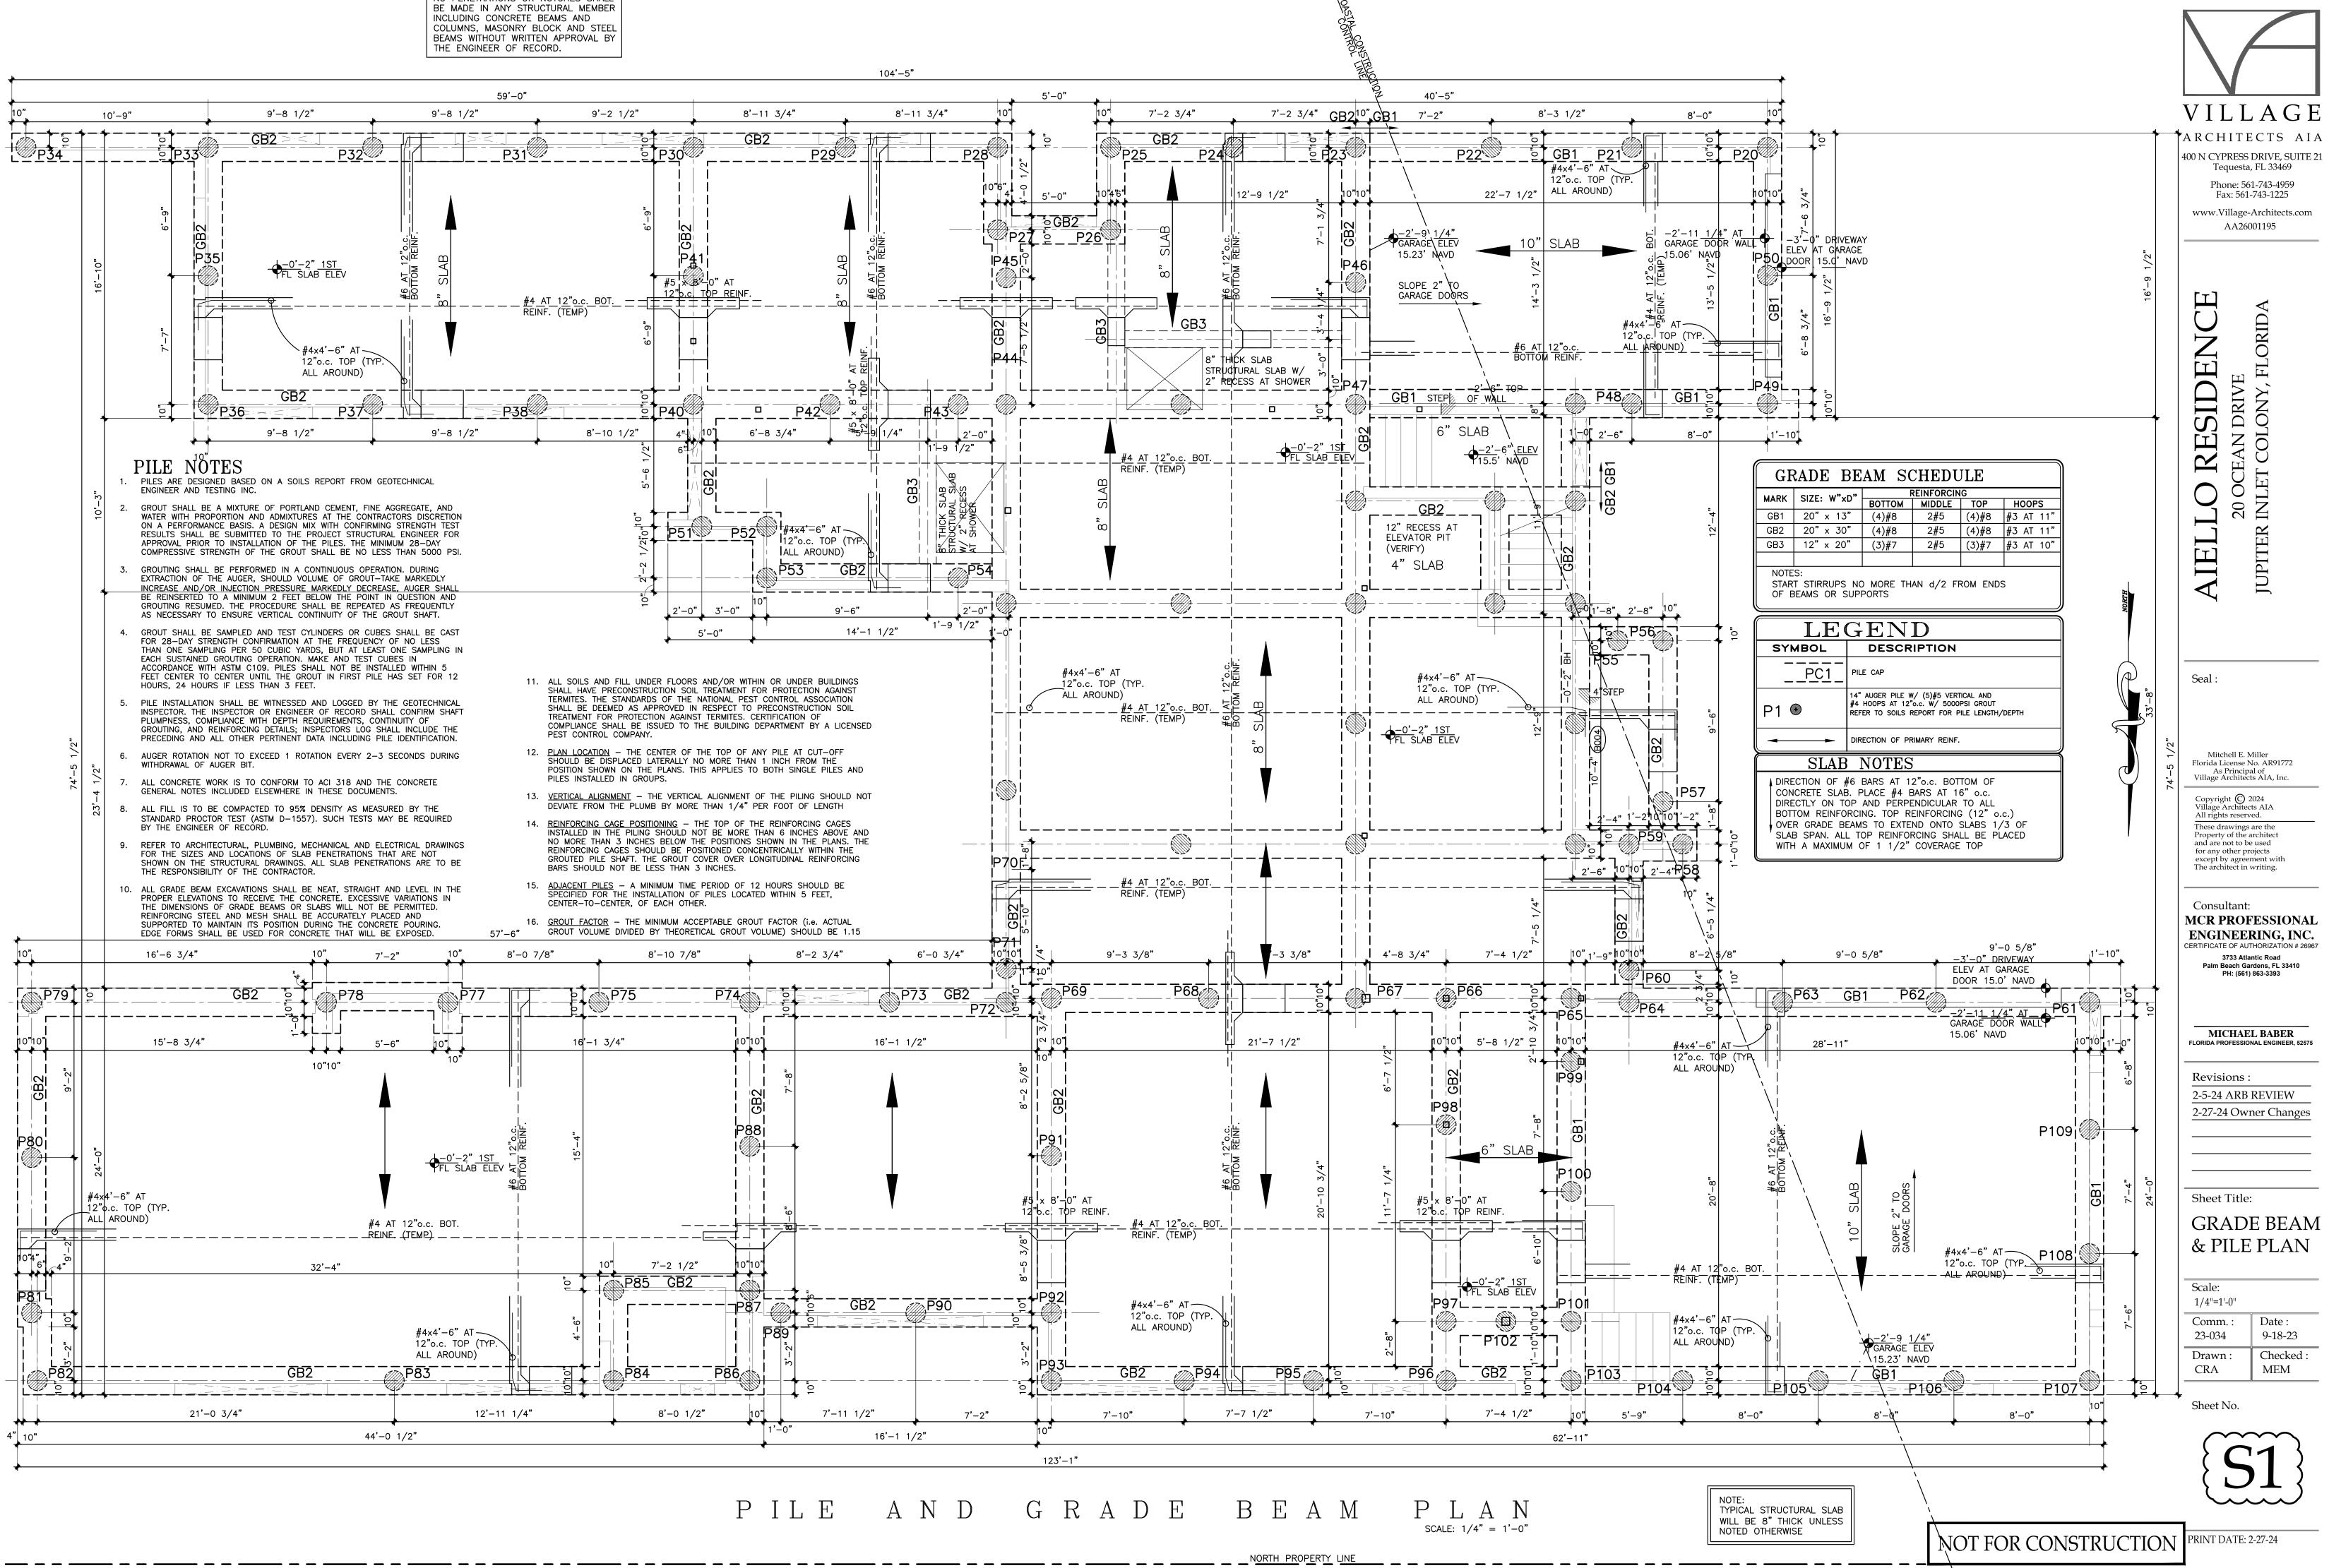


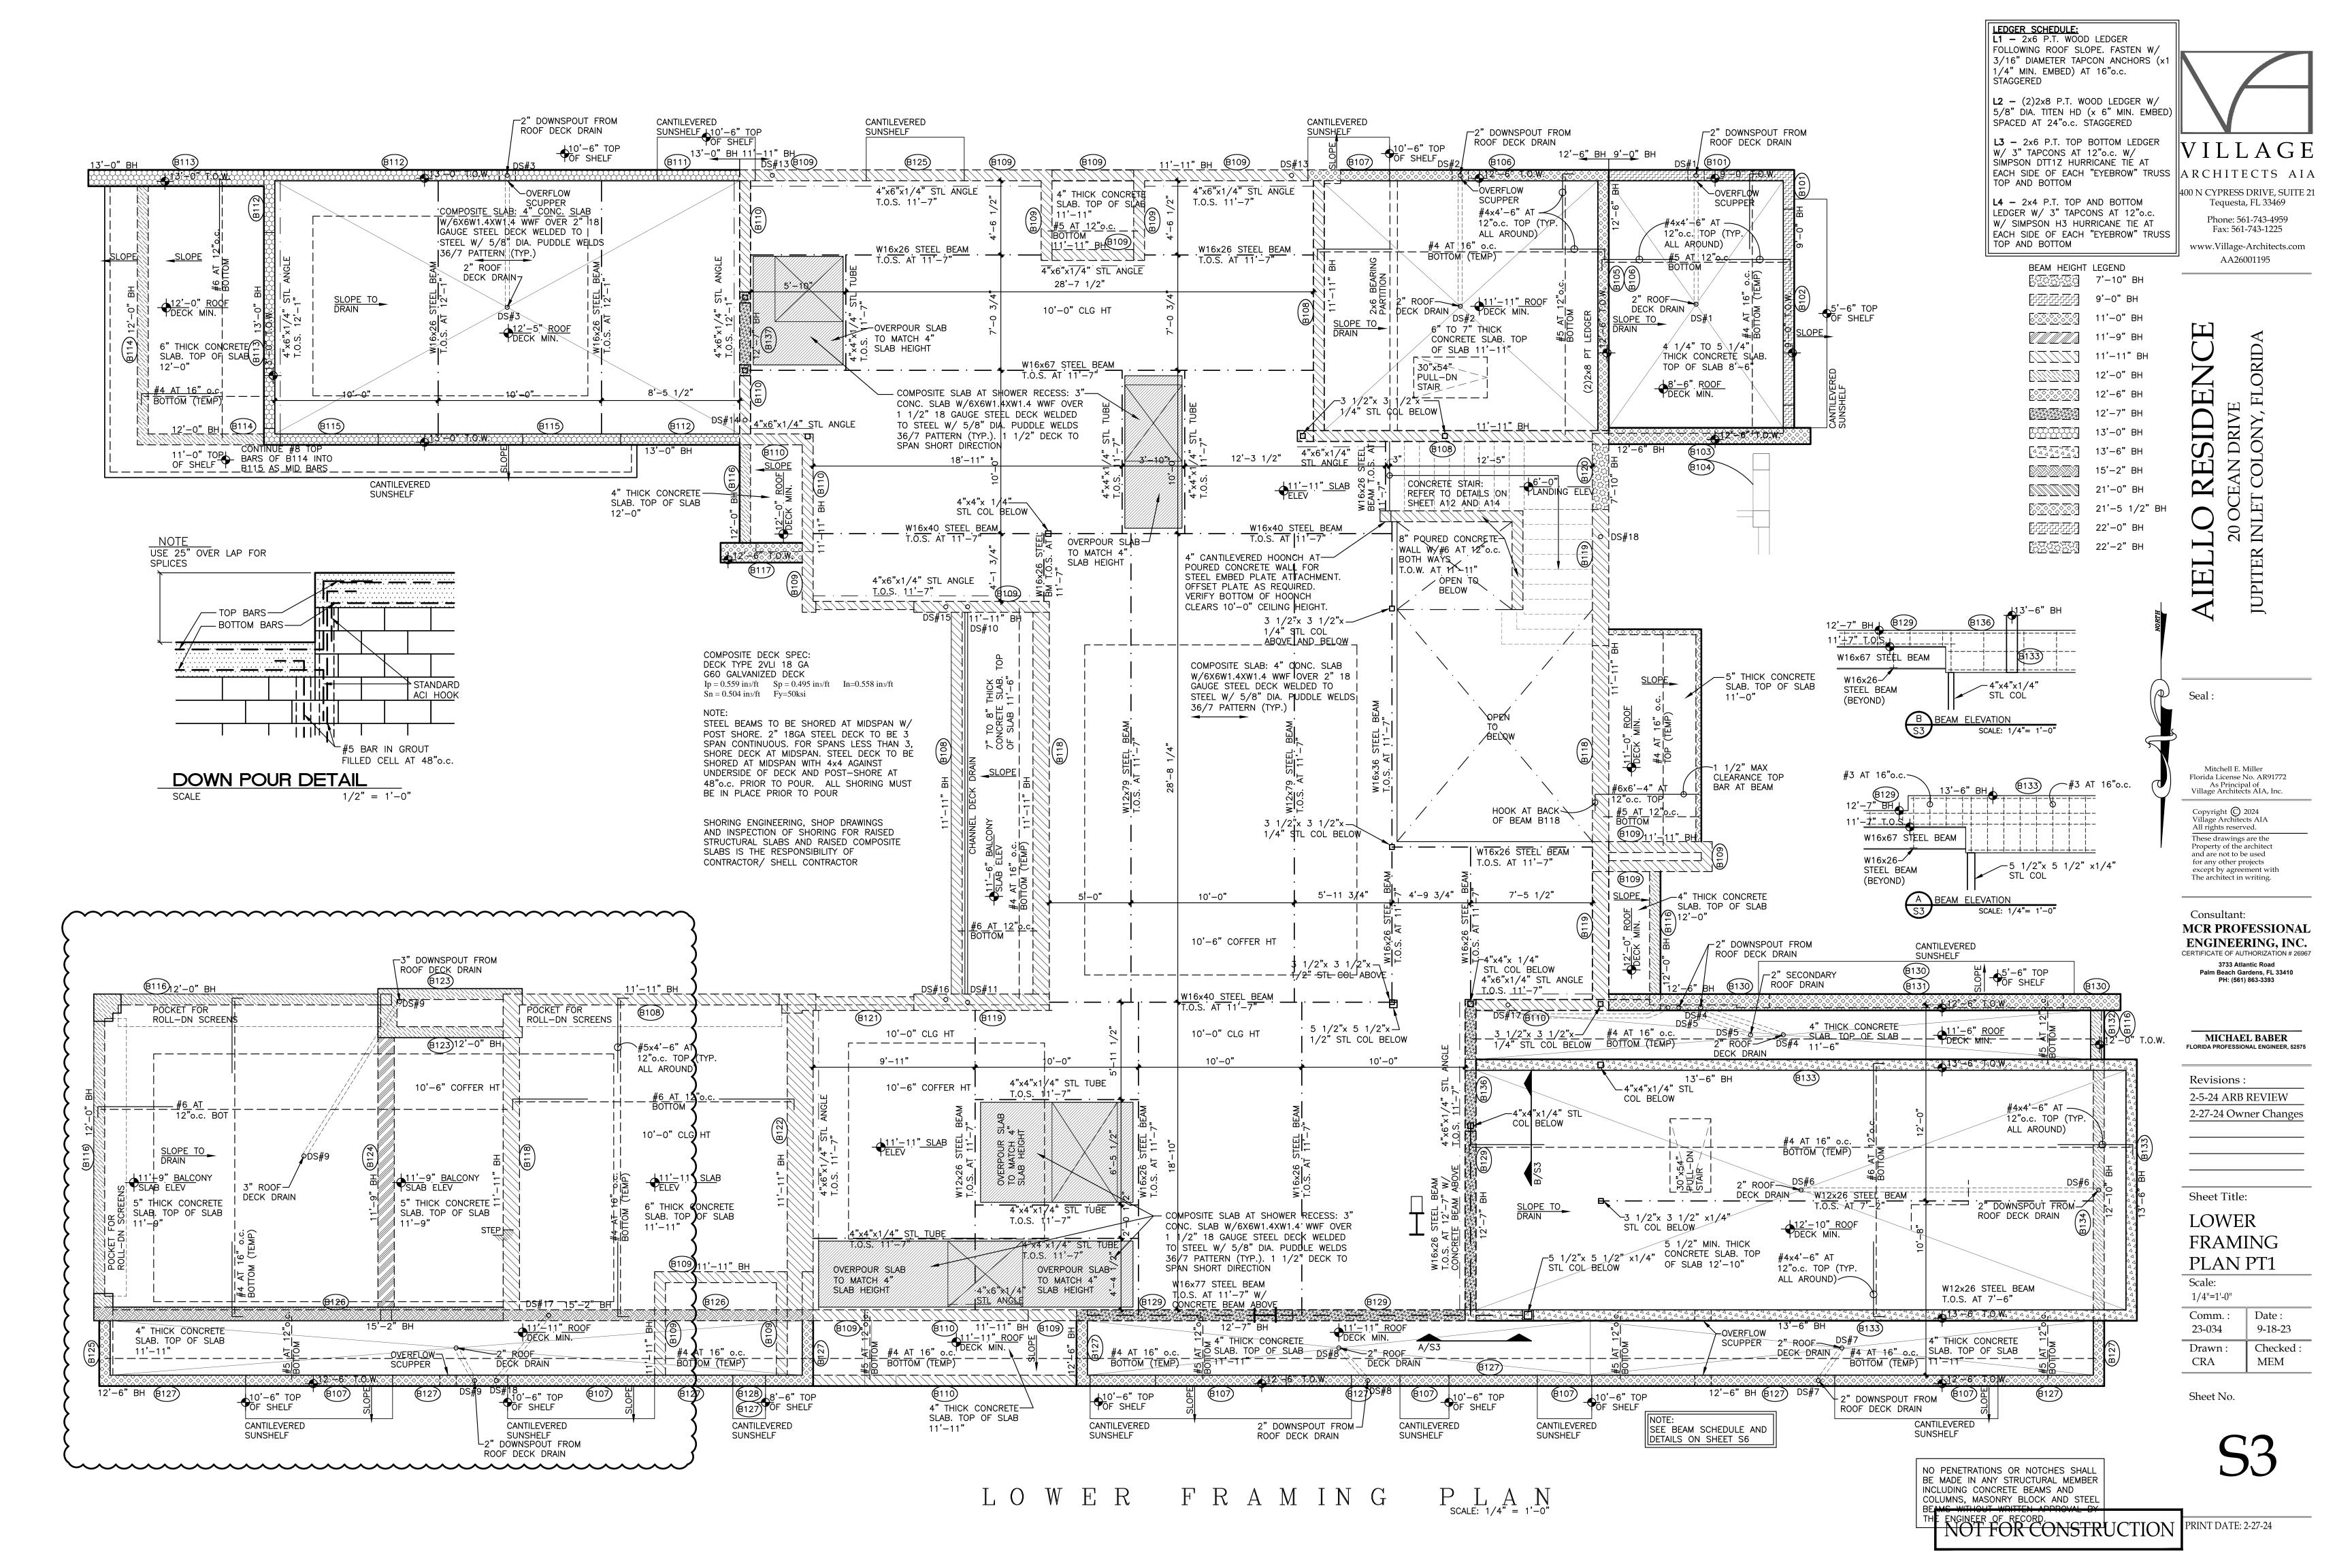


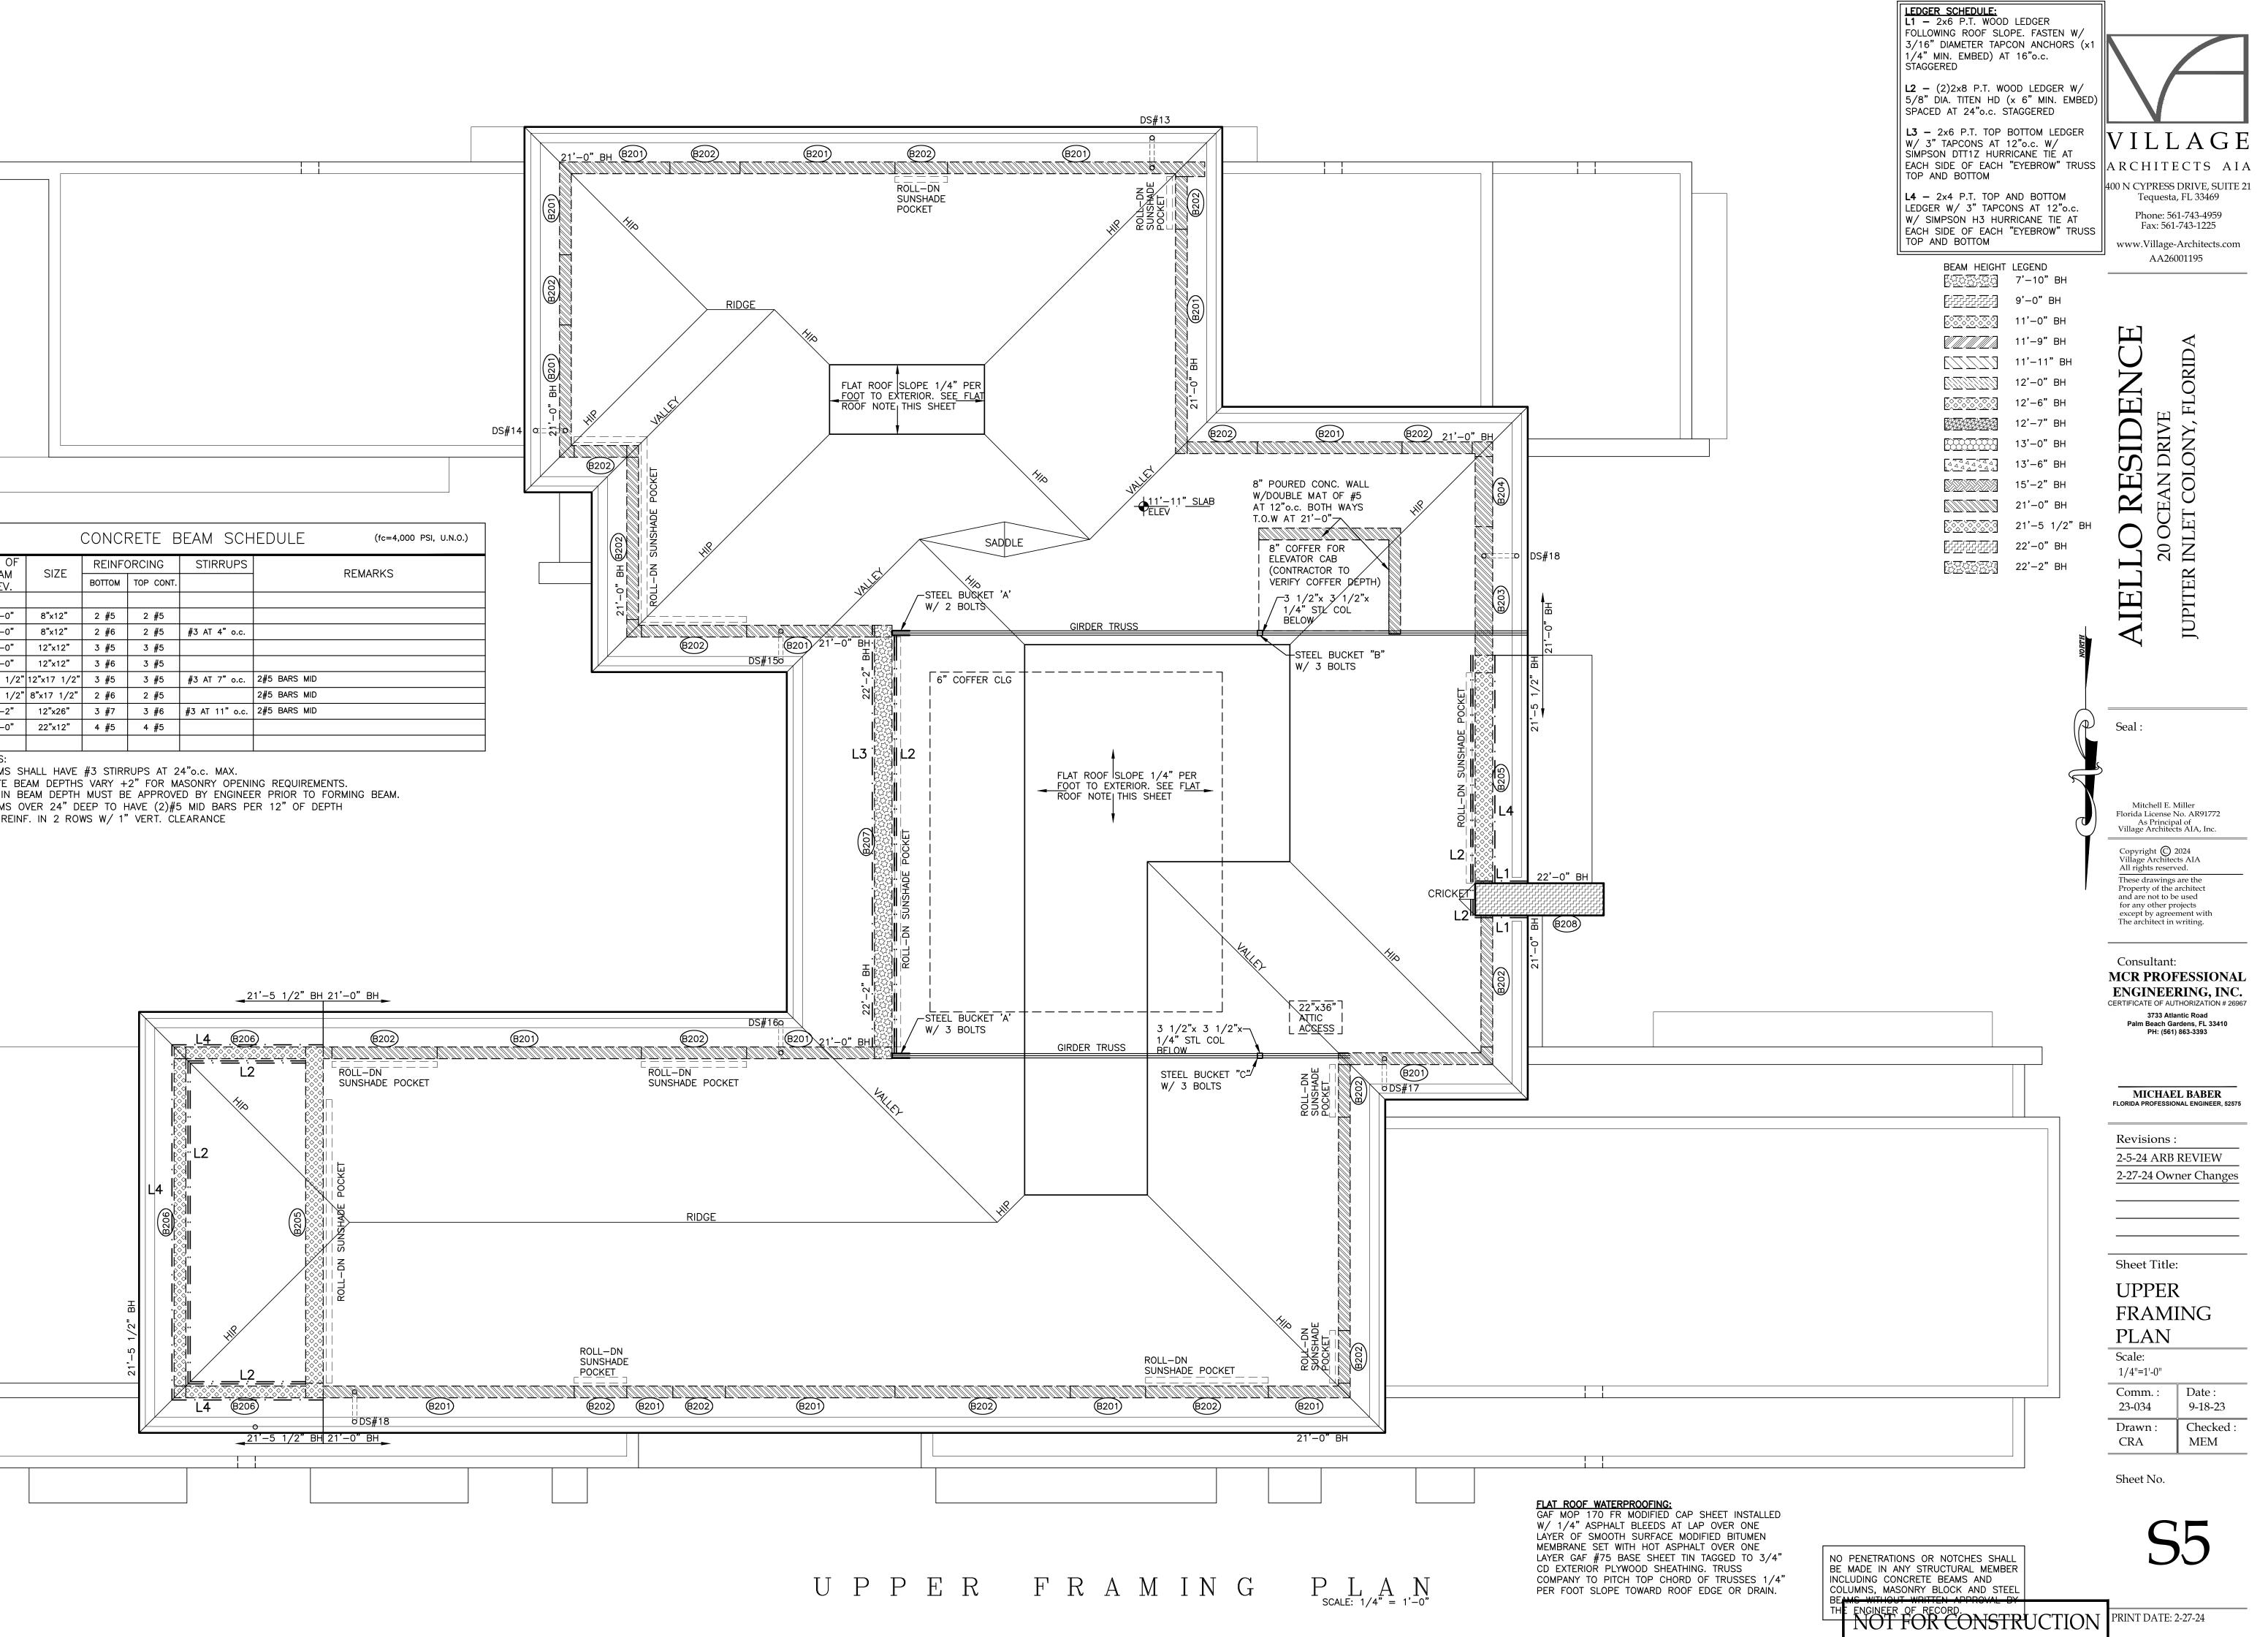

BEAM	TOP OF	SIZE	REINF	DRCING	STIRRUPS	REMARKS
No.	BEAM ELEV.	SIZE	воттом	TOP CONT.		ILMARKS
B201	21'-0"	8"x12"	2 <b>#</b> 5	2 <b>#</b> 5		
B202	21'-0"	8"x12"	2 <b>#</b> 6	2 <b>#</b> 5	#3 AT 4" o.c.	
B203	21'-0"	12"x12"	3 <b>#</b> 5	3 <b>#</b> 5		
B204	21'-0"	12"x12"	3 <b>#</b> 6	3 <b>#</b> 5		
B205	21'-5 1/2"	12"x17 1/2"	3 <b>#</b> 5	3 <b>#</b> 5	#3 AT 7" o.c.	2#5 BARS MID
B206	21'-5 1/2"	8"x17 1/2"	2 <b>#</b> 6	2 <b>#</b> 5		2#5 BARS MID
B207	22'-2"	12"x26"	3 <b>#</b> 7	3 <b>#</b> 6	#3 AT 11" o.c.	2#5 BARS MID
B208	22'-0"	22 <b>"</b> x12"	4 <b>#</b> 5	4 <b>#</b> 5		

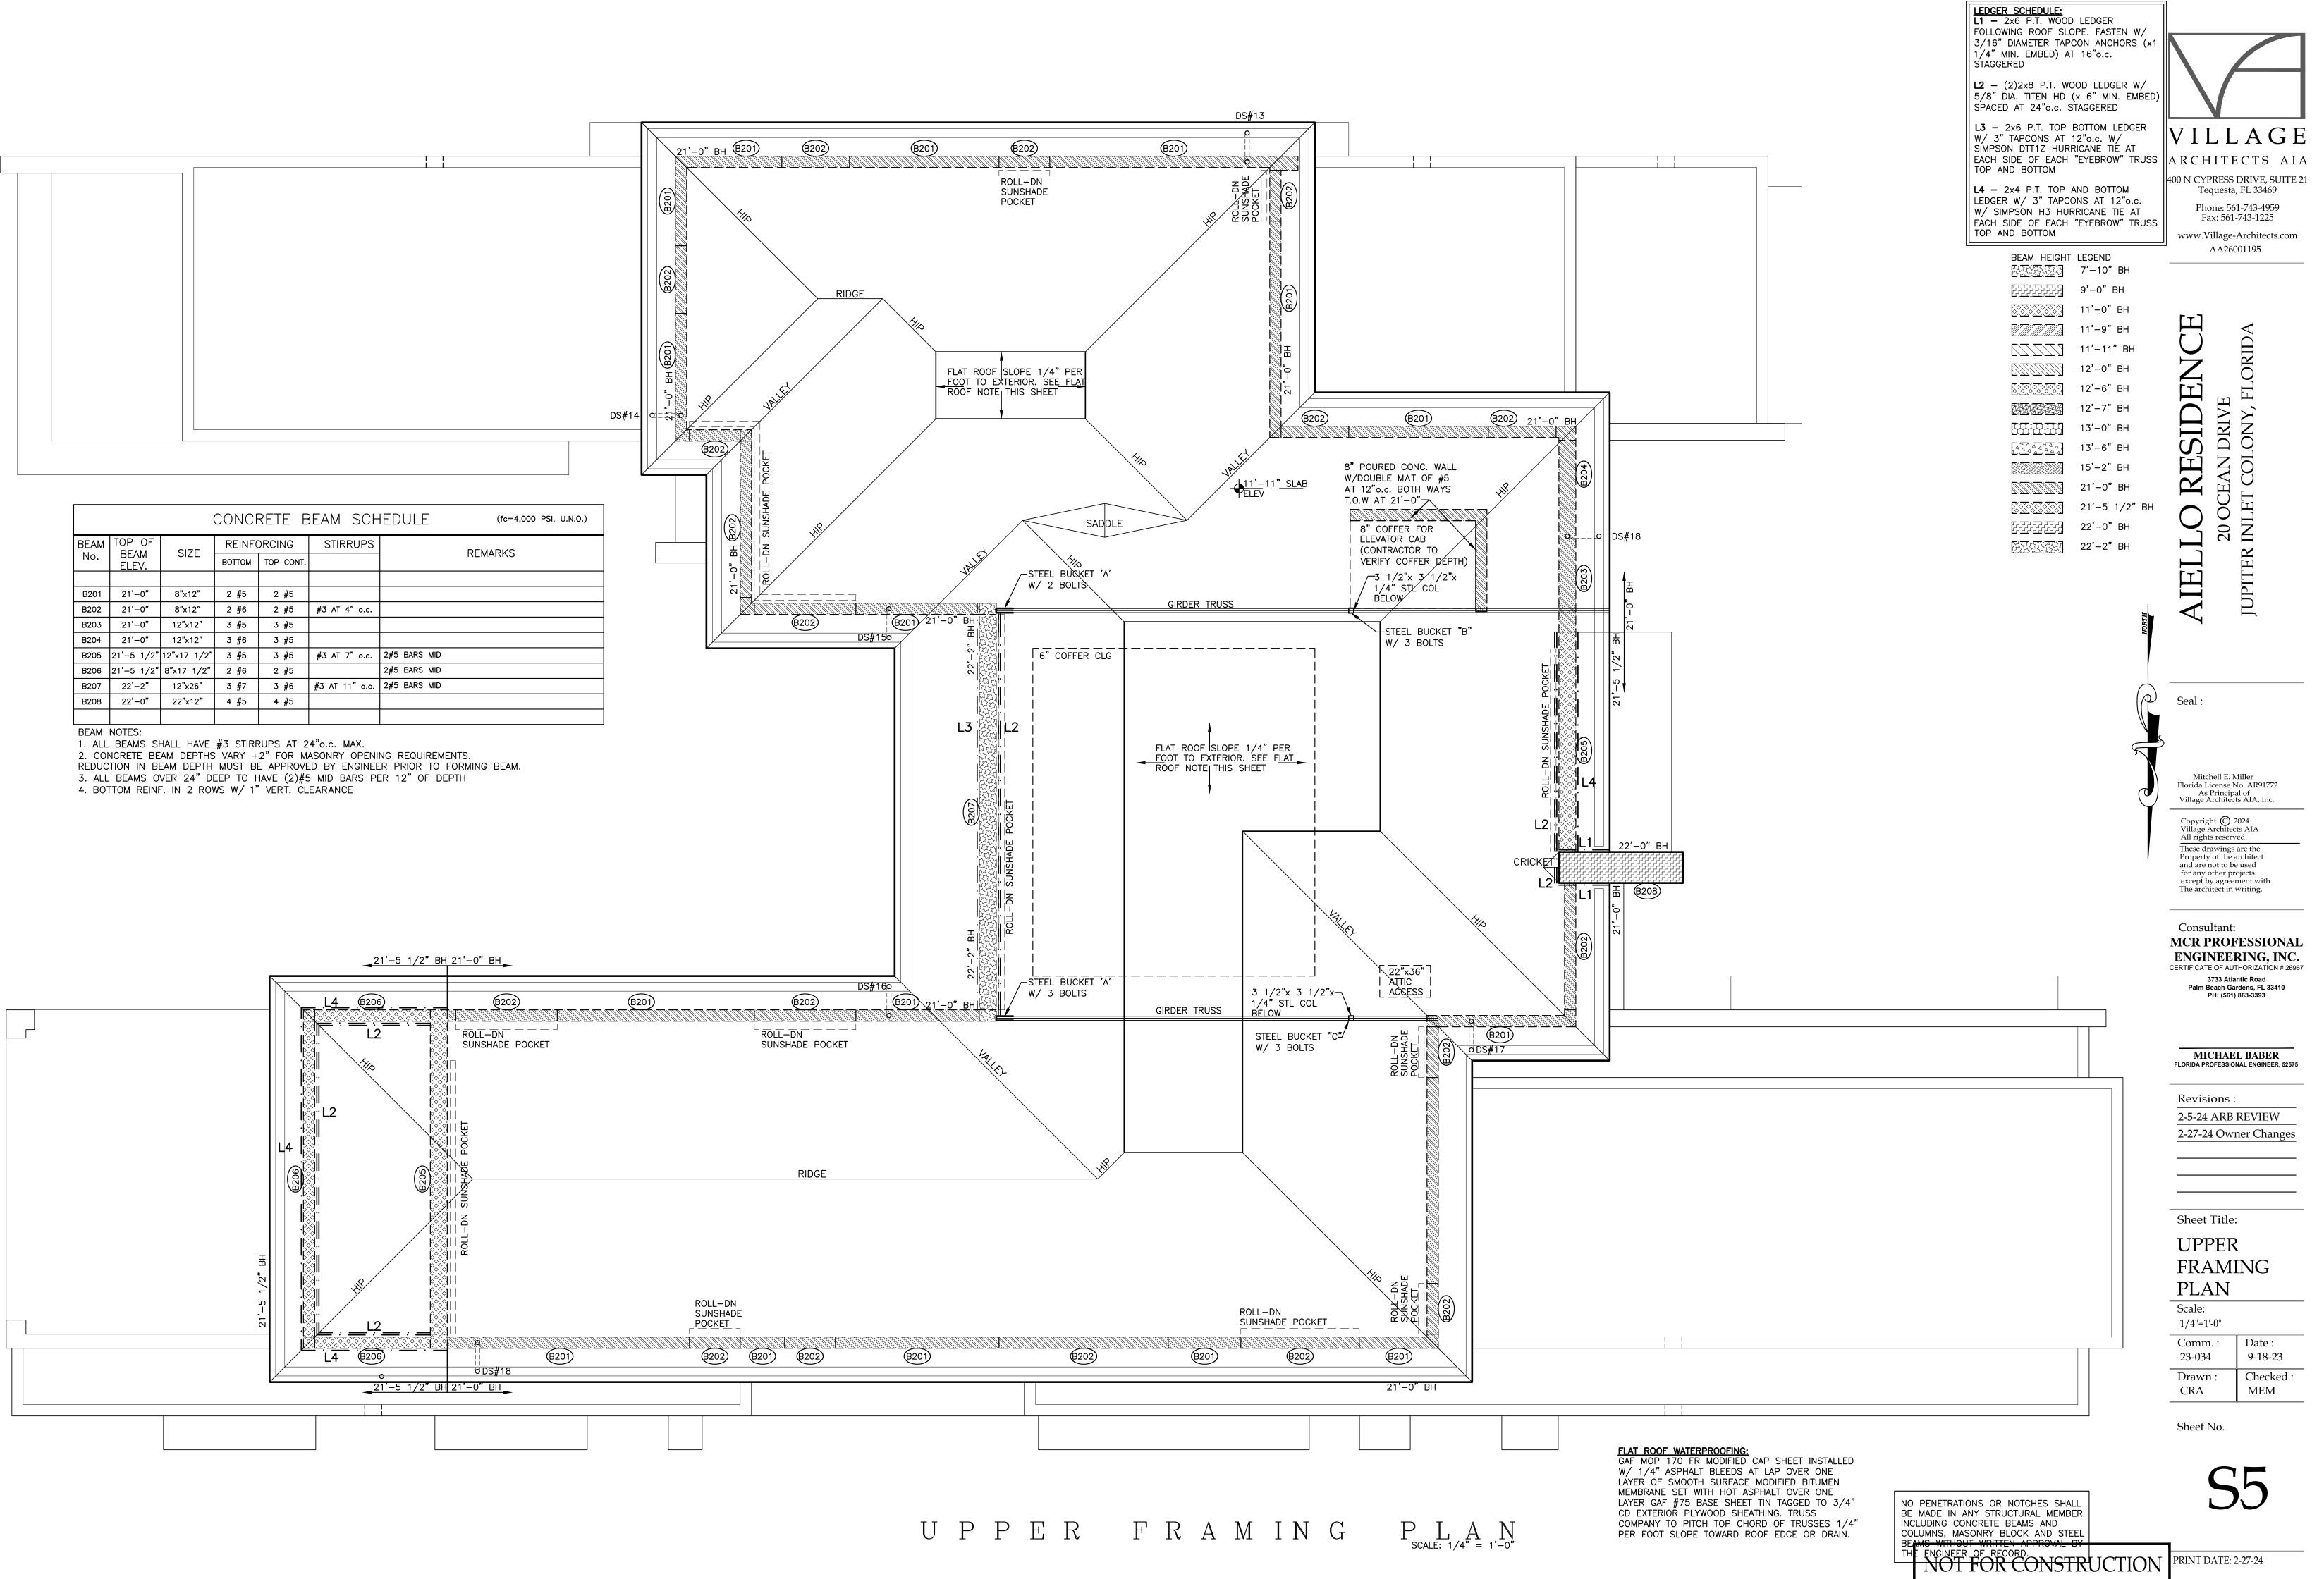

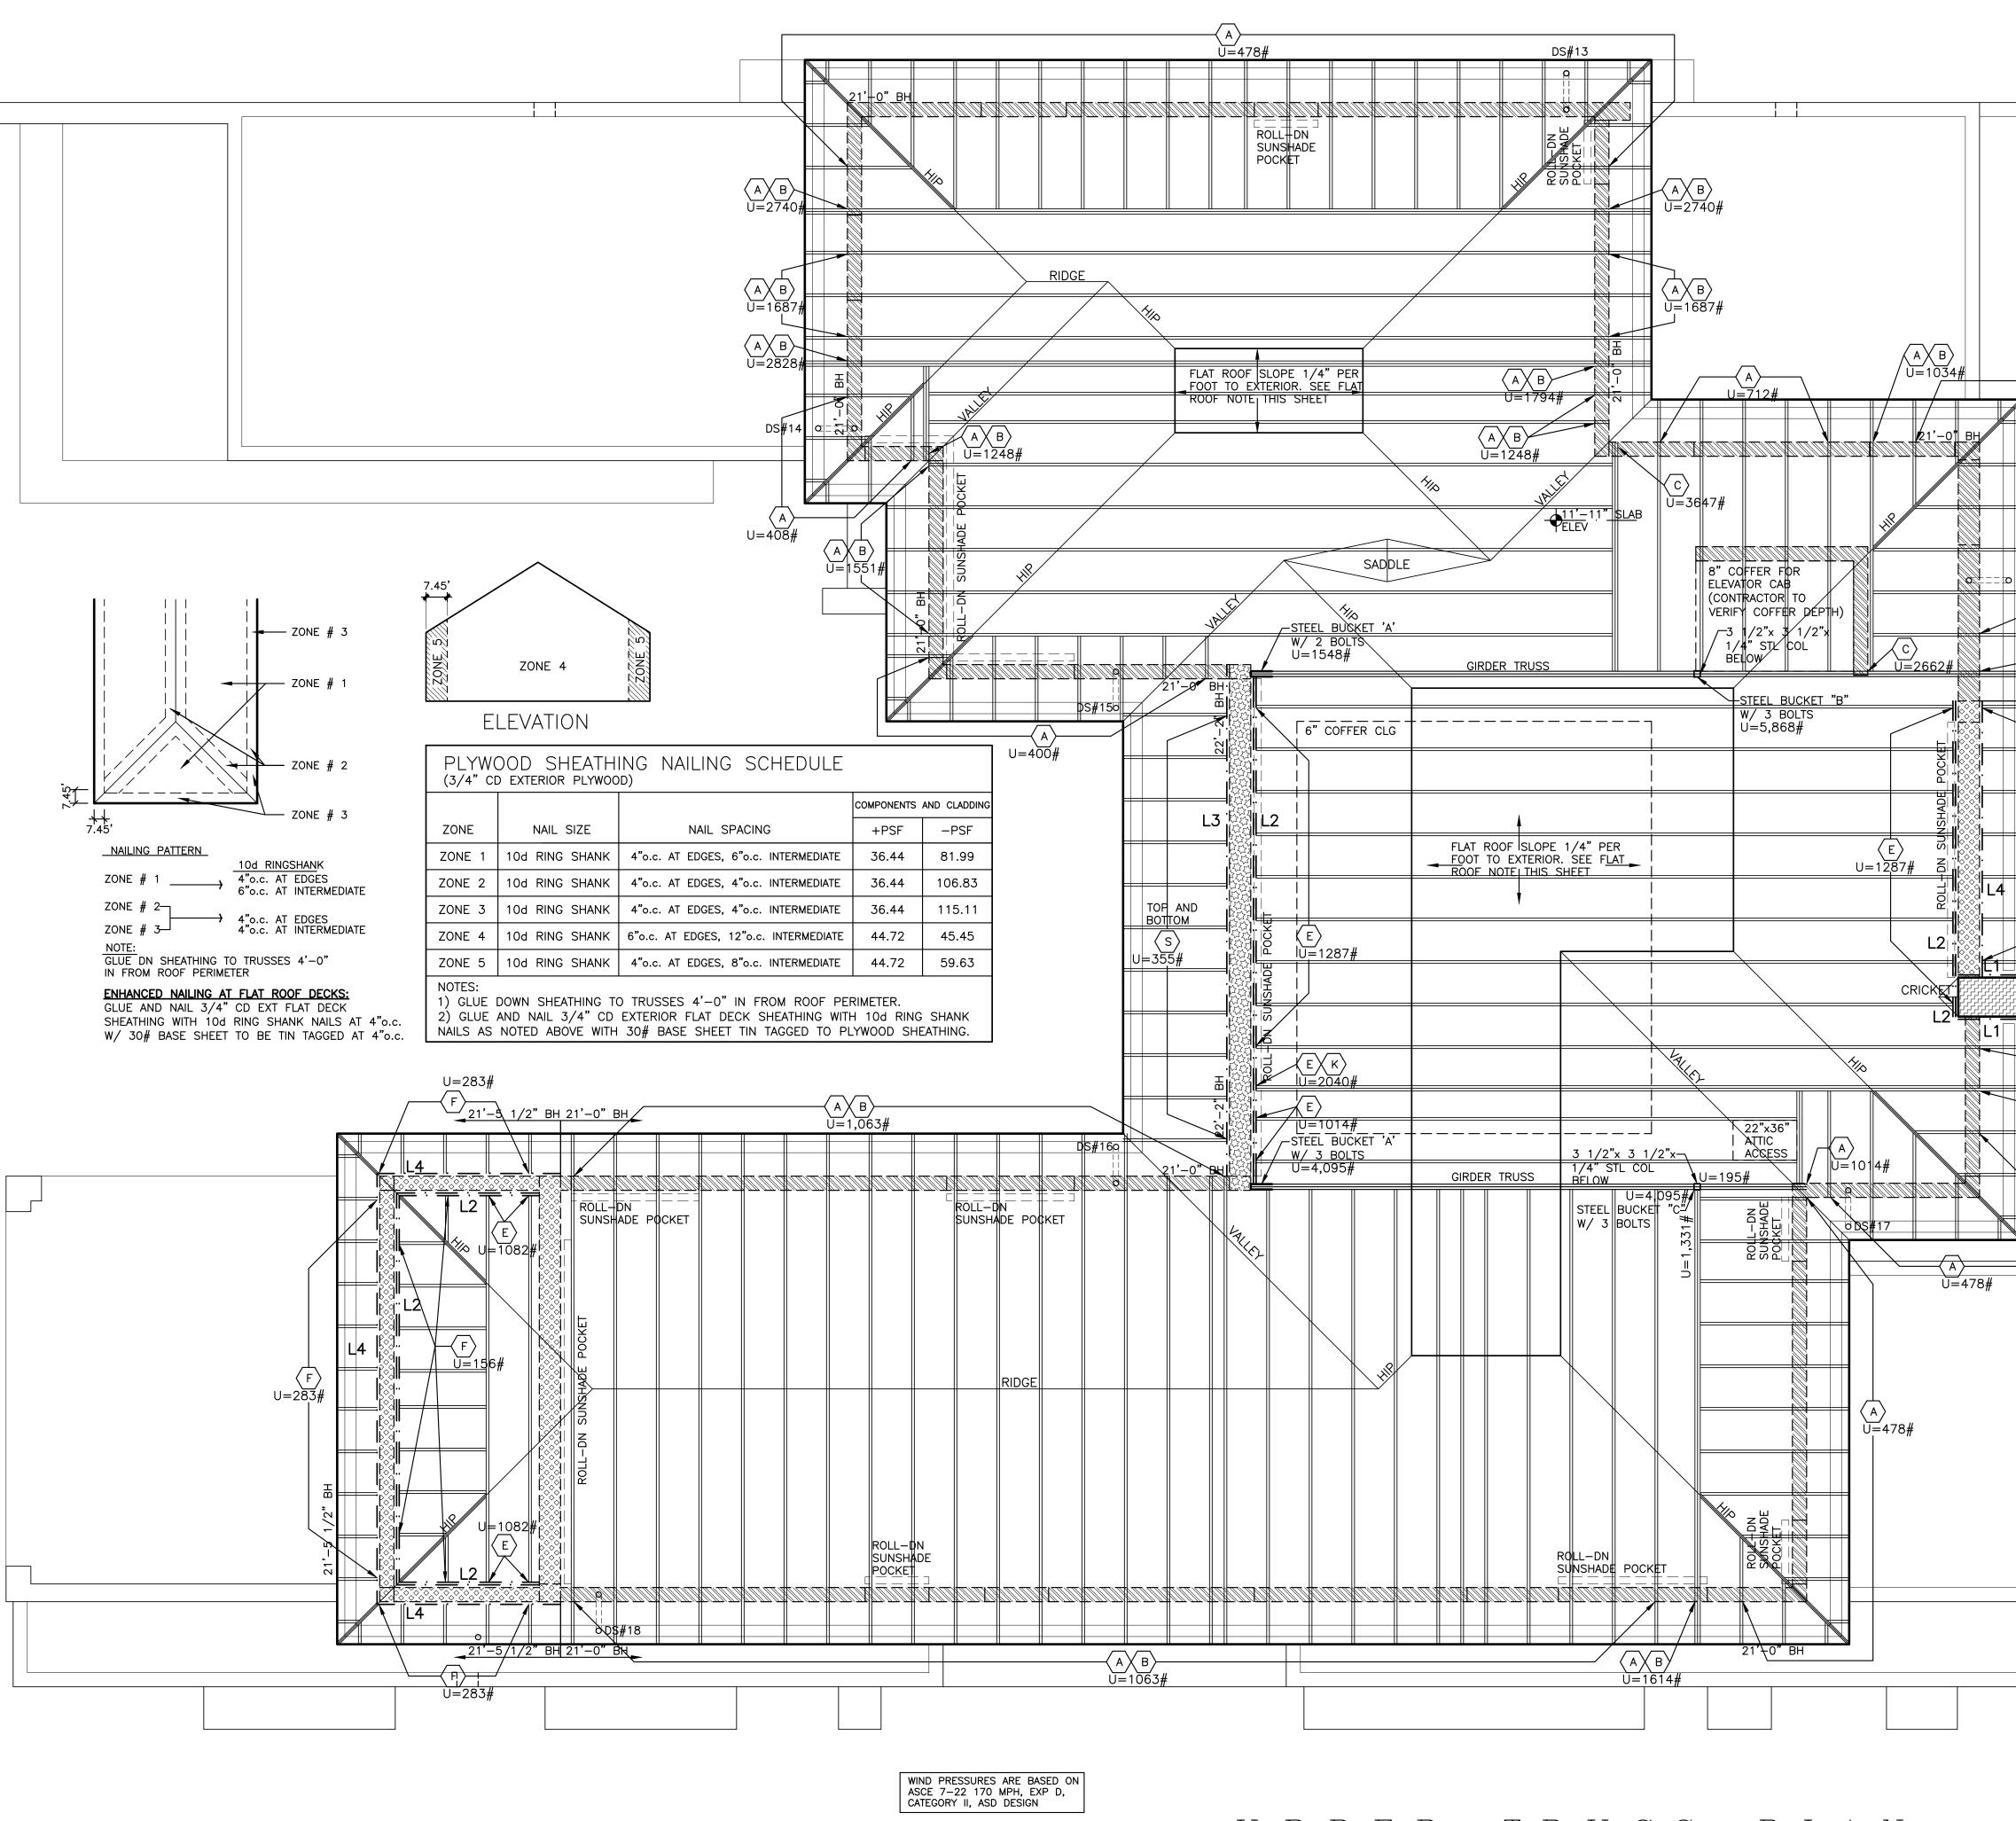


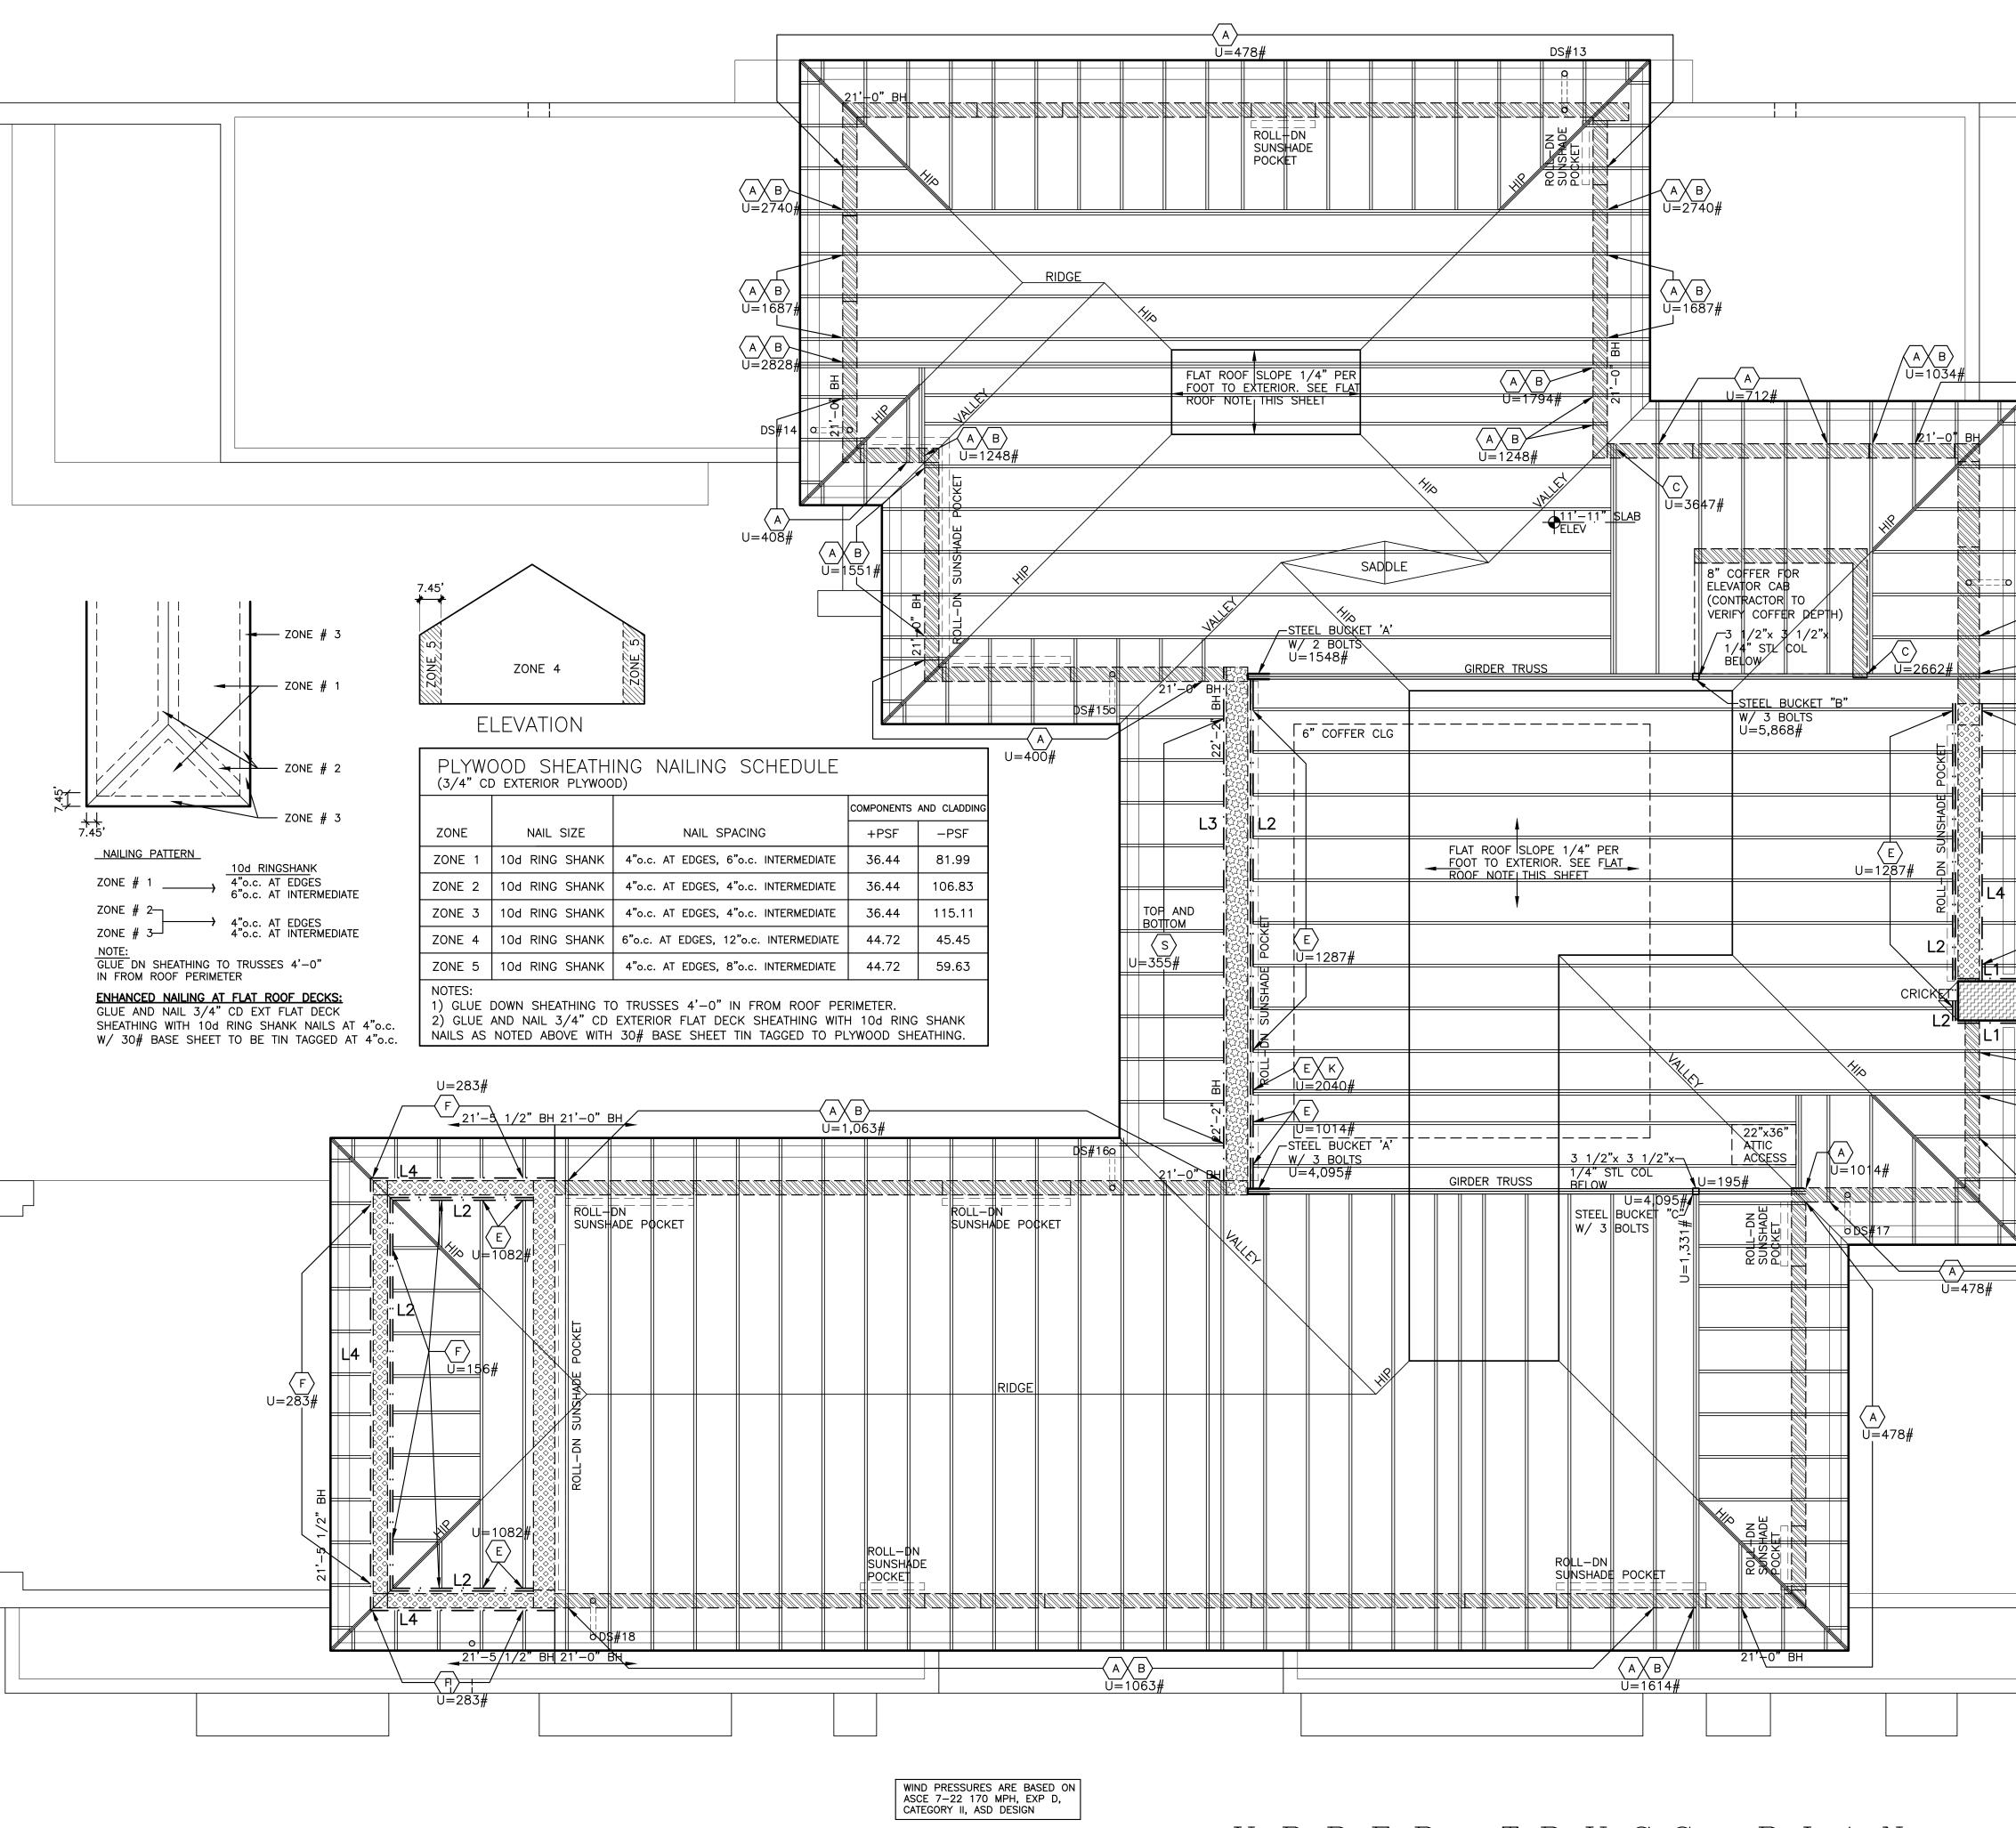

ALL TRUSS CONNECTORS SPECIFIED BASED ON A F2 FORCE OF 394# ON EACH TRUSS


 $U P P E R T R U S S P_{\text{scale: 1/4"} = 1'-0"}$ 

		LEDGER SCHEDULE: L1 – 2x6 P.T. WOOD LEDGER FOLLOWING ROOF SLOPE. FASTEN W/ 3/16" DIAMETER TAPCON ANCHORS (x1 1/4" MIN. EMBED) AT 16"o.c. STAGGERED L2 – (2)2x8 P.T. WOOD LEDGER W/ 5/8" DIA. TITEN HD (x 6" MIN. EMBED SPACED AT 24"o.c. STAGGERED L3 – 2x6 P.T. TOP BOTTOM LEDGER W/ 3" TAPCONS AT 12"o.c. W/ SIMPSON DTT1Z HURRICANE TIE AT EACH SIDE OF EACH "EYEBROW" TRUSS TOP AND BOTTOM LEDGER W/ 3" TAPCONS AT 12"o.c. W/ SIMPSON H3 HURRICANE TIE AT EACH SIDE OF EACH "EYEBROW" TRUSS TOP AND BOTTOM LEDGER W/ 3" TAPCONS AT 12"o.c. W/ SIMPSON H3 HURRICANE TIE AT EACH SIDE OF EACH "EYEBROW" TRUSS TOP AND BOTTOM BEAM HEIGHT LEGEND	) VILLAGE ARCHITECTS AIA 400 N CYPRESS DRIVE, SUITE 21 Tequesta, FL 33469 Phone: 561-743-4959 Eav: 561-743-4959
A = 478 # $DS # 18$ $H = 478 #$ $H = 478 #$ $H = 478 #$	LIVE LOAD = 30 psf LIVE LOAD = TOTAL = 55 psf TOTAL = 1 <b>ROOF W/ MECH</b> DEAD LOAD = 25 psf DEAD LOAD =125 LIVE LOAD = 30 psf LIVE LOAD = 40 MECHANICAL = 5 psf TOTAL =165 TOTAL = 60 psf WIND: WIND SPEED = 170 mph EXPOSURE "D" RISK CATEGORY II INTERNAL PRESSURE COEFFICIENT = 0.18 WIND IMPORTANCE FACTOR = 1.0 MEAN ROOF HEIGHT = $23'-4$ "	15'-2" BH 21'-0" BH 25 psf 40 psf 65 psf 伊子子子子子 22'-0" BH AB psf psf psf	AIELLO RESIDENCE 20 Ocean DRIVE JUPITER INLET COLONY, FLORIDA
$F = \frac{F}{U=283\#}$	<ul> <li>FOUNDATIONS: FOUNDATIONS DESIGNED FOR AN ALLO 2,500 psf.</li> <li>CONCRETE: 5,000 psi WITH WATER/CEMENT RATIO=.0 GRADE.</li> <li>5,000 psi FOR ALL STRUCTURAL CONCRETE (U.N.O.) (BROOM FINISH AT ALL CONCRETE BALCONIES)</li> <li>NO WATER TO BE ADDED ON SITE.</li> <li>WATER REDUCERS MAY BE USED IN MIX DESIGN SUBMIT CONCRETE MIX DESIGNS TO ARCHITECT/ ENGREINFORCING STEEL: CONFORMS TO ASTM A615, GRAWELDED WIRE MESH: CONFORMS TO ASTM A-185.</li> <li>MASONRY WALLS: MASONRY UNITS: ASTM C-90 (f'mettype "M" OR "S" GROUT: ASTM C-476 (PEA GRAVEL</li> </ul>	040 FOR FOOTINGS AND SLABS ON WITH WATER /CEMENT RATIO = 0.4 GINEER FOR APPROVAL ADE 60 DEFORMED BARS. = 1,500 psi) MORTAR: ASTM C-270,	Seal : Mitchell E. Miller Florida License No. AR91772 As Principal of Village Architects AIA, Inc.
22'-0" BH 22'-0" BH	STRUCTURAL STEEL: STRUCTURAL STEEL PLATES SHALL CONFORM CONNECTIONS SHALL BE WELDED UTILIZING E70XX EWOOD: FIBER STRUCTURAL WOOD COMPONENTS SHALL HAVE FIBER STRESSES:BENDING: NOOD IN CONTACT WITH MASONRY OR CONCRETE SH TREATED IN ACCORDANCE WITH AITC-109.MANUFACTURED WOOD: MANUFACTURED BY TRUSSJOIST MacMILLAN (MICROLL SUBSTITUTION. Fb= 3100 psi, E= 2,000,000 psi, Fv= 285 psi.	TO ASTM A-36. ALL SHOP LECTRODES. THE FOLLOWING MINIMUM ALLOWABLE HALL BE PROTECTED OR PRESSURE ED VENEER LUMBER AS	Village Architects AIA All rights reserved. These drawings are the Property of the architect and are not to be used for any other projects except by agreement with The architect in writing. <b>Consultant:</b> <b>MCR PROFESSIONAL</b> <b>ENGINEERING, INC.</b> CERTIFICATE OF AUTHORIZATION # 26967 3733 Atlantic Road Palm Beach Gardens, FL 33410 PH: (561) 863-3393
			MICHAEL BABER FLORIDA PROFESSIONAL ENGINEER, 52575 Revisions : 2-5-24 ARB REVIEW 2-27-24 Owner Changes
			Sheet Title: UPPER TRUSS PLAN Scale: 1/4"=1'-0"
			Comm. :Date :23-0349-18-23Drawn :Checked :CRAMEM
W/ 1/4" ASPHALT BLEED LAYER OF SMOOTH SURF MEMBRANE SET WITH HO LAYER GAF #75 BASE SH CD EXTERIOR PLYWOOD S COMPANY TO PITCH TOP	ED CAP SHEET INSTALLED DS AT LAP OVER ONE ACE MODIFIED BITUMEN T ASPHALT OVER ONE HEET TIN TAGGED TO 3/4" SHEATHING. TRUSS CHORD OF TRUSSES 1/4" D ROOF EDGE OR DRAIN. HORD OF EDGE OR DRAIN. HORD OF WITHO	TIONS OR NOTCHES SHALL ANY STRUCTURAL MEMBER DNCRETE BEAMS AND ASONRY BLOCK AND STEEL UT WRITTEN APPROVAL BY R OF RECORD. FOR CONSTRUCTION	J PRINT DATE: 2-27-24

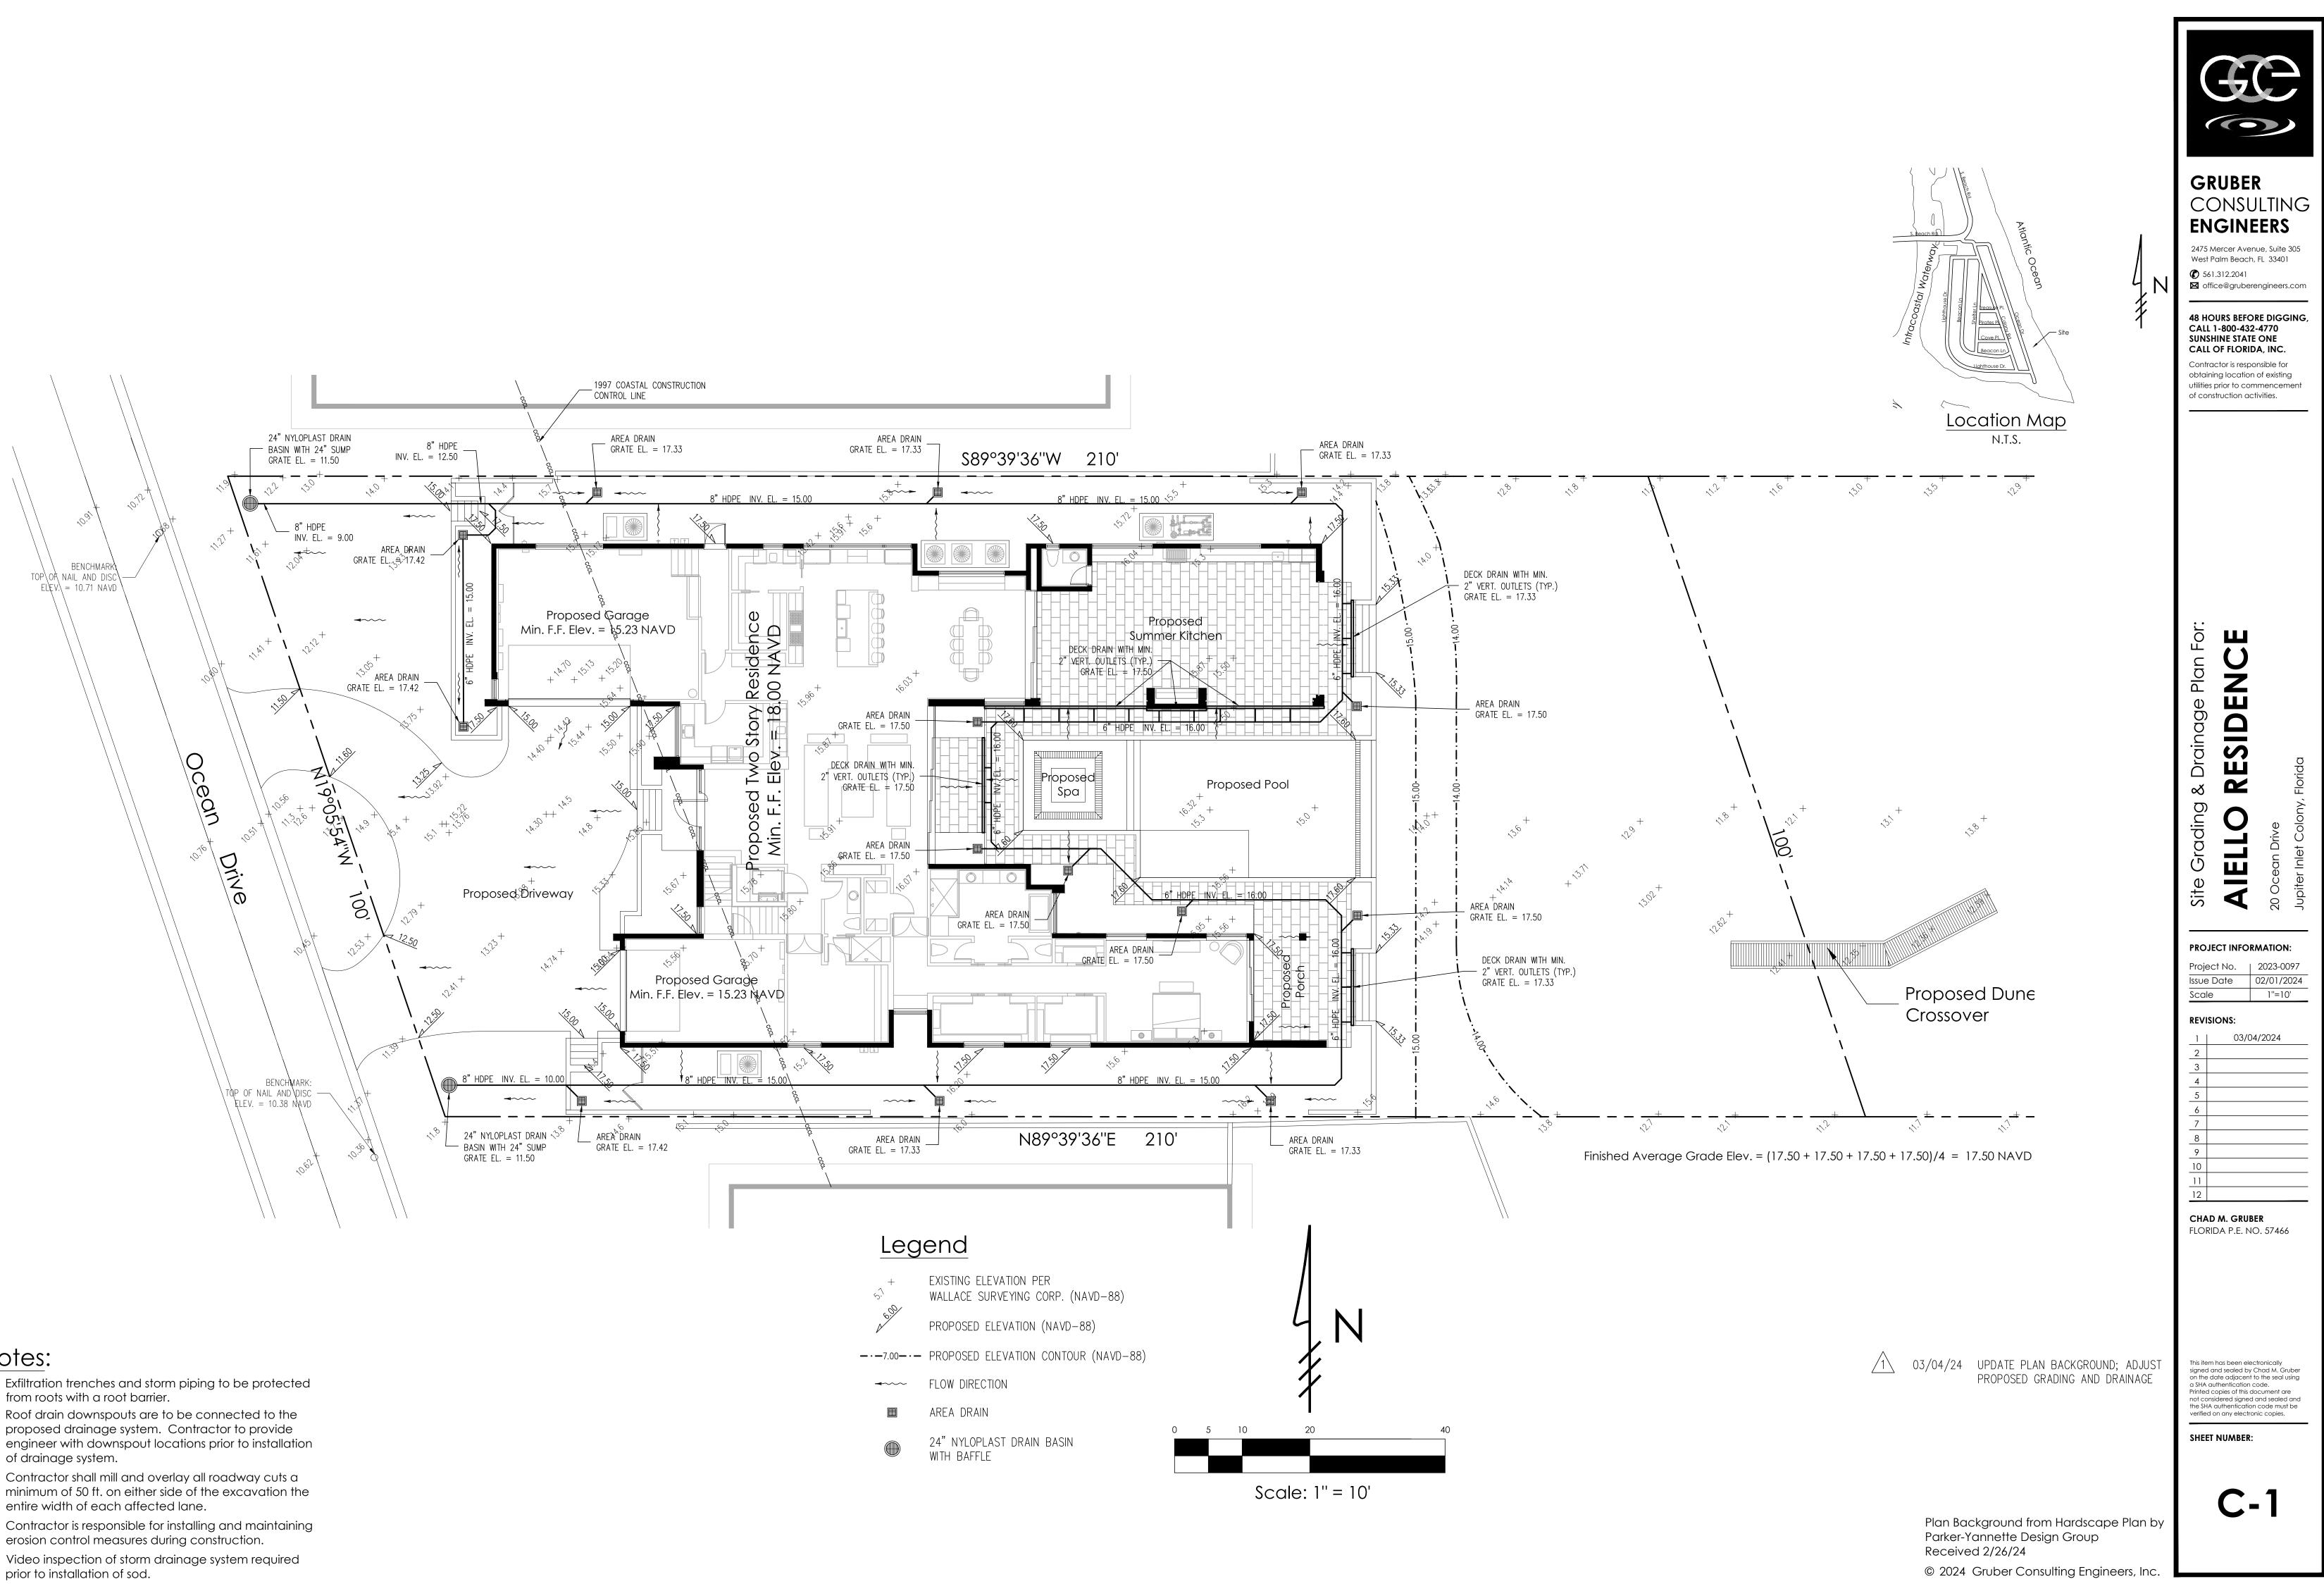

## Notes:

- 1) Exfiltration trenches and storm piping to be protected
- 2) Roof drain downspouts are to be connected to the proposed drainage system. Contractor to provide engineer with downspout locations prior to installation of drainage system.
- 3) Contractor shall mill and overlay all roadway cuts a
- 4) Contractor is responsible for installing and maintaining erosion control measures during construction.
- 5) Video inspection of storm drainage system required prior to installation of sod.

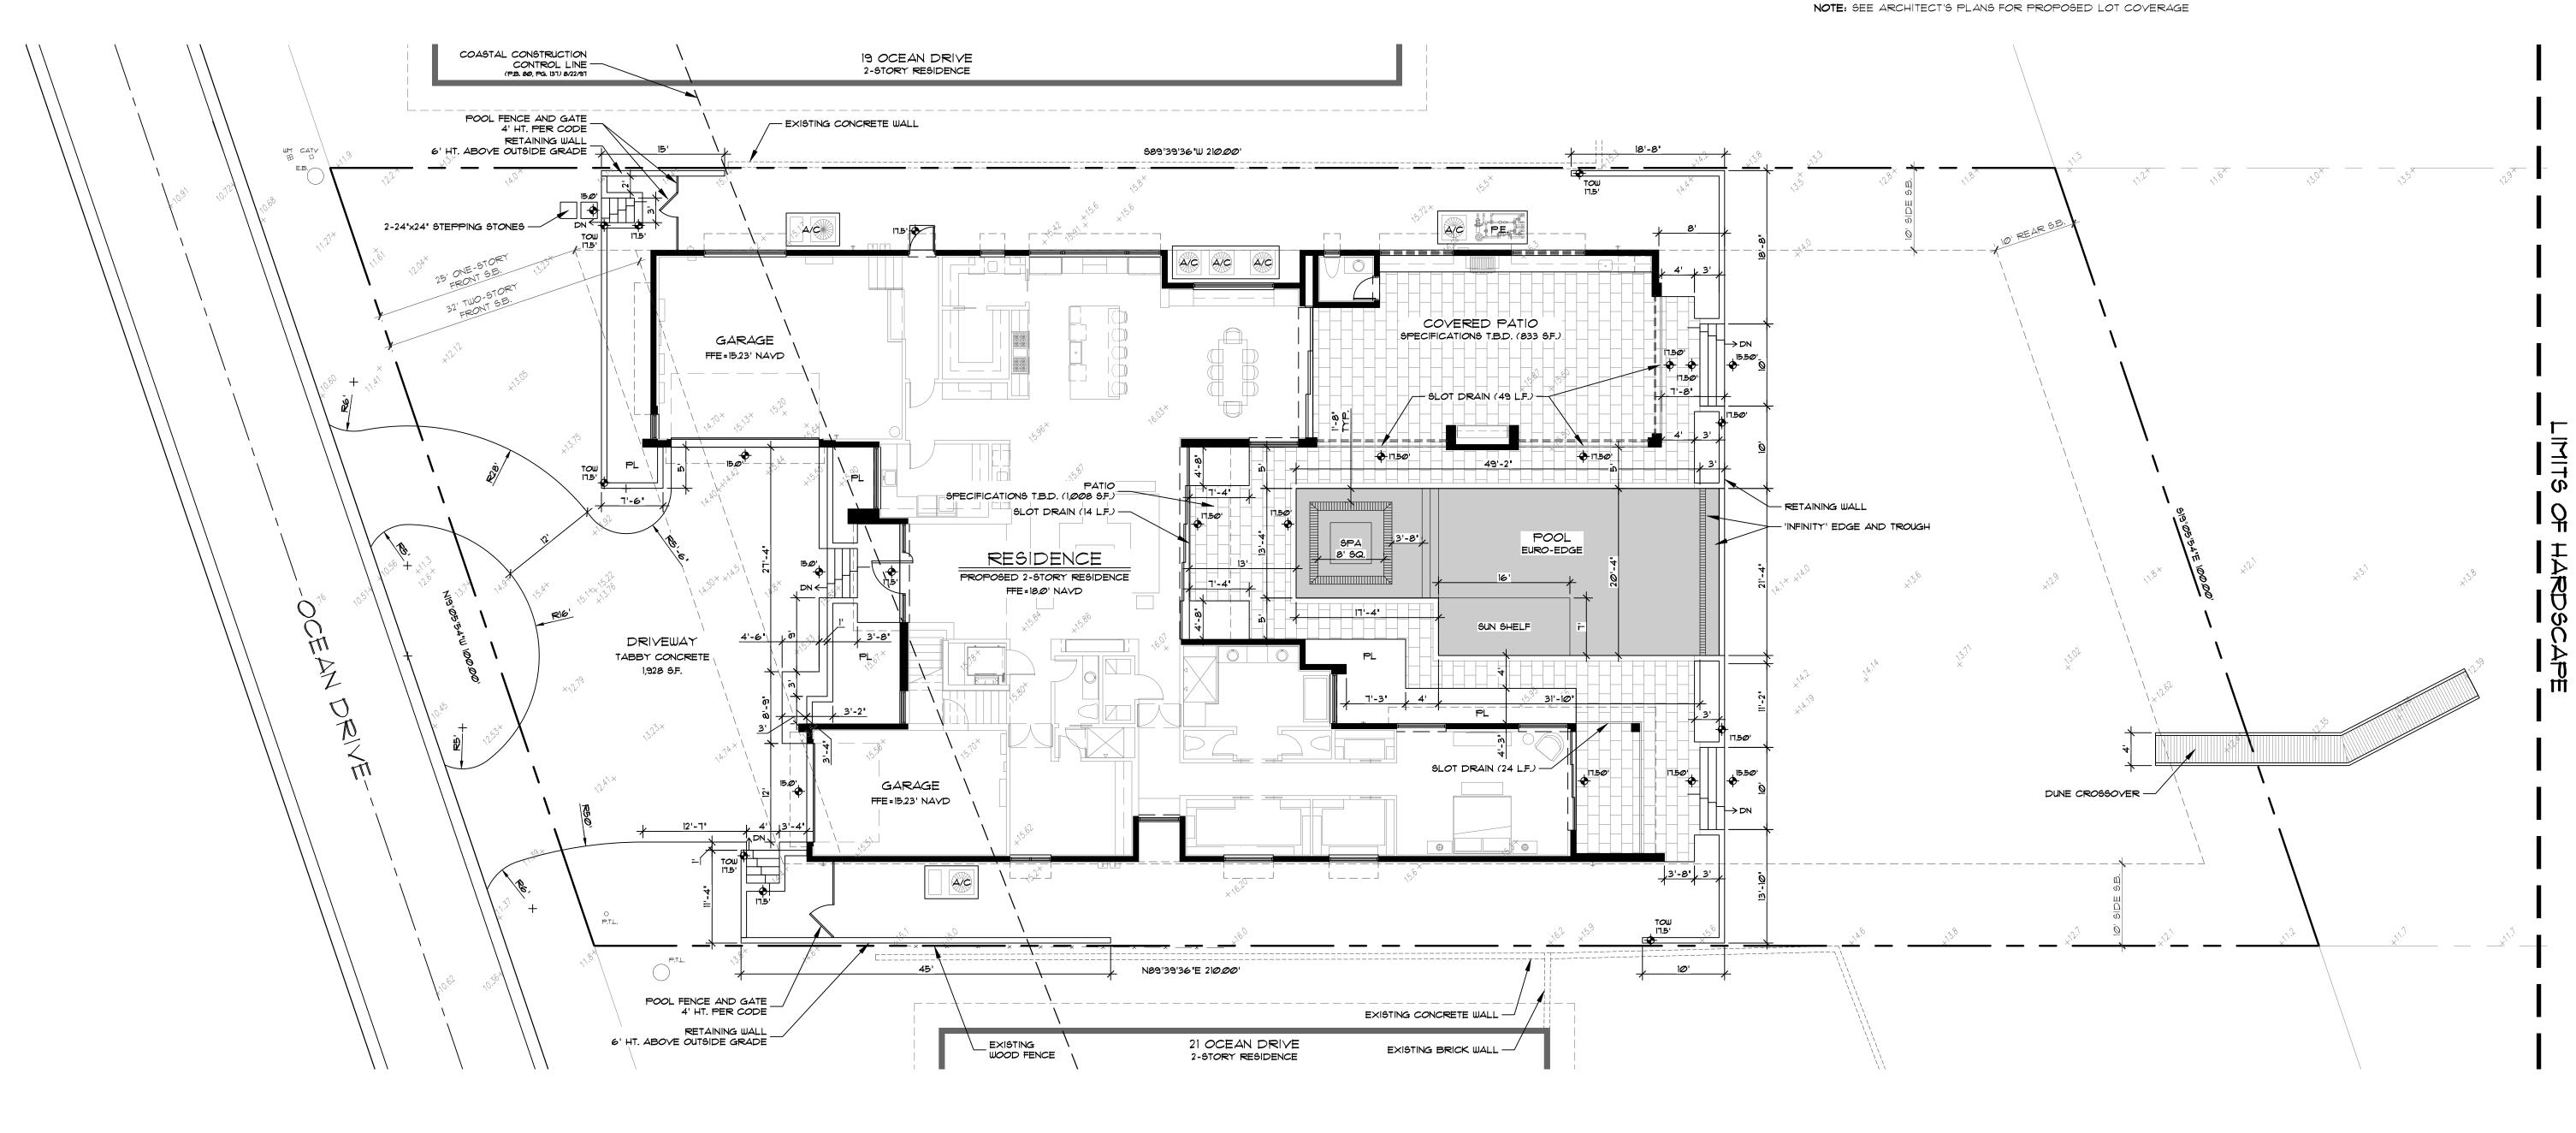

# Layout Notes

1. CONTRACTOR SHALL VERIFY ALL EXISTING CONDITIONS AND LAYOUT DIMENSIONS IN THE FIELD. REPORT ALL DISCREPANCIES IMMEDIATELY TO THE LANDSCAPE ARCHITECT FOR DECISION BEFORE CONSTRUCTION.

2. REFER TO THE ARCHITECTURAL DRAWINGS FOR ALL BUILDING DIMENSIONS.

3. CONTRACTOR SHALL VERIFY ALL EXISTING GRADES IN THE FIELD AND REPORT ANY DISCREPANCIES IMMEDIATELY TO THE LANDSCAPE ARCHITECT FOR DECISION.

4. ALL FILL FOR BERMING AND PLANTING BROUGHT TO THE SITE SHALL BE CLEAN, FRIABLE SANDY LOAM OF SLIGHTLY ACID TO NEUTRAL PH. ALL FILL SHALL BE FREE FROM STICKS, ROCKS MARL, SOD AND OTHER DEBRIS.

5. REMOVE ALL ROAD BASE, SHELLROCK, MARL, CORAL ROCK, AND RUBBLE 30" MIN. BELOW FINISH GRADE FROM ALL NEW PLANTING AREAS AND TREE PITS. BACKFILL WITH SUITABLE SOIL AS APPROVED BY LANDSCAPE ARCHITECT. MAINTAIN EXISTING GRADE AT EXISTING TREES. 6. NEW EARTHWORK SHALL BLEND SMOOTHLY INTO EXISTING GRADE.

7. PITCH EVENLY BETWEEN SPOT GRADES. ALL PAVED AREAS MUST PITCH TO DRAIN AT MIN. OF 1/8" PER FOOT. ANY DISCREPANCIES NOT ALLOWING THIS TO OCCUR SHALL BE REPORTED TO THE LANDSCAPE ARCHITECT PRIOR TO CONTINUING WORK.

8. CONTRACTOR SHALL PROVIDE IRRIGATION AND ELECTRIC SLEEVES TO ALL PLANTERS.

# Drainage Notes

1. MATCH ALL EXISTING GRADES ALONG SIDE PROPERTY LINES. 2. PROVIDE SWALES ON BOTH SIDE PROPERTY LINES. NO WATER SHALL DRAIN ONTO NEIGHBORS PROPERTY. 3. CONTRACTOR SHALL BE RESPONSIBLE FOR PROVIDING POSITIVE SITE DRAINAGE AWAY FROM ALL STRUCTURES INCLUDING BUT NOT LIMITED TO PLANTERS, COURTYARD PLANTING AREAS, HARDSCAPE SURFACES AND ARCHITECTURAL ELEMENTS. 4. CONTRACTOR SHALL PROVIDE DRAINAGE FROM ALL PLANTERS.

# Site Data


LOT SIZE: 19,884 S.F.

IMPERVIOUS AREA: 9,906 S.F. IMPERVIOUS COVERAGE: 49.8% (50.0% MAX.)

FRONT YARD AREA: 2,500 S.F.

- TOTAL LANDSCAPE AREA: 9,978 S.F. LANDSCAPE COVERAGE: 50.2% (50.0% MIN.)


- FRONT YARD LANDSCAPE AREA: 1,376 S.F. FRONT YARD LANDSCAPE COVERAGE: 55,0% (50,0% MIN.)

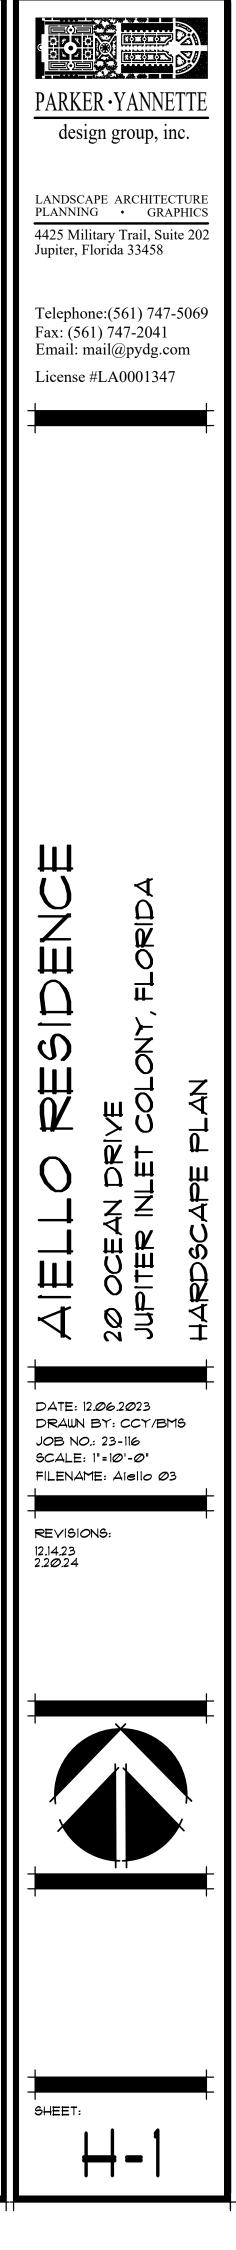

# Landscape Lighting Table

<u>SYM.</u>	<u>QTY.</u>	MOUNT TYPE	<u>MOUNT HT.</u>	MANUFACTURER/CATALOG NO.
📥 A	г	Accent Light	18"	Aurora HSL2Ø-LM-5Ø-12-W-27-FR-18-AGS-NAT
📥 в	4	Accent Light	Ground	Aurora HSL2Ø-LM-6Ø-8-W-27-AGS-NAT
<del>ф</del> с	4	Path Light	19"	Aurora LPL7-27-FR-C-2G6-NAT
фса	2	Path Light	19"	Aurora LPL7-AMB-FR-C-2GS-NAT
D	5	Pool/Spa Light	N/A	Pentair 602152 Intellibrite Architectural Series Pool Light
NOTES	3:			

NOTES: - INSTALL ALL WIRING IN CONDUIT MINIMUM 12" BELOW GRADE.

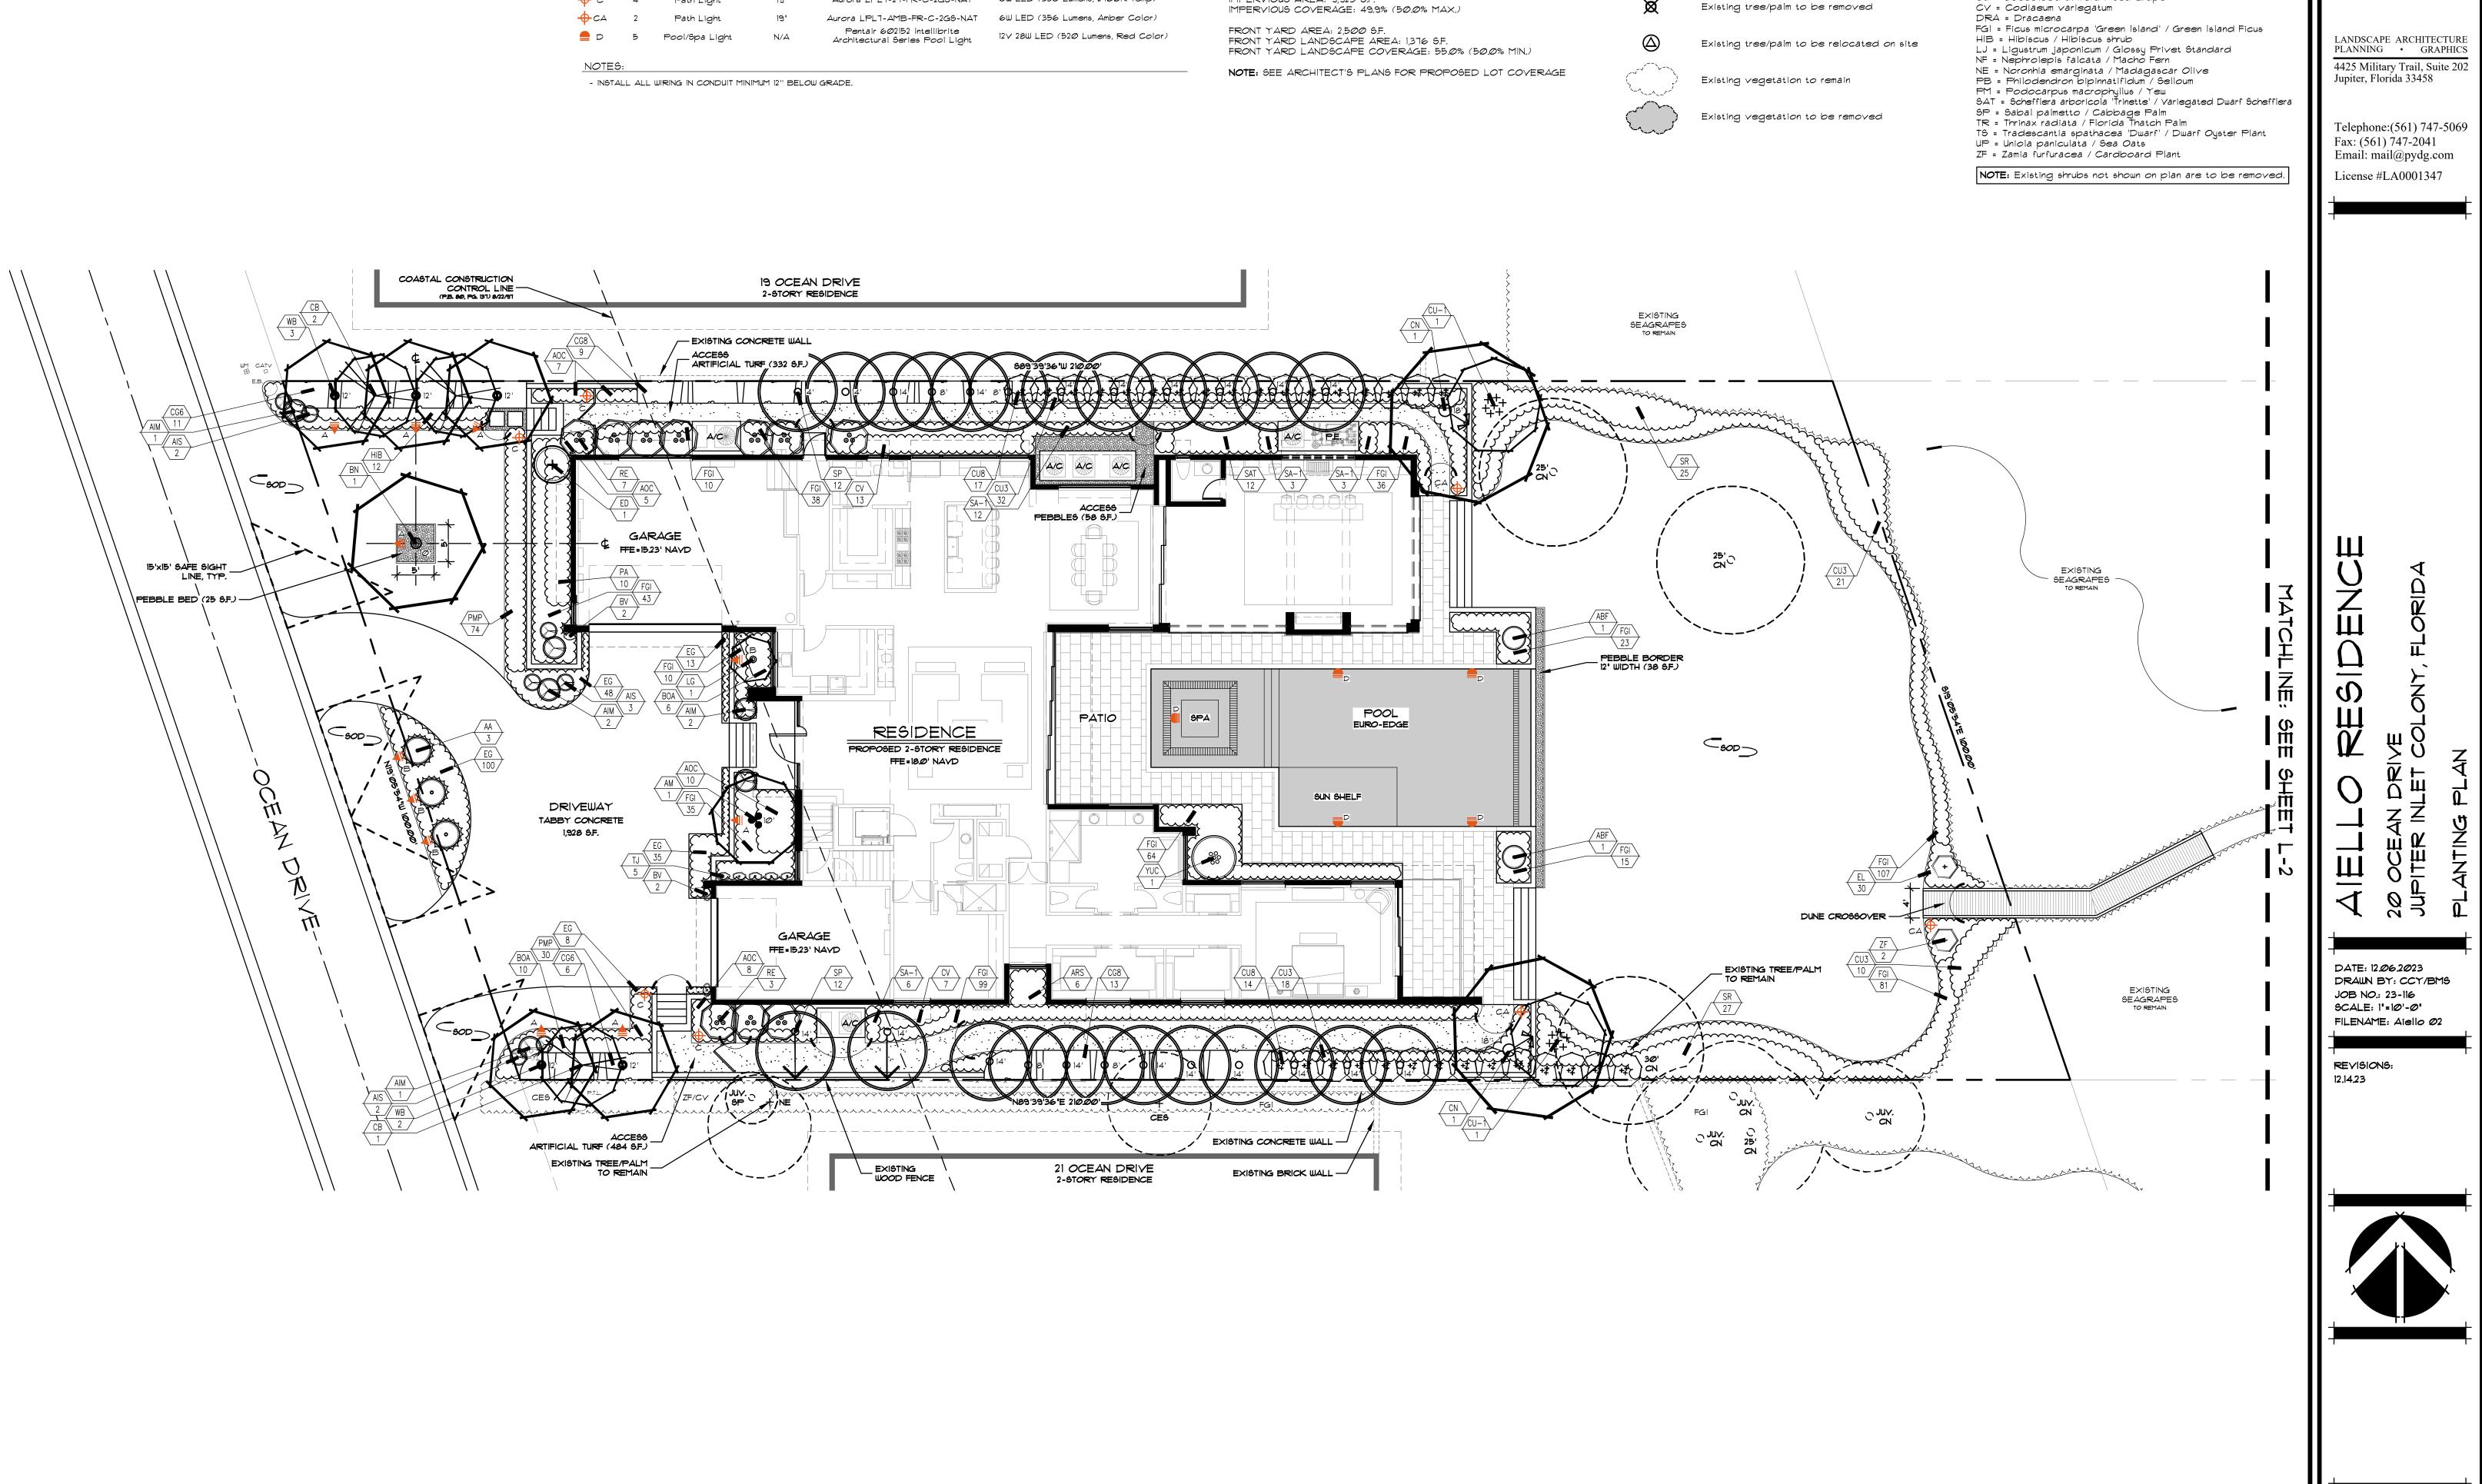

LAMP TYPE, COLOR, AND WATTS 12∨ 12W LED (550 Lumens, 2700K Temp) 47 12∨ 8W LED (550 Lumens, 2700K Temp) 6W LED (356 Lumens, 2700K Temp) 6W LED (356 Lumens, Amber Color) 12∨ 28W LED (52Ø Lumens, Red Color)

# Site Data

LOT SIZE: 19,884 S.F.

TOTAL LANDSCAPE AREA: 9,959 S.F. LANDSCAPE COVERAGE: 50.1% (50,0% MIN.)

IMPERVIOUS AREA: 9,925 S.F. IMPERVIOUS COVERAGE: 49,9% (50.0% MAX.)

FRONT YARD AREA: 2,500 S.F. FRONT YARD LANDSCAPE AREA: 1,316 S.F. FRONT YARD LANDSCAPE COVERAGE: 55.0% (50.0% MIN.)



NOTE: SEE ARCHITECT'S PLANS FOR PROPOSED LOT COVERAGE

Symbol Key

Existing tree/palm to remain

Existing tree/palm to be removed

Existing tree/palm to be relocated on site

Existing vegetation to remain

Existing vegetation to be removed

# Existing Plant Key

CA = Crinum asiaticum / Crinum Lily CE = Chamaedorea erumpens / Bamboo Palm CES = Conocarpus erectus sericeus / Silver Buttonwood CG = Clusia guttifera / Small Leaf Clusia CN = Coccos nucifera / Coconut Palm CU = Coccoloba uvifera / Sea Grape CV = Codiaeum variegatum DRA = Dracaena

**PARKER** · YANNETTE


design group, inc.

LANDSCAPE ARCHITECTURE PLANNING • GRAPHICS


4425 Military Trail, Suite 202

Jupiter, Florida 33458

SHEET:

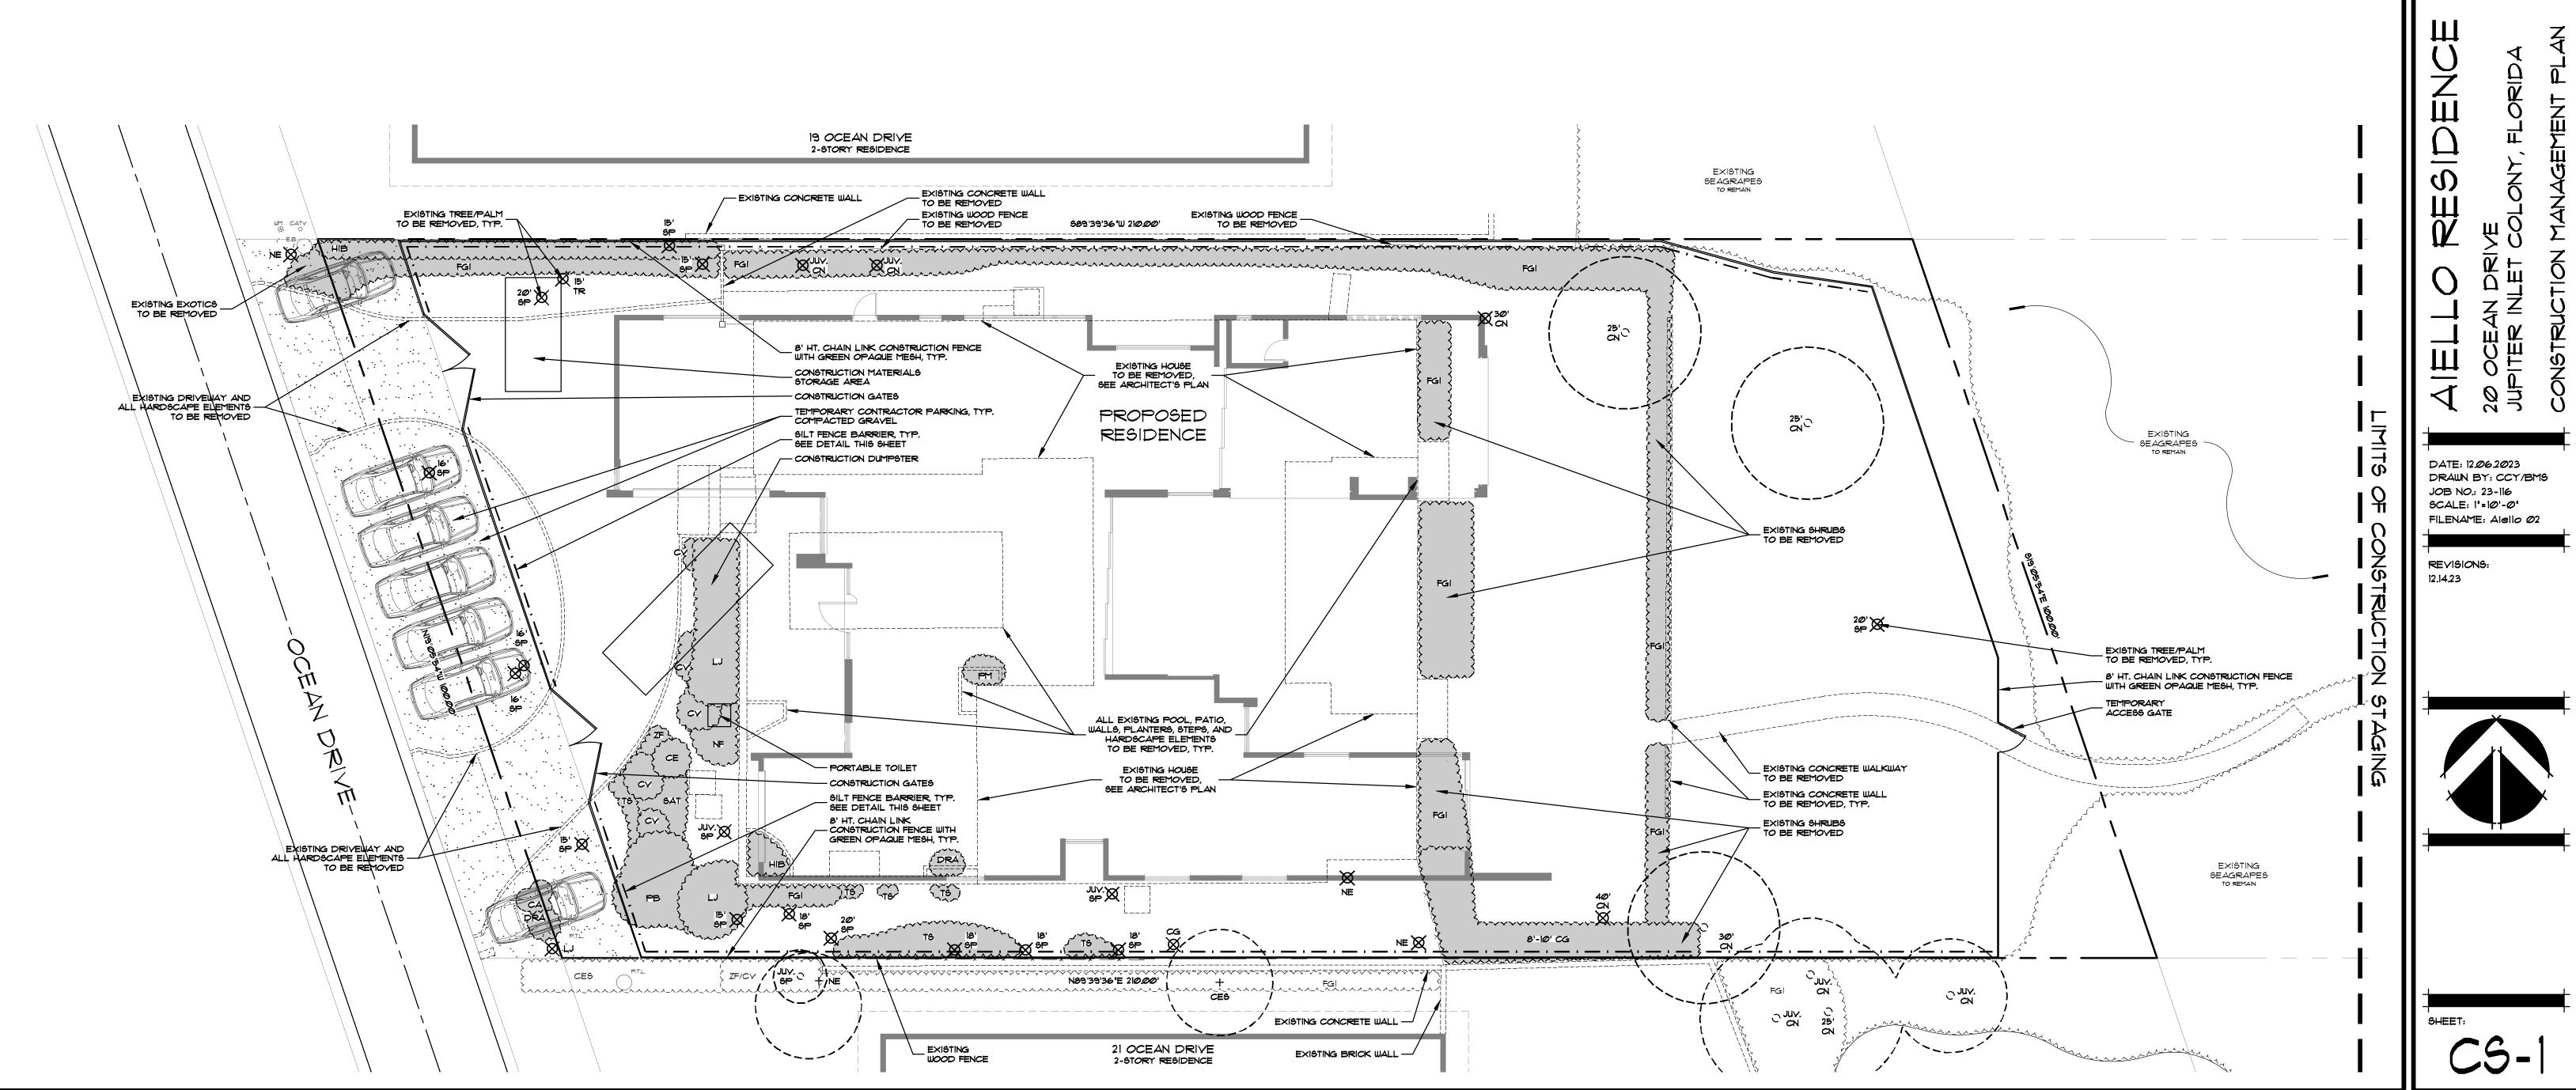


# Symbol Key

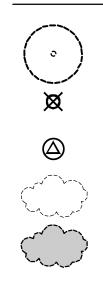

damage to the gutter.

to the extent possible.

SCALE: N.T.S.

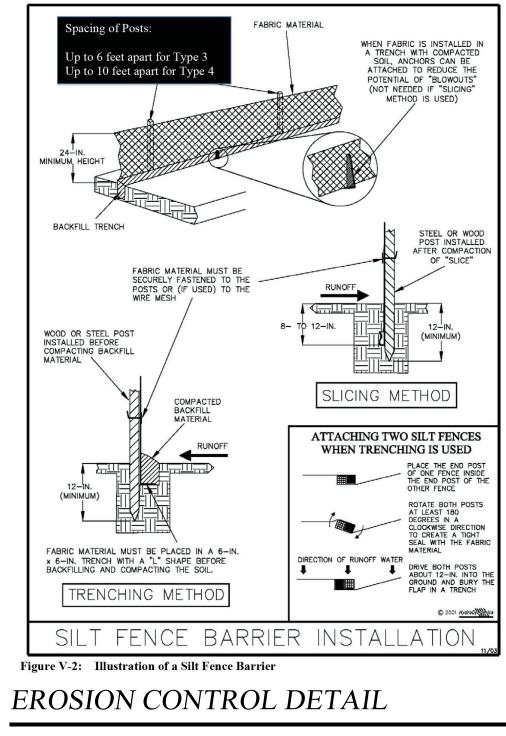

STATE OF FLORIDA E&SC DESIGNER & REVIEWER MANUAL; LATEST EDITION: JULY 2013

- Existing tree/palm to remain
- Existing tree/palm to be removed
- Existing tree/palm to be relocated on site
- Existing vegetation to remain
- Existing vegetation to be removed

# Existing Plant Key

CA = Crinum asiaticum / Crinum Lily CE = Chamaedorea erumpens / Bamboo Palm CES = Conocarpus erectus sericeus / Silver Buttonwood CG = Clusia guttifera / Small Leaf Clusia CN = Cocos nucífera / Coconut Palm CU = Coccoloba uvifera / Sea Grape CV = Codiaeum variegatum DRA = Dracaena FGI = Ficus microcarpa 'Green Island' / Green Island Ficus HIB = Hibiscus / Hibiscus shrub

CCCS

PARKER · YANNETTE

LANDSCAPE ARCHITECTURE PLANNING • GRAPHICS

4425 Military Trail, Suite 202

Telephone:(561) 747-5069

Jupiter, Florida 33458

Fax: (561) 747-2041

Email: mail@pydg.com

License #LA0001347

design group, inc.

- LJ = Ligustrum japonicum / Glossy Privet Standard
- NF = Nephrolepis falcata / Macho Fern NE = Noronhia emarginata / Madagascar Olive
- PB = Philodendron bipinnatifidum / Selloum
- PM = Podocarpus macrophyllus / Yew SAT = Schefflera arboricola 'Trinette' / Variegated Dwarf Schefflera
- SP = Sabal palmetto / Cabbage Palm TR = Thrinax radiata / Florida Thatch Palm
- TS = Tradescantía spathacea 'Dwarf' / Dwarf Oyster Plant UP = Uniola paniculata / Sea Oats ZF = Zamía furfuracea / Cardboard Plant

NOTE: Existing shrubs not shown on plan are to be removed.

## Construction Notes

-Construction hours: Monday through Friday, 8 AM to 5 PM, and Saturday 9 AM to 5 PM.

-A temporary area consisting of compacted gravel shall be installed on the lot for contractor parking.

-Vehicles shall park in a line perpendicular to road and house. Overflow vehicles shall park on road in direction of traffic flow with care not to block mailboxes, fire hydrants or neighboring driveways.

-General contractor shall ensure protection of existing valley gutter, minimally with a plywood covering, and repair in the event of

-Temporary filters shall be installed in the road drains within close proximity of the site to prevent sand and silt from entering the town's drainage system. Filters shall be cleaned thoroughly weekly and after each storm event. Sand and silt in the filters shall be properly disposed and not emptied into the town's drainage system.

-A temporary screen shall be installed and maintained along the front of the property that shields construction activity from view

-The road in front of the lot shall be swept and cleaned nightly and kept clear of debris, runoff, sand, and vegetation at all times. -The contractor shall be responsible for the repair and maintenance of any damage in the town right-of-way and on private property as the result of construction activity.

#### JUPITER INLET COLONY BUILDING AND ZONING COMMITTEE REVIEW STANDARDS

#### MASS AND VOLUME

#### Zoning Code Section 10.1. - Development standards for single family residences.

**Mass and Volume Distribution.** Because lots within the town are limited in size, the massing and volume of any new residential building or addition *should be sensitive to the profiles of adjacent buildings and should locate second stories adequately to reduce the apparent overall scale of the building.* Second story windows, decks, terraces, and balconies for new construction *shall be designed and located to ensure privacy for adjacent properties* to the extent possible. (*emphasis added*)

#### IMPACT REVIEW STANDARDS AND DECISIONS Ordinance 02-2021

**Procedures: Standards for Review.** In performing its impact review analysis, the Building and Zoning Committee shall approve an application if the Applicant demonstrates that:


- a. The proposed development will not adversely affect the public interest; and
- b. The mass, scale and height of the proposed development is consistent with the surrounding properties and neighborhood character; and
- c. The proposed development will not adversely affect adjoining properties; and
- d. For development on waterfront properties, the proposed development is sensitive to and preserves views from adjoining properties as much as is practicable.

**Decisions: Appeals.** In performing its impact review analysis, the Building and Zoning Committee shall either approve, approve with conditions, or deny an application for development approval. In the event the Building and Zoning Committee finds that an application meets the requirements of this Section, then the application shall be approved. In the event the Building and Zoning Committee approves the application with conditions or denies the application, the Applicant may either amend its development application in compliance with the decision of the Building and Zoning Committee or may appeal the decision to the Town Commission. ...

#### JUPITER INLET COLONY BUILDING AND ZONING COMMITTEE MEETING 03-20-2024

#### Conditions of Approval: #20 Ocean Drive

- 1) A temporary area consisting of compacted gravel shall be installed on the lot for contractor parking.
- 2) Temporary filters shall be installed in the road drains within close proximity of the site to prevent sand and silt from entering the town's drainage system. Filters shall be cleaned thoroughly weekly and after each storm event. Sand and silt in the filters shall be properly disposed and not emptied into the town's drainage system.
- 3) A temporary screen shall be installed and maintained along the front of the property that shields construction activity from view to the extent possible.
- 4) The road in front of the lot shall be swept and cleaned nightly and kept clear of debris, runoff, sand, and vegetation at all times.
- 5) The contractor shall be responsible for the repair and maintenance of any damage in the town right-of-way and on private property as the result of construction activity.
- 6) During construction, the general contactor shall provide the Town quarterly updates regarding the construction schedule, major milestones, and timeline to complete the residence. Any significant deviation from the schedule shall require review and approval by the Building and Zoning Committee.

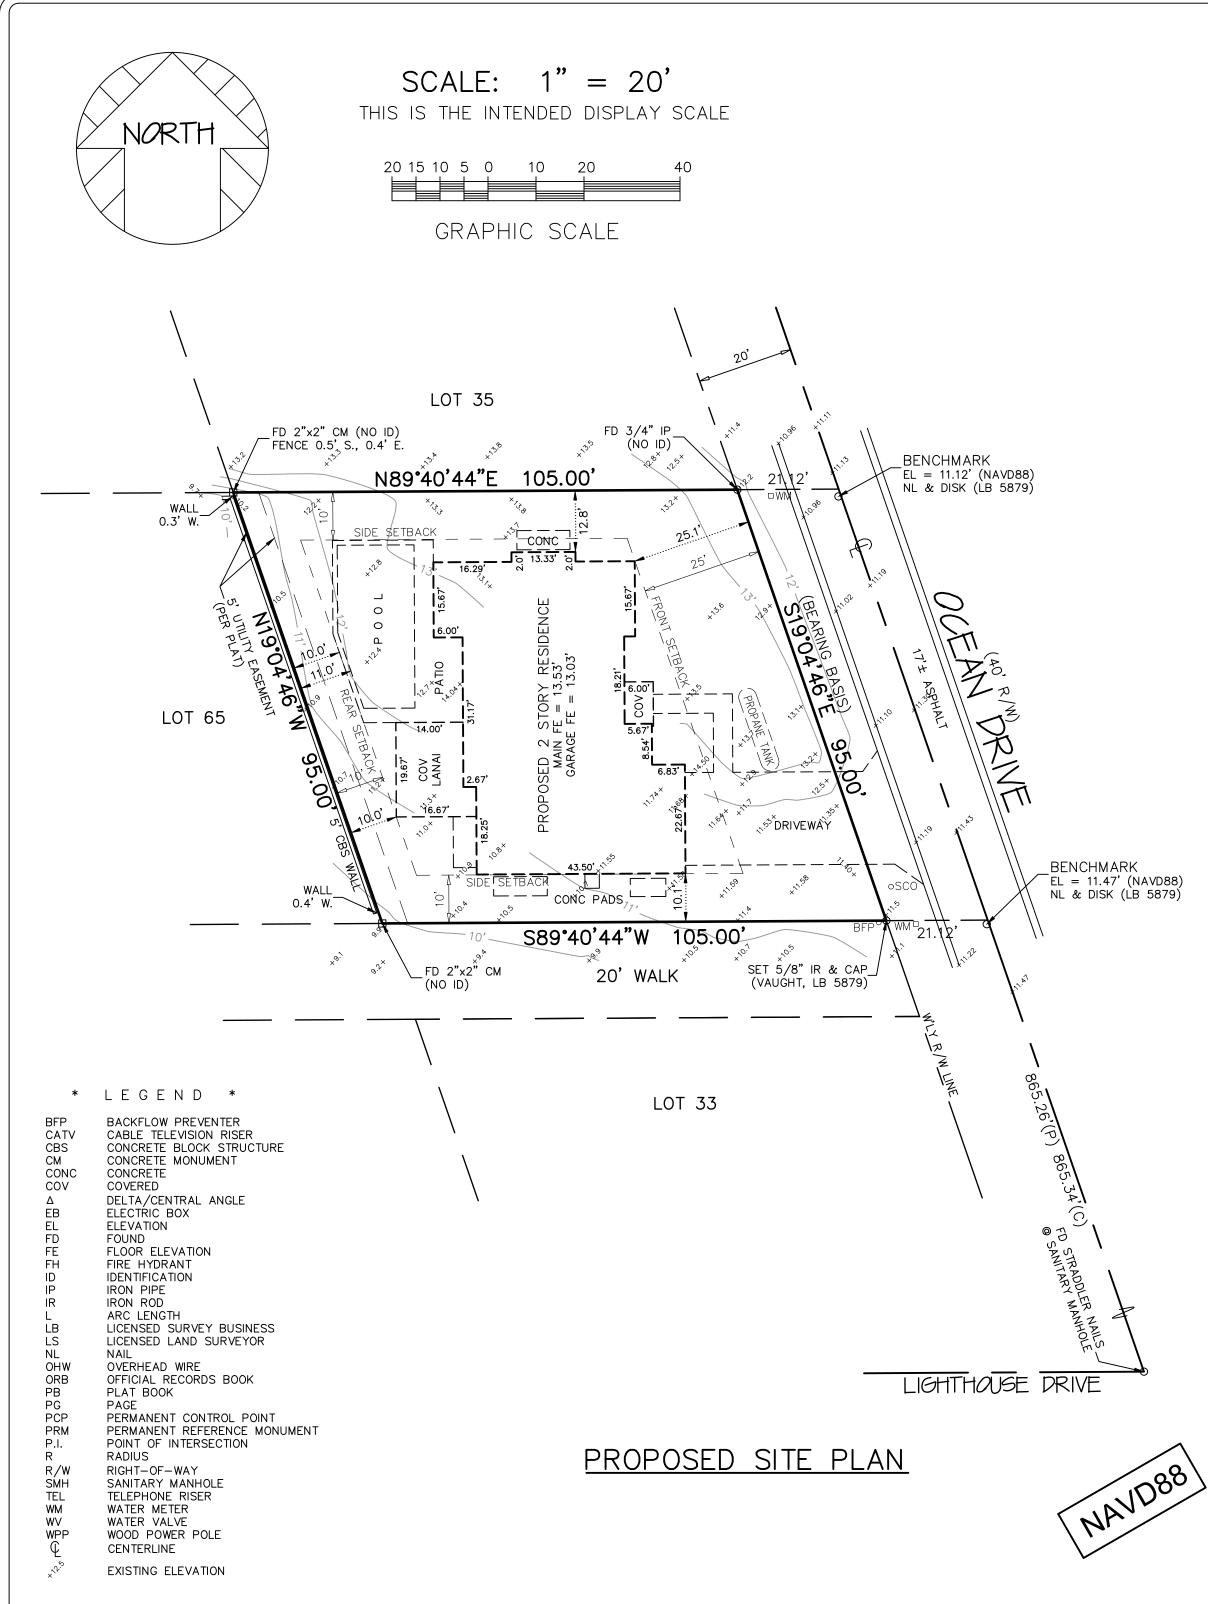

#### SURVEYOR'S NOTES:

- 1. NOT VALID WITHOUT ALL SHEETS AND THE ORIGINAL SIGNATURE AND SEAL OF A FLORIDA LICENSED SURVEYOR AND MAPPER.
- 2. BEARINGS SHOWN HEREON ARE BASED ON PLAT. BEARING BASE IS THE WESTERLY RIGHT-OF-WAY LINE OF OCEAN DRIVE.
- 3. THIS SURVEY IS BASED ON A CLOSED GEOMETRIC FIGURE EXCEEDING A HORIZONTAL CLOSURE OF 1:10000 U.S. SURVEY FEET. WELL-IDENTIFIED FEATURES SHOWN HEREON HAVE BEEN MEASURED TO AN ESTIMATED HORIZONTAL POSITIONAL ACCURACY OF 0.1 FEET.
- 4. ELEVATIONS SHOWN HEREON REFER TO NORTH AMERICAN VERTICAL DATUM 1988 (NAVD88) AND ARE EXPRESSED IN FEET AND DECIMAL PARTS THEREOF. BENCHMARK USED: 'T 305' (NGS), ELEVATION = 3.90' (NAVD88).
- 5. THE EXPECTED ACCURACY OF SPOT ELEVATIONS SHOWN HEREON IS 0.03 FEET FOR THE HARD SURFACE ELEVATIONS AND 0.1 FEET FOR NATURAL GRADE ELEVATIONS.
- 6. BEARINGS, ANGLES, AND DIMENSIONS SHOWN HEREON ARE FIELD MEASURED QUANTITIES UNLESS NOTED OTHERWISE AS: (P)=PLAT MEASUREMENT; (M)=FIELD MEASUREMENT; (C)=CALCULATED MEASUREMENT
- 7. THIS SURVEY PREPARED WITHOUT BENEFIT OF TITLE AND MAY BE SUBJECT TO EASEMENTS, RIGHT-OF-WAYS AND OTHER ENCUMBRANCES WHICH MIGHT BE REVEALED IN A SEARCH OF TITLE TO THE SUBJECT LAND.
- 8. THE SURVEY WAS PREPARED FOR THE EXCLUSIVE USE OF THE PERSONS OR ENTITY NAMED IN CERTIFICATION HEREON. SAID CERTIFICATION DOES NOT EXTEND TO ANY UNNAMED PERSON, WITHOUT THE EXPRESS RECERTIFICATION BY THE SURVEYOR NAMING SAID PERSON.
- 9. THERE HAS BEEN NO ATTEMPT TO LOCATE ANY SUBSURFACE IMPROVEMENTS, FOOTERS, FOOTINGS AND/OR UTILITIES ON THIS PROPERTY.
- 10. SUBJECT PROPERTY LIES IN FLOOD ZONE "X" (MINIMAL FLOOD HAZARD) PER FEDERAL EMERGENCY MANAGEMENT AGENCY (FEMA) FLOOD ZONE MAP #12099C0179F, DATED OCTOBER 5, 2017. NO FIELD SURVEYING WAS PERFORMED TO DETERMINE THIS ZONE.
- 11. LOT AREA = 9,445 SQUARE FEET (0.21683 ACRES) MORE OR LESS.

LEGAL DESCRIPTION (PER OFFICIAL RECORDS BOOK 34728, PAGE 232)

LOT 34, JUPITER INLET BEACH COLONY, ACCORDING TO THE MAP OR PLAT THEREOF, AS RECORDED IN PLAT BOOK 24, PAGE(S) 139, OF THE PUBLIC RECORDS OF PALM BEACH COUNTY, FLORIDA.

CERTIFICATION VALID TO: 1. 13 SOUTH CONSTRUCTION LLC

#### **CERTIFICATION:**

I HEREBY CERTIFY THAT THIS SURVEY WAS MADE UNDER MY RESPONSIBLE CHARGE AND MEETS THE STANDARDS OF PRACTICE AS SET FORTH BY THE FLORIDA BOARD OF PROFESSIONAL SURVEYORS AND MAPPERS IN CHAPTER 5J-17, FLORIDA ADMINISTRATIVE CODE, PURSUANT TO SECTION 472.027, FLORIDA STATUTES.

R. L. VAUGHT & ASSOCIATES, INC. LICENSED BUSINESS #5879  $\square$ 11 ranella By:

FIELD WORK: Jan. 15, 2024

DATE OF LAST

P. Michael Zarrella Professional Surveyor & Mapper #6736 State of Florida

	AUGHT & ASSOCIATES, INC.       BOUNDARY AND       MOUNDARY AND         VEYORS, MAPPERS & PLANNERS       EDOUNDARY AND       EDOUNDARY AND         VEYORS, MAPPERS & PLANNERS       TOPOGRAPHIC SURVEY       EDOUNDARY AND         75 SE BRIDGE ROAD; HOBE SOUND 33455       34 OCEAN DRIVE       SURVEY         11. P.O. BOX 160 HOBE SOUND, FL 33475       34 OCEAN DRIVE       MUPITER, FLORIDA 33469         NE: 772-546-8086       FAX: 772-546-8087       34 OCEAN DRIVE         Ne: 772-546-8086       FAX: 772-546-8087       MUPITER, FLORIDA 33469	RL. VAUGHT & ASSOCIATES, INC. RL. VAUGHT & ASSOCIATES, INC. BOUNDARY AND SURVEYORS, MAPPERS & PLANNERS Mail: P.O. BOX 160 HOBE SOUND 33455 Mail: P.O. BOX 160 HOBE SOUND 33455 Mail: P.O. BOX 160 HOBE SOUND, FL 33475 Mail: P.O. BOX 160 HOBE SOUND, FL 33469 Mail: P.O. BOX 160 H
AUGHT & ASSOCIATES, INC.         VEYORS, MAPPERS & PLANNERS, INC.         VEYORS, MAPPERS & PLANNERS         CENSED SURVEY BUSINESS NUMBER 5879         75 SE BRIDGE ROAD; HOBE SOUND 33455         IL: P.O. BOX 160 HOBE SOUND, FL 33475         NE: 772-546-8086         EMAIL: vaught@bellsouth.net	RL. VAUGHT & ASSOCIATES, INC. RL. VAUGHT & ASSOCIATES, INC. BOU SURVEYORS, MAPPERS & PLANNERS & SURVEYORS, MAPPERS & PLANNERS BURVEY BUSINESS NUMBER 5879 DEAMN DEAMN DATE DEAMN DATE DATE SCATE DEAMN DATE DATE DATE SCATE DEAMN DATE DATE DATE DATE DATE DATE DATE DATE	RL. VAUGHT & ASSOCIATES, INC.       R.L. VAUGHT & ASSOCIATES, INC.         RL. VAUGHT & ASSOCIATES, INC.       BOU         A BOU       SURVEYORS, MAPPERS & PLANNERS         Incensed survey business number 5879       Incensed survey business number 5879         Incensed survey business number 5879       Incensed survey business number 5879         Incensed survey business number 5879       Incensed survey business number 5879         Incensed survey business number 5879       Incensed survey business number 5879         Incensed survey business number 5879       Incensed survey business number 5879         Incensed survey business number 5879       Incensed survey business number 5879         Incensed survey fully the sound, fill 33475       Incensed survey to the sound, fill 33475         Incensed fully would be sound, fill 33475       Incensed state 772-546-8087         Incensed fully would be sound, fill 33475       Incensed state 772-546-8087
AUGHT & ASSOCIATES, INC.         VEYORS, MAPPERS & PLANNERS, INC.         VEYORS, MAPPERS & PLANNERS         CENSED SURVEY BUSINESS NUMBER 5879         75 SE BRIDGE ROAD; HOBE SOUND 33455         IL: P.O. BOX 160 HOBE SOUND, FL 33475         NE: 772-546-8086         EMAIL: vaught@bellsouth.net	RL. VAUGHT & ASSOCIATES, INC. RL. VAUGHT & ASSOCIATES, INC. BOU SURVEYORS, MAPPERS & PLANNERS & SURVEYORS, MAPPERS & PLANNERS BURVEY BUSINESS NUMBER 5879 DEAMN DEAMN DATE DEAMN DATE DATE SCATE DEAMN DATE DATE DATE SCATE DEAMN DATE DATE DATE DATE DATE DATE DATE DATE	RL. VAUGHT & ASSOCIATES, INC.       R.L. VAUGHT & ASSOCIATES, INC.         RL. VAUGHT & ASSOCIATES, INC.       BOU         A BOU       SURVEYORS, MAPPERS & PLANNERS         Incensed survey business number 5879       Incensed survey business number 5879         Incensed survey business number 5879       Incensed survey business number 5879         Incensed survey business number 5879       Incensed survey business number 5879         Incensed survey business number 5879       Incensed survey business number 5879         Incensed survey business number 5879       Incensed survey business number 5879         Incensed survey business number 5879       Incensed survey business number 5879         Incensed survey fully the sound, fill 33475       Incensed survey to the sound, fill 33475         Incensed fully would be sound, fill 33475       Incensed state 772-546-8087         Incensed fully would be sound, fill 33475       Incensed state 772-546-8087
AUGHT & ASSOCIATES, INC.         VEYORS, MAPPERS & PLANNERS, INC.         VEYORS, MAPPERS & PLANNERS         CENSED SURVEY BUSINESS NUMBER 5879         75 SE BRIDGE ROAD; HOBE SOUND 33455         IL: P.O. BOX 160 HOBE SOUND, FL 33475         NE: 772-546-8086         EMAIL: vaught@bellsouth.net	RL. VAUGHT & ASSOCIATES, INC. RL. VAUGHT & ASSOCIATES, INC. BOU SURVEYORS, MAPPERS & PLANNERS & SURVEYORS, MAPPERS & PLANNERS BURVEY BUSINESS NUMBER 5879 DEAMN DEAMN DATE DEAMN DATE DATE SCATE DEAMN DATE DATE DATE SCATE DEAMN DATE DATE DATE DATE DATE DATE DATE DATE	RL. VAUGHT & ASSOCIATES, INC. RL. VAUGHT & ASSOCIATES, INC. BOU SURVEYORS, MAPPERS & PLANNERS MAIL: P.O. BOX 160 HOBE SOUND 33455 MAIL: P.O. BOX 160 HOBE SOUND, FL 33475 MAIL: P.O. BOX 160 HOBE FL AND
AUGHT & ASSOCIATES, INC.         VEYORS, MAPPERS & PLANNERS, INC.         VEYORS, MAPPERS & PLANNERS, INC.         CENSED SURVEY BUSINESS NUMBER 5879         75 SE BRIDGE ROAD; HOBE SOUND 33455         IL: P.O. BOX 160 HOBE SOUND, FL 33475         IL: P.O. BOX 160 HOBE SOUND, FL 33475         Ne: 772-546-8086         FAMIL: vaught@bellsouth.net	RL. VAUGHT & ASSOCIATES, INC. RL. VAUGHT & ASSOCIATES, INC. BOU SURVEYORS, MAPPERS & PLANNERS, INC. SURVEYORS, MAPPERS & PLANNERS BUNDER 5879 9075 SE BRIDGE ROAD; HOBE SOUND 33455 MAIL: P.O. BOX 160 HOBE SOUND, FL 33475 MAIL: P.O. BOX 160 HOBE SO	RL. VAUGHT & ASSOCIATES, INC. RL. VAUGHT & ASSOCIATES, INC. RL. VAUGHT & ASSOCIATES, INC. SURVEYORS, MAPPERS & PLANNERS, INC. DICENSED SURVEY BUSINESS NUMBER 5879 9075 SE BRIDGE ROAD; HOBE SOUND 33455 MAIL: P.O. BOX 160 HOBE SOUND 33455 MAIL: P.O. BOX 160 HOBE SOUND, FL 33475 MAIL: P.O. BOX 160 HOBE SOUND, FL 33475 PHONE: 772-546-8086 FAX: 772-546-8087 EMAIL: vaught@bellsouth.net
AUGHT & ASSOCIATES, INC.         VEYORS, MAPPERS & PLANNERS, INC.         VEYORS, MAPPERS & PLANNERS         CENSED SURVEY BUSINESS NUMBER 5879         75 SE BRIDGE ROAD; HOBE SOUND 33455         IL: P.O. BOX 160 HOBE SOUND, FL 33475         NE: 772-546-8086         EMAIL: vaught@bellsouth.net	RL. VAUGHT & ASSOCIATES, INC. RL. VAUGHT & ASSOCIATES, INC. BOU SURVEYORS, MAPPERS & PLANNERS & SURVEYORS, MAPPERS & PLANNERS BURVEY BUSINESS NUMBER 5879 DEAMN DEAMN DATE DEAMN DATE DATE SCATE DEAMN DATE DATE DATE SCATE DEAMN DATE DATE DATE DATE DATE DATE DATE DATE	R.L. VAUGHT & ASSOCIATES, INC. R.L. VAUGHT & ASSOCIATES, INC. R.L. VAUGHT & ASSOCIATES, INC. SURVEYORS, MAPPERS & PLANNERS, INC. DICENSED SURVEY BUSINESS NUMBER 5879 9075 SE BRIDGE ROAD; HOBE SOUND 33455 MAIL: P.O. BOX 160 HOBE SOUND 33455 MAIL: P.O. BOX 160 HOBE SOUND, FL 33475 MAIL: P.O. BOX 160 HOBE SOUND, FL 33475 MAIL: P.O. BOX 160 HOBE SOUND, FL 33475 PHONE: 772-546-8086 FAX: 772-546-8087 EMAIL: vaught@bellsouth.net
AUGHT & ASSOCIATES, INC.         VEYORS, MAPPERS & PLANNERS, INC.         VEYORS, MAPPERS & PLANNERS, INC.         CENSED SURVEY BUSINESS NUMBER 5879         75 SE BRIDGE ROAD; HOBE SOUND 33455         IL: P.O. BOX 160 HOBE SOUND, FL 33475         IL: P.O. BOX 160 HOBE SOUND, FL 33475         Ne: 772-546-8086         FAMIL: vaught@bellsouth.net	RL. VAUGHT & ASSOCIATES, INC. RL. VAUGHT & ASSOCIATES, INC. BOU SURVEYORS, MAPPERS & PLANNERS, INC. SURVEYORS, MAPPERS & PLANNERS BUNDER 5879 9075 SE BRIDGE ROAD; HOBE SOUND 33455 MAIL: P.O. BOX 160 HOBE SOUND, FL 33475 MAIL: P.O. BOX 160 HOBE SO	RL. VAUGHT & ASSOCIATES, INC. RL. VAUGHT & ASSOCIATES, INC. RL. VAUGHT & ASSOCIATES, INC. SURVEYORS, MAPPERS & PLANNERS, INC. DICENSED SURVEY BUSINESS NUMBER 5879 9075 SE BRIDGE ROAD; HOBE SOUND 33455 MAIL: P.O. BOX 160 HOBE SOUND 33455 MAIL: P.O. BOX 160 HOBE SOUND, FL 33475 MAIL: P.O. BOX 160 HOBE SOUND, FL 33475 PHONE: 772-546-8086 FAX: 772-546-8087 EMAIL: vaught@bellsouth.net
AUGHT & ASSOCIATES, INC.         VEYORS, MAPPERS & PLANNERS, INC.         VEYORS, MAPPERS & PLANNERS         CENSED SURVEY BUSINESS NUMBER 5879         75 SE BRIDGE ROAD; HOBE SOUND 33455         IL: P.O. BOX 160 HOBE SOUND, FL 33475         NE: 772-546-8086         EMAIL: vaught@bellsouth.net	RL. VAUGHT & ASSOCIATES, INC. RL. VAUGHT & ASSOCIATES, INC. BOU SURVEYORS, MAPPERS & PLANNERS & SURVEYORS, MAPPERS & PLANNERS BURVEY BUSINESS NUMBER 5879 DEAMN DEAMN DATE DEAMN DATE DATE SCATE DEAMN DATE DATE DATE SCATE DEAMN DATE DATE DATE DATE DATE DATE DATE DATE	R.L. VAUGHT & ASSOCIATES, INC. R.L. VAUGHT & ASSOCIATES, INC. R.L. VAUGHT & ASSOCIATES, INC. SURVEYORS, MAPPERS & PLANNERS, INC. DICENSED SURVEY BUSINESS NUMBER 5879 9075 SE BRIDGE ROAD; HOBE SOUND 33455 MAIL: P.O. BOX 160 HOBE SOUND 33455 MAIL: P.O. BOX 160 HOBE SOUND, FL 33475 MAIL: P.O. BOX 160 HOBE SOUND, FL 33475 MAIL: P.O. BOX 160 HOBE SOUND, FL 33475 PHONE: 772-546-8086 FAX: 772-546-8087 EMAIL: vaught@bellsouth.net
AUGHT & ASSOCIATES, INC.         VEYORS, MAPPERS & PLANNERS, INC.         VEYORS, MAPPERS & PLANNERS         CENSED SURVEY BUSINESS NUMBER 5879         75 SE BRIDGE ROAD; HOBE SOUND 33455         IL: P.O. BOX 160 HOBE SOUND, FL 33475         NE: 772-546-8086         EMAIL: vaught@bellsouth.net	RL. VAUGHT & ASSOCIATES, INC. RL. VAUGHT & ASSOCIATES, INC. BOU SURVEYORS, MAPPERS & PLANNERS, INC. SURVEYORS, MAPPERS & PLANNERS BURNESS NUMBER 5879 9075 SE BRIDGE ROAD; HOBE SOUND 33455 MAIL: P.O. BOX 160 HOBE SOUND 33455 MAIL: P.O. BOX 160 HOBE SOUND, FL 33475 MAIL: P.O. BOX 160 HOBE SOUND, FL 33475 PHONE: 772-546-8086 FAX: 772-546-8087 TOPDEF NOW 541/50 OUDEL NOU 541/50 OUDEL NOU 541/50 OUD	RL. VAUGHT & ASSOCIATES, INC. RL. VAUGHT & ASSOCIATES, INC. SURVEYORS, MAPPERS & PLANNERS, INC. SURVEYORS, MAPPERS & PLANNERS MAIL: PLOBE SOUND 33455 MAIL: PLO. BOX 160 HOBE SOUND 33455 MAIL: PLO. BOX 160 HOBE SOUND 33455 MAIL: PLO. BOX 160 HOBE SOUND, FL 33475 MAIL: PLO. BOX 160 HOBE SOUND FL 33455 MAIL: PLO. BOX 160 HOBE SOUND FL
	DRAWN PMZ CHECKED PMZ SCALE AS SHOWN DATE JAN. 19, 2024 FIELD BOOK 241/26 ORDER NO. 819346 SHEET OF SHEETS	DRAWN PMZ CHECKED PMZ SCALE AS SHOWN DATE
	PMZ CHECKED PMZ SCALE AS SHOWN DATE JAN. 19, 2024 FIELD BOOK 241/26 ORDER NO. 819346 SHEET OF SHEETS	PMZ CHECKED PMZ SCALE AS SHOWN DATE
	PMZ SCALE AS SHOWN DATE JAN. 19, 2024 FIELD BOOK 241/26 ORDER NO. 819346 SHEET OF SHEETS	PMZ SCALE AS SHOWN DATE
	AS SHOWN DATE JAN. 19, 2024 FIELD BOOK 241/26 ORDER NO. 819346 SHEET OF SHEETS	AS SHOWN DATE
CHECKED	DATE JAN. 19, 2024 FIELD BOOK 241/26 ORDER NO. 819346 SHEET OF SHEETS	DATE
CHECKED PMZ SCALE	FIELD BOOK 241/26 ORDER NO. 819346 SHEET OF SHEETS	JAN. 19, 2024
CHECKED PMZ SCALE AS SHOWN DATE	241/26 ORDER NO. 819346 SHEET OF SHEETS	
CHECKED PMZ SCALE AS SHOWN DATE JAN. 19, 2024	819346 SHEET OF SHEETS	241/26
CHECKED PMZ SCALE AS SHOWN DATE JAN. 19, 2024 FIELD BOOK 241/26	SHEET OF SHEETS	
CHECKED PMZ SCALE AS SHOWN DATE JAN. 19, 2024 FIELD BOOK 241/26 ORDER NO.		


# **DOCUMENT QUALIFICATION**

THIS DRAWING WAS PREPARED BASED ON INFORMATION PROVIDED BY THE OWNER AND OR THE CONTRACTOR IN THE FORM OF A BOUNDARY SURVEY PREPARED BY RL VAUGHT AND ASSOCIATES, INC. DATED 1-19-24 DRAWING NO. PB19346-24H SHEET 1 OF 2. USE WITHOUT VERIFICATION WILL BE AT THE USER'S SOLE RISK. THE USER SHALL INDEMNIFY THE ARCHITECT "VILLAGE ARCHITECTS AIA" FROM ALL CLAIMS AND LOSSES RESULTING FROM SUCH USE. THE DELIVERY OF THIS DRAWING TO THE USER SHOULD NOT BE CONSTRUED TO PROVIDE AN EXPRESS WARRANTY OR A GUARANTEE TO ANYONE THAT CERTAIN CONDITIONS EXIST OR THAT THE USE OF THIS DRAWING IMPLIES THE REVIEW AND APPROVAL BY THE ARCHITECT OF ANY SHOP DRAWING BASED ON THIS INFORMATION. USE OF THIS DRAWING IN NO WAY RELIEVES ANY OTHER PARTY FROM MEETING REQUIREMENTS IMPOSED BY CONTRACT OR OTHER MEANS.

# PARTIAL LEGAL DESCRIPTION

LOT 34, JUPITER INLET BEACH COLONY, ACCORDING TO THE MAP OR PLAT THEREOF, AS RECORDED IN PLAT BOOK 24, PAGE(S) 139, OF THE PUBLIC RECORDS OF PALM BEACH COUNTY, FLORIDA.

REFER TO THE SURVEY FOR FULL LEGAL DESCRIPTION

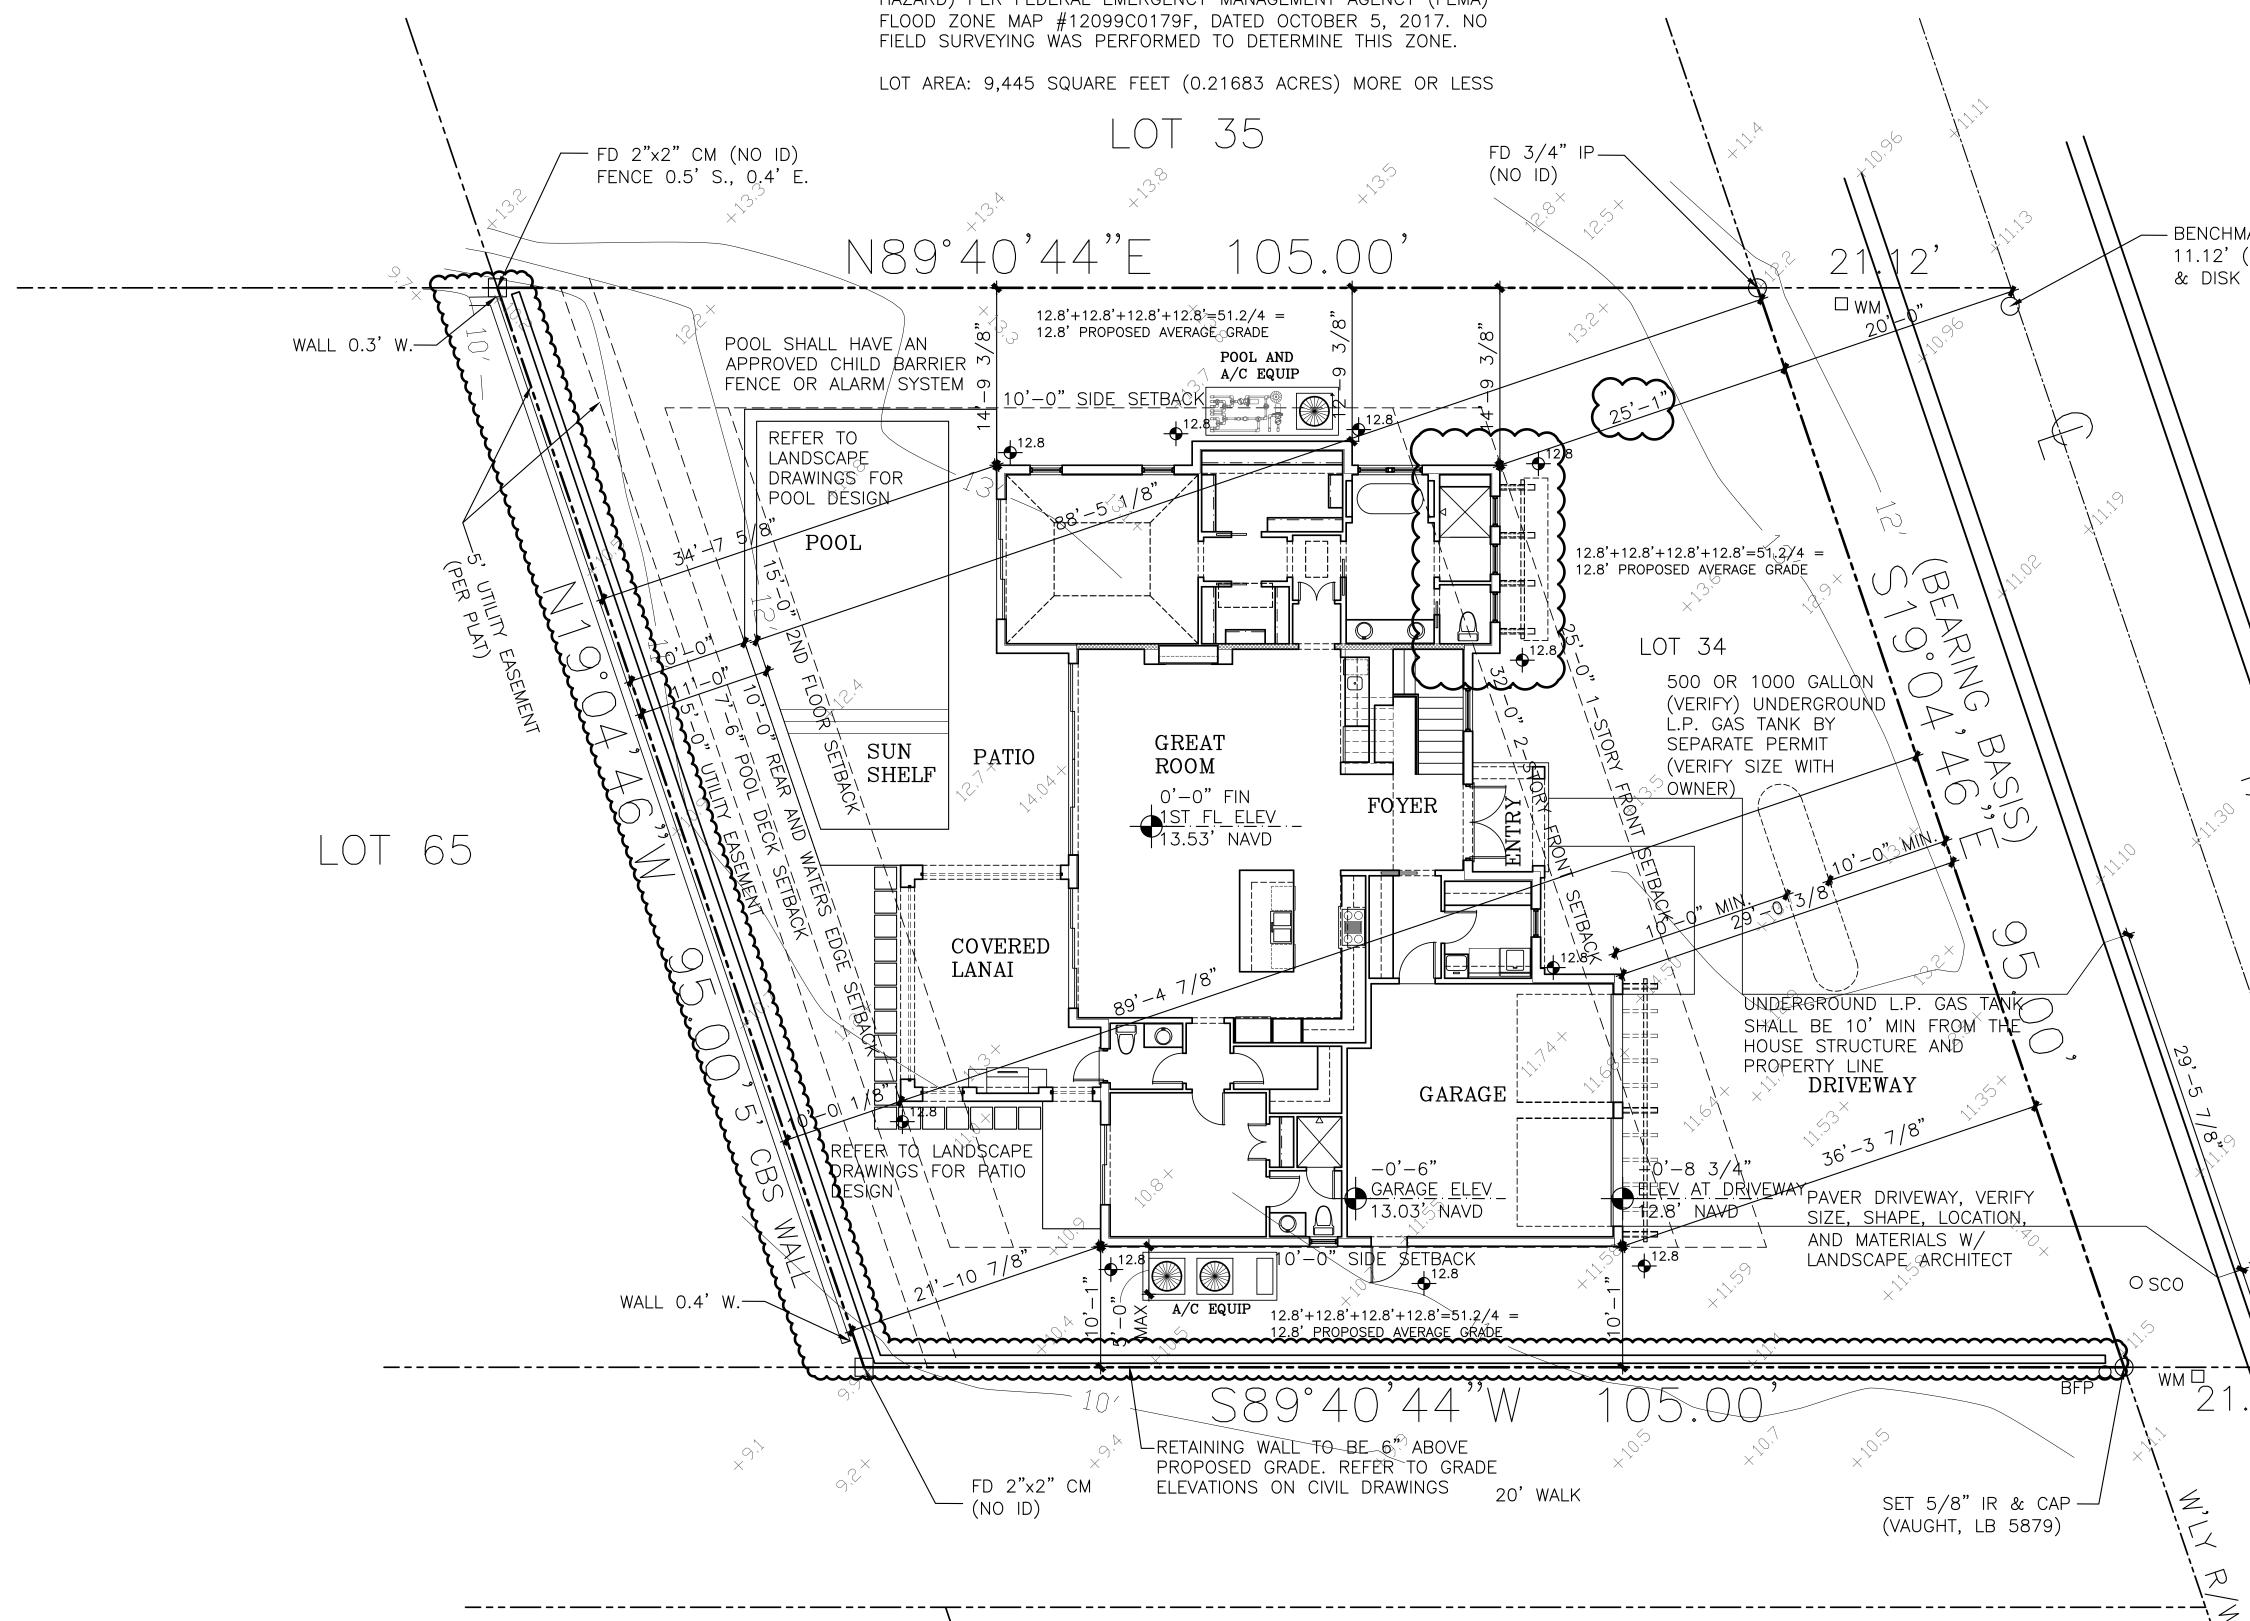

SUBJECT PROPERTY LIES IN FLOOD ZONE "X" (MINIMAL FLOOD HAZARD) PER FEDERAL EMERGENCY MANAGEMENT AGENCY (FEMA)

# SITE NOTES:

- 1. VERIFY LOCATION OF UTILITIES WITH SUBDIVISION BEF
- WITH WORK.
- 2. DRAINAGE TO BE INDICATED ON LANDSCAPE PLAN.
- 3. CONNECTION INSPECTION OF UTILITIES REQUIRED PRIC 4. CONTRACTOR TO HAVE CERTIFIED FLORIDA SURVEYOR BUILDING ON LOT TO ASSURE THAT NO SETBACKS OF ARE ENCROACHED
- 5. CONTRACTOR SHALL PROVIDE SOIL BORING TEST AND REPACK SOIL AS REQUIRED.
- 6. CONTRACTOR TO PROVIDE (1) 4" AND (1) 6" PVC SL DRIVEWAY

## **DESIGN CODES:**

- FLORIDA BUILDING CODE 8TH EDITION (2023)
- FBC EC FLORIDA BUILDING CODE ENERGY CONSERVAT
- (2023) • FBC RE FLORIDA RESIDENTIAL CODE 8TH EDITION (20 • FBC MECHANICAL 8TH EDITION (2023)
- FBC PLUMBING 8TH EDITION (2023)
- NEC NFPA 70 2020 EDITION, NATIONAL ELECTRICAL C • FS FLORIDA STATUTES

	LOT OCCUPANCY			
	LOI OCCOFANCI			
FORE PROCEEDING	LOT AREA	9,445	SQ. FT.	
	HOUSE FOOTPRINT-ENCLOSED	2,631	SQ. FT.	
IOR TO BACKFILL R LAYOUT DR EASEMENTS D DEMUCK AND	FRONT COVERED ENTRY COVERED PATIOS DRIVEWAY, PARKING AREAS EQUIPMENT PADS OVER 100 S.F. UNDER EAVES GREATER THAN 24" UNDER BREEZEWAYS	53 292 782 0 0 0	SQ. FT. SQ. FT. SQ. FT. SQ. FT. SQ. FT. SQ. FT.	VILLAGE ARCHITECTS AIA 400 N CYPRESS DRIVE, SUITE 21 Tequesta, FL 33469
SLEEVE UNDER	WALKS AND STEPPING STONES POOL POOL DECK AND PATIO BOUNDRY WALLS SEAWALLS	0 502 395 0 0	SQ. FT. SQ. FT. SQ. FT. SQ. FT. SQ. FT.	Phone: 561-743-4959 Fax: 561-743-1225 www.Village-Architects.com AA26001195
ATION 8TH EDITION	DUNE CROSSOVER OTHER HARDSCAPE	0	SQ. FT. SQ. FT. SQ. FT.	
2023)	TOTAL LOT OCCUPANCY AREA	4,655	SQ. FT.	
CODE	PROPOSED LOT OCCUPANCY		49.29%	
CODE	MAX ALLOWABLE LOT OCCUPANCY	4,723	50.0%	CE
	BUILDING LOT COVERAGE			
	LOT AREA	9,445	SQ. FT.	
	FIRST FLOOR FIRST FLOOR AIR CONDITIONED AREA GARAGE COVERED ENTRY UNDER EAVES GREATER THAN 24" COVERED PATIOS COVERED CARPORTS	497 53	SQ. FT. SQ. FT. SQ. FT. SQ. FT. SQ. FT. SQ. FT.	EW RESIDI 34 OCEAN DRIV TER INLET COLON OCEANIC HOM
MARK EL = (NAVD88) NL < (LB 5879)	SECOND FLOOR SECOND FLOOR AIR CONDITIONED AREA COVERED BALCONIES TOTAL BUILDING AREA FLOOR AREA PERCENTAGE CALCULATIONS	Ū	SQ. FT. SQ. FT. SQ. FT. SQ. FT.	DEW C
	TOTAL 1st FLOOR LOT PERCENTAGE	2,979	31.54%	$\pm$ $\pm$ $\pm$
	TOTAL 2nd FLOOR LOT PERCENTAGE	1,658	17.55%	4

Seal :

55.66%

Mitchell E. Miller Florida License No. AR91772 As Principal of Village Architects AIA, Inc.

Copyright 🔘 2024 Village Architects AIA All rights reserved. These drawings are the Property of the architect and are not to be used for any other projects except by agreement with The architect in writing.

Consultant:

Revisions : 3-12-24 JIC REVIEW


## Sheet Title: SITE PLAN

Scale:	
1/8" = 1'-0"	
Comm. :	Date :
23-041	12-7-23
Drawn :	Checked :
CRA	MEM


Sheet No.




PRINT DATE: 3-12-24

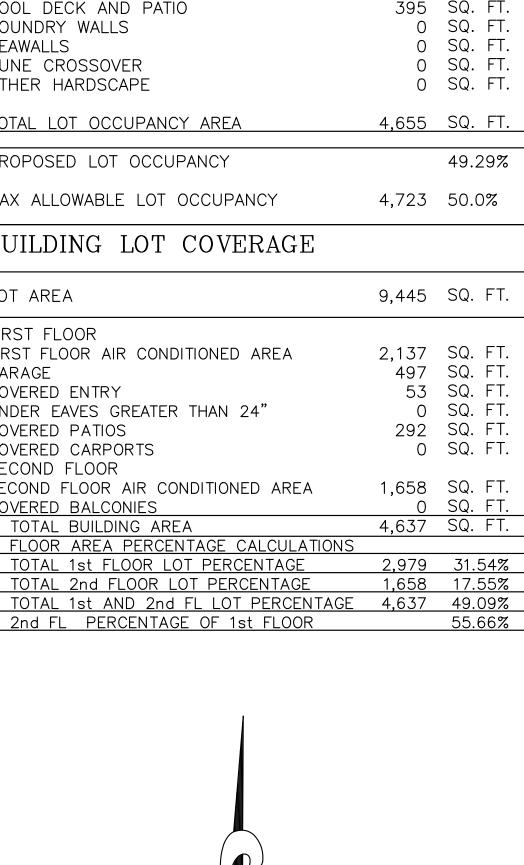


D Z - BENCHMARK EL = 11.47' (NAVD88) NL & DISK (LB 5879)

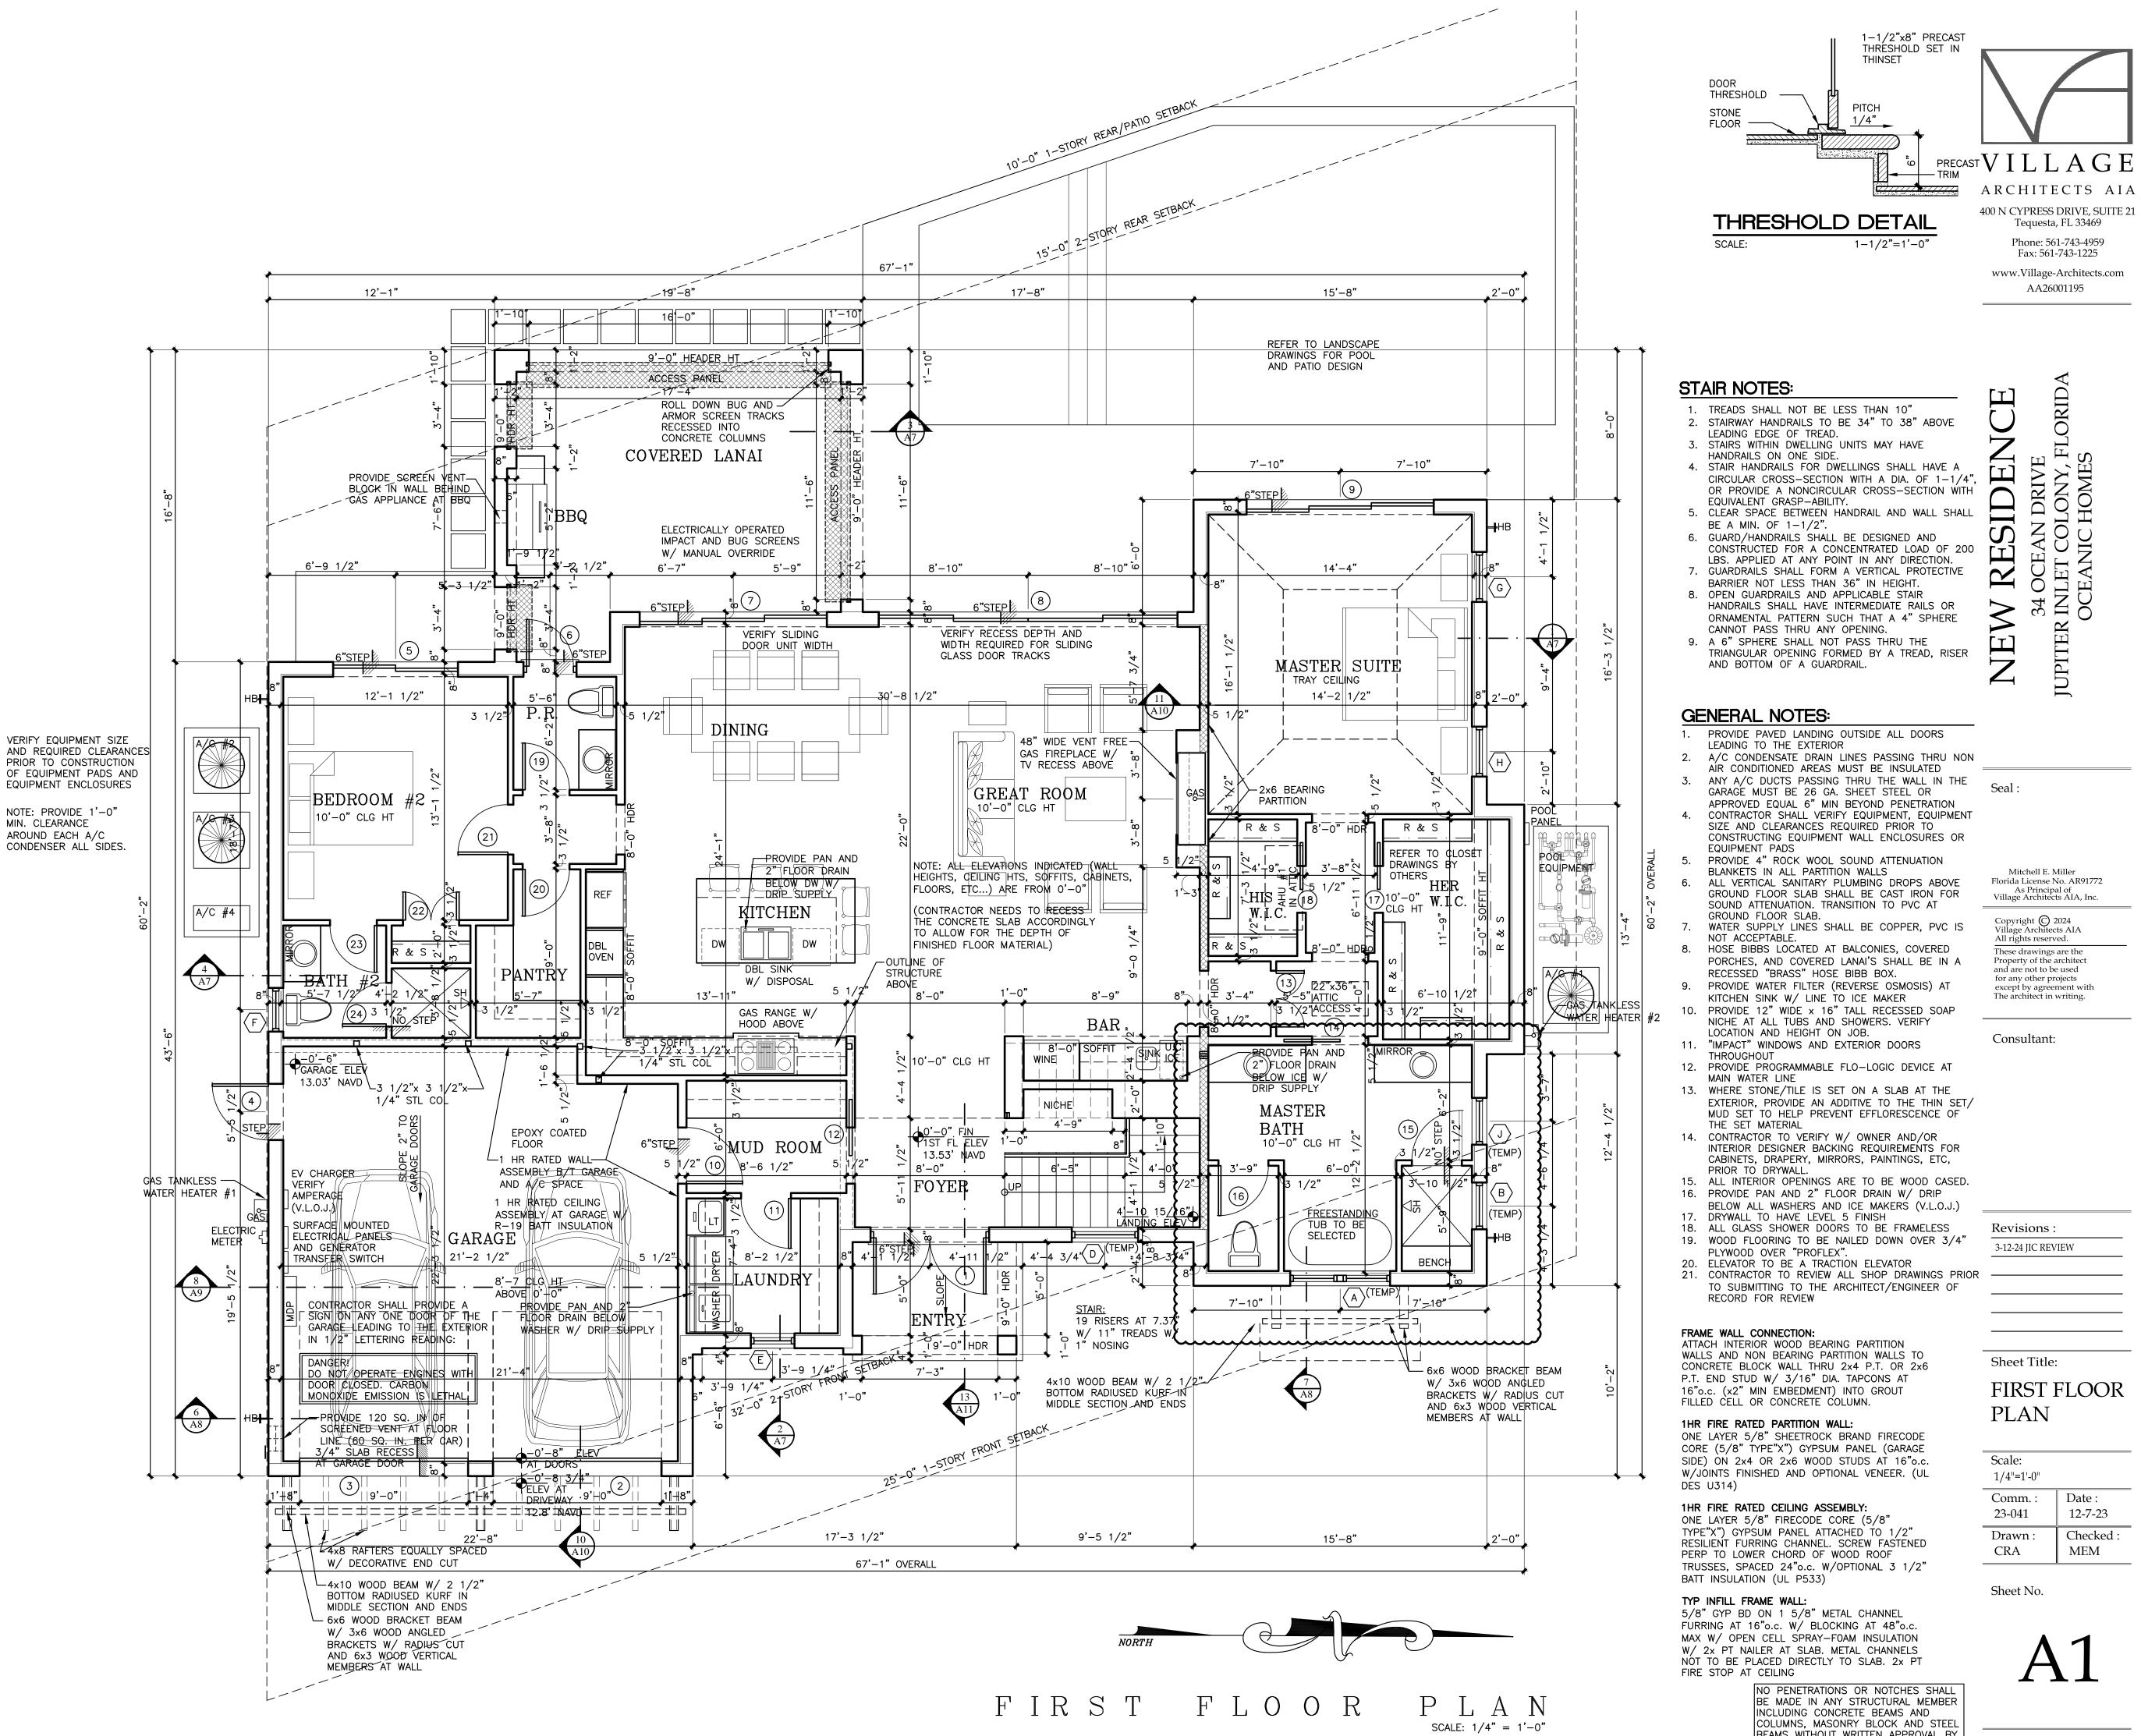

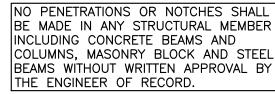

Scale: 1/4"=1'-0"	
Comm. :	Date :
23-041	12-7-23
Drawn :	Checked :
CRA	MEM



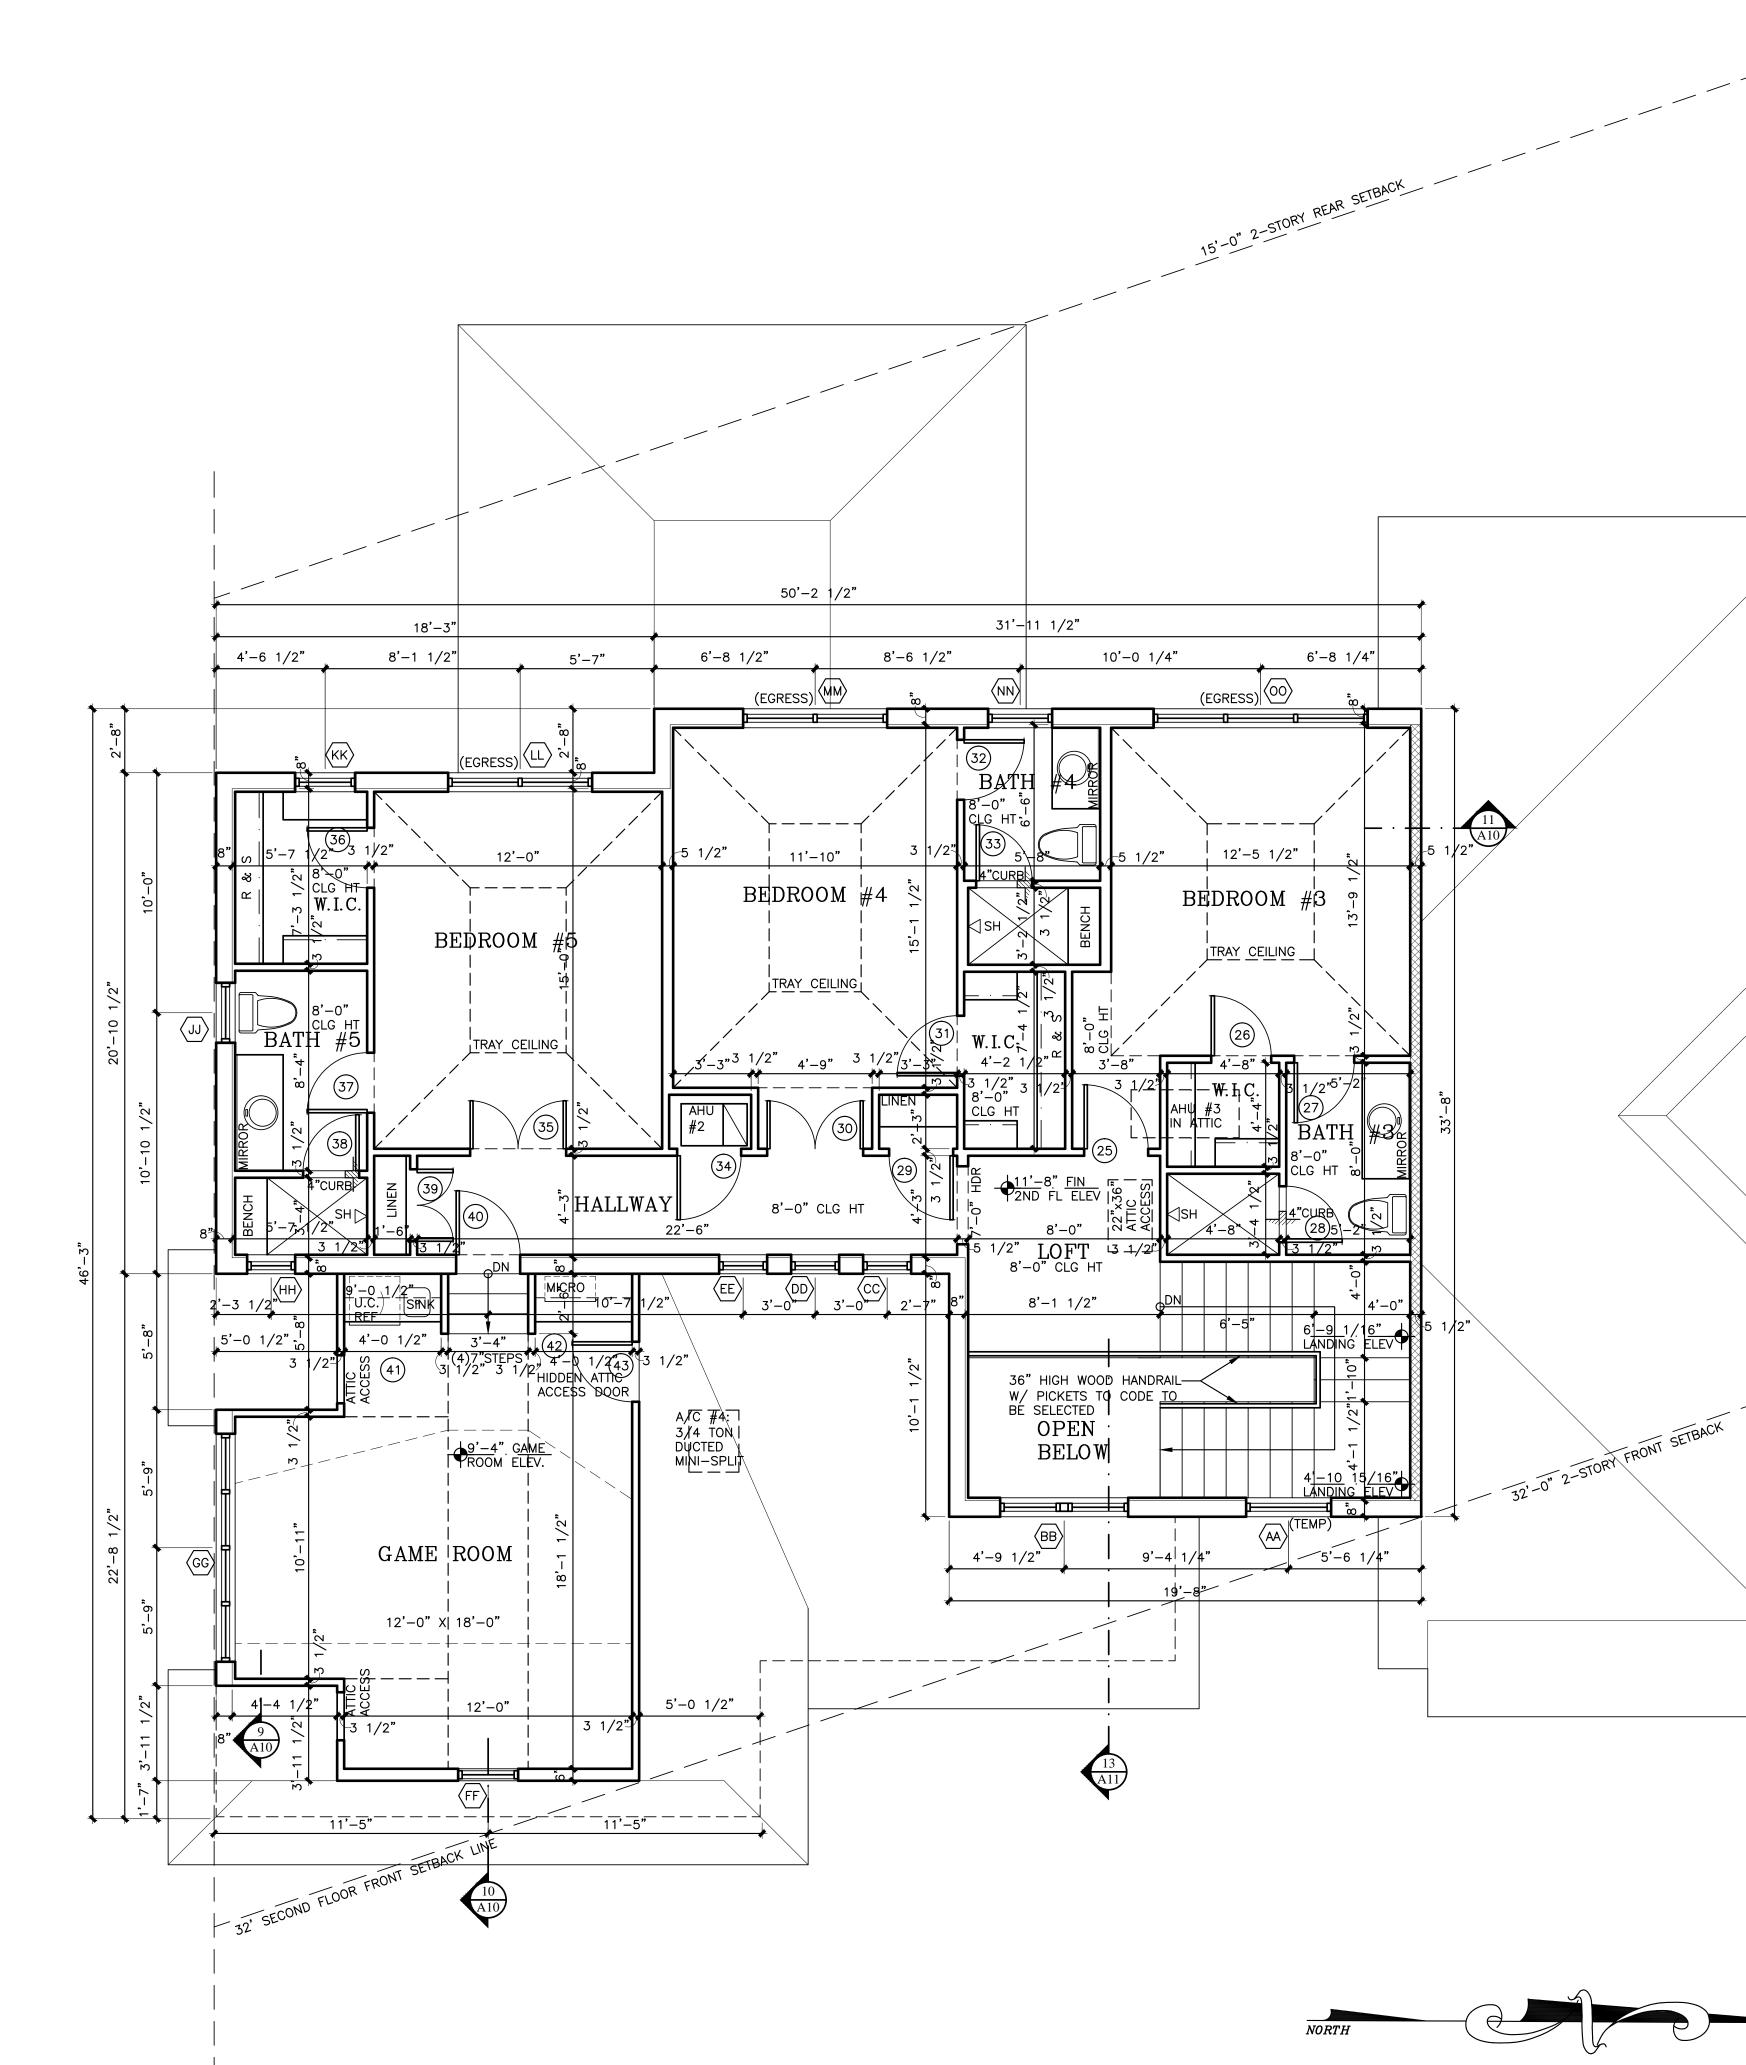





# NEW RESIDENCE 34 OCEAN DRIVE JUPITER INLET COLONY, FLORIDA OCEANIC HOMES

Seal :

Mitchell E. Miller Florida License No. AR91772 As Principal of Village Architects AIA, Inc.

Copyright O 2024 Village Architects AIA All rights reserved. These drawings are the Property of the architect and are not to be used for any other projects except by agreement with The architect in writing.

Consultant:

Revisions : 3-12-24 JIC REVIEW

## Sheet Title: SECOND FLOOR PLAN

Scale:	
1/4"=1'-0"	
Comm. :	Date :
23-041	12-7-23
Drawn :	Checked :
CRA	MEM


Sheet No.

\_\_\_\_\_



 $P_{\text{SCALE: }1/4"} = N_{1'-0"}$ 

NO PENETRATIONS OR NOTCHES SHALL BE MADE IN ANY STRUCTURAL MEMBER INCLUDING CONCRETE BEAMS AND COLUMNS, MASONRY BLOCK AND STEEL BEAMS WITHOUT WRITTEN APPROVAL BY THE ENGINEER OF RECORD.

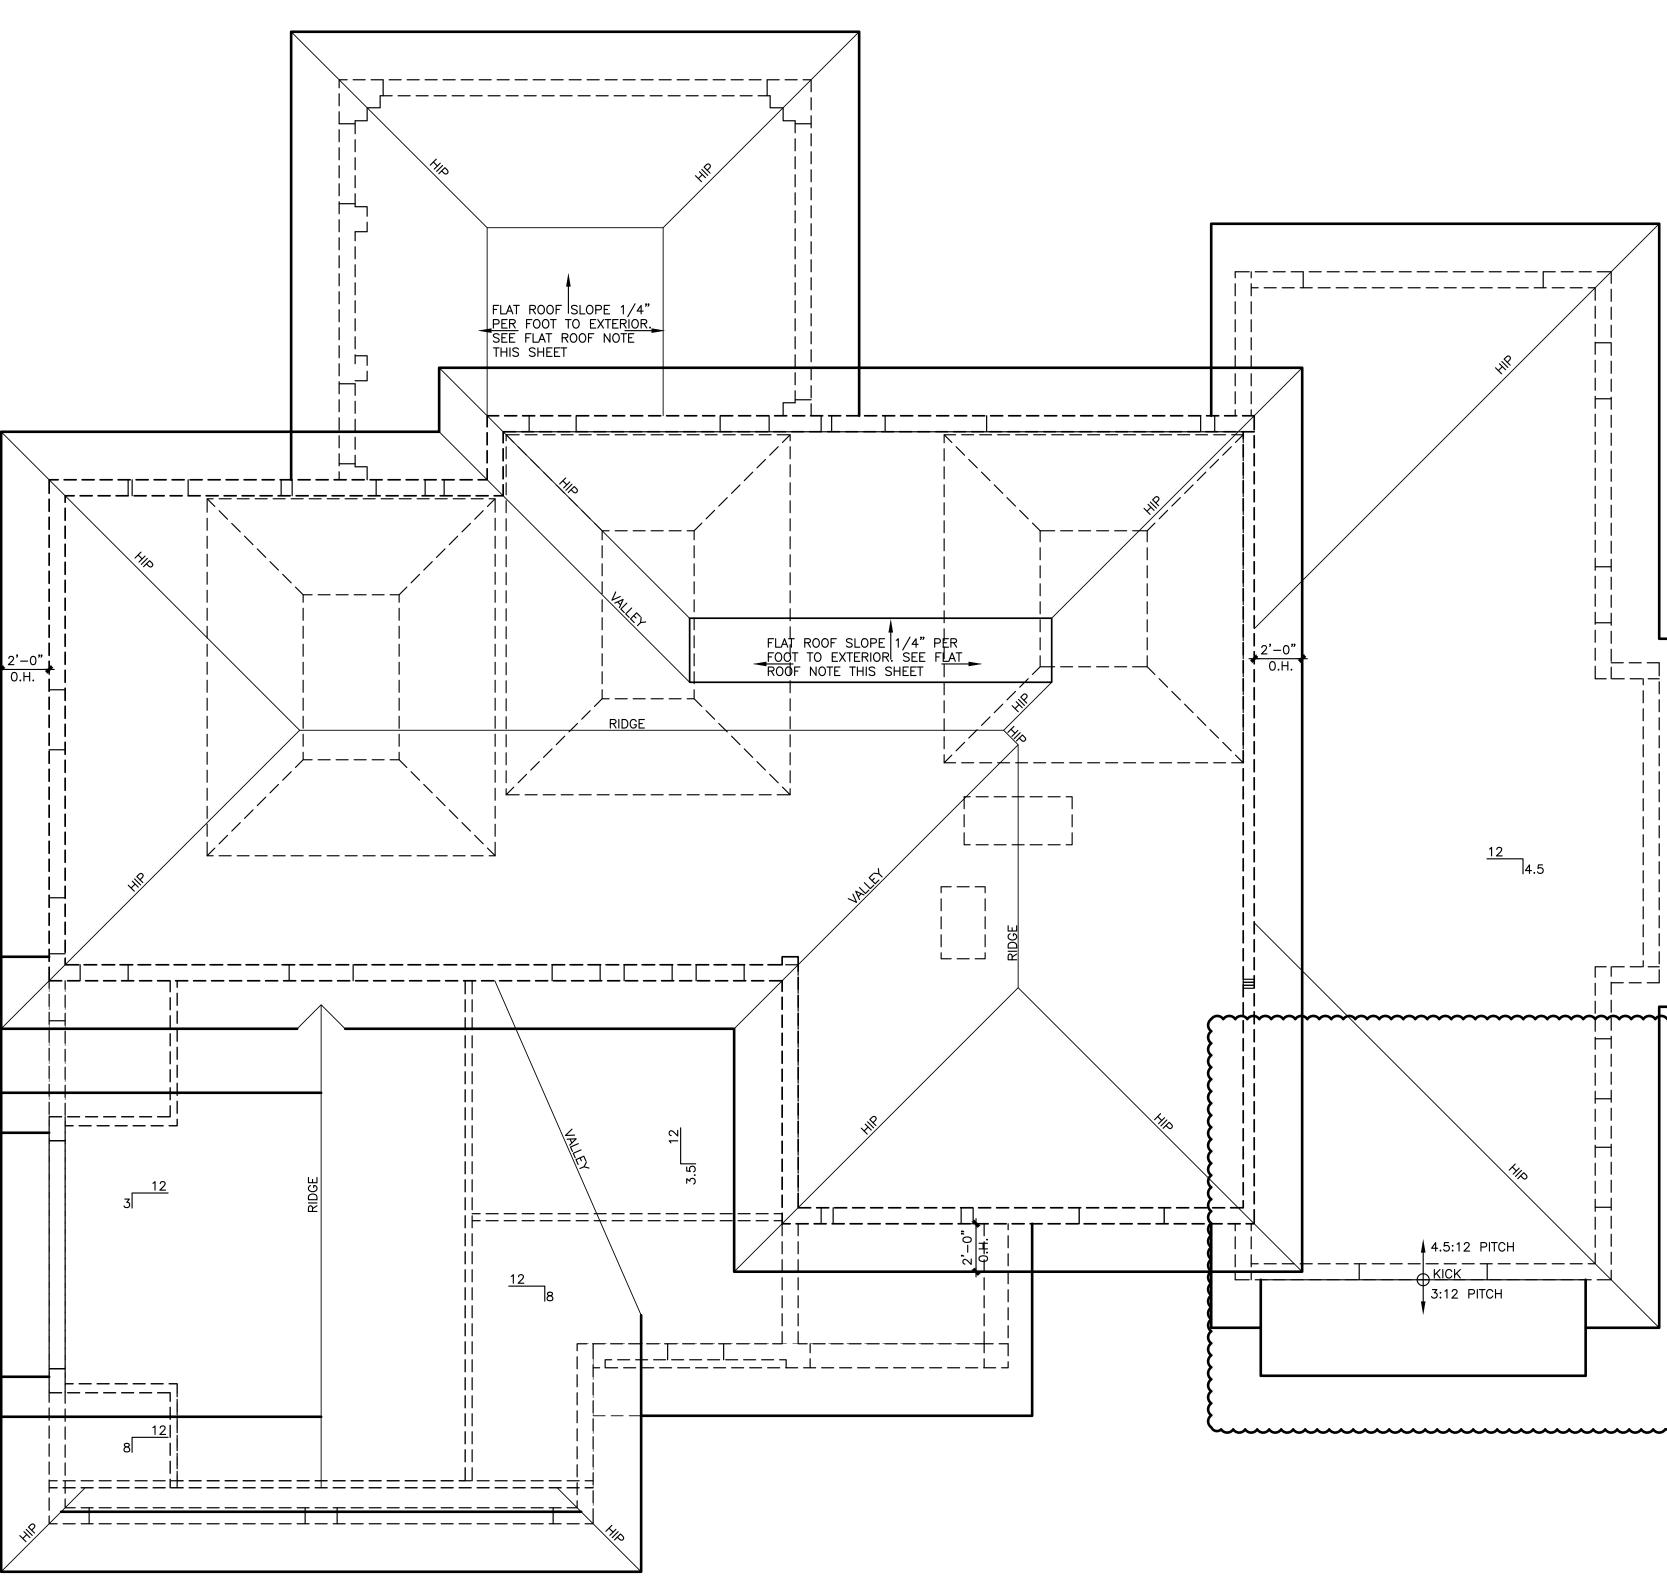



# CEAN DRIVE T COLONY, FLORIDA ANIC HOMES Щ RESIDENC INLE<sup>-</sup> OCEA 00 NEW 4 $\mathcal{O}$ JUPITER

Seal :

\_\_\_\_

Mitchell E. Miller Florida License No. AR91772 As Principal of Village Architects AIA, Inc.

Copyright (C) 2024 Village Architects AIA All rights reserved. These drawings are the Property of the architect and are not to be used for any other projects except by agreement with The architect in writing.

Consultant:

Revisions : 3-12-24 JIC REVIEW

\_\_\_\_\_

Sheet Title: ROOF PLAN


Scale: 1/4"=1'-0"	
Comm. :	Date :
23-041	12-7-23
Drawn :	Checked :
CRA	MEM

Sheet No.



 $\square$  $\square$ Ц <u>12</u> 4.5  $\sim$ Π  $\square$  $\square$  $\square$ 4.5:12 PITCH \_|\_\_\_\_ — \_\_ \_ \_ \_ \_ \_ \_ 3:12 PITCH




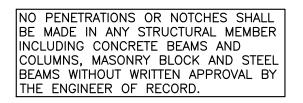


\_**∲**19'−8"\_\_BH

0'-0" FIN 1ST FL ELEV

\_ \_\_\_\_

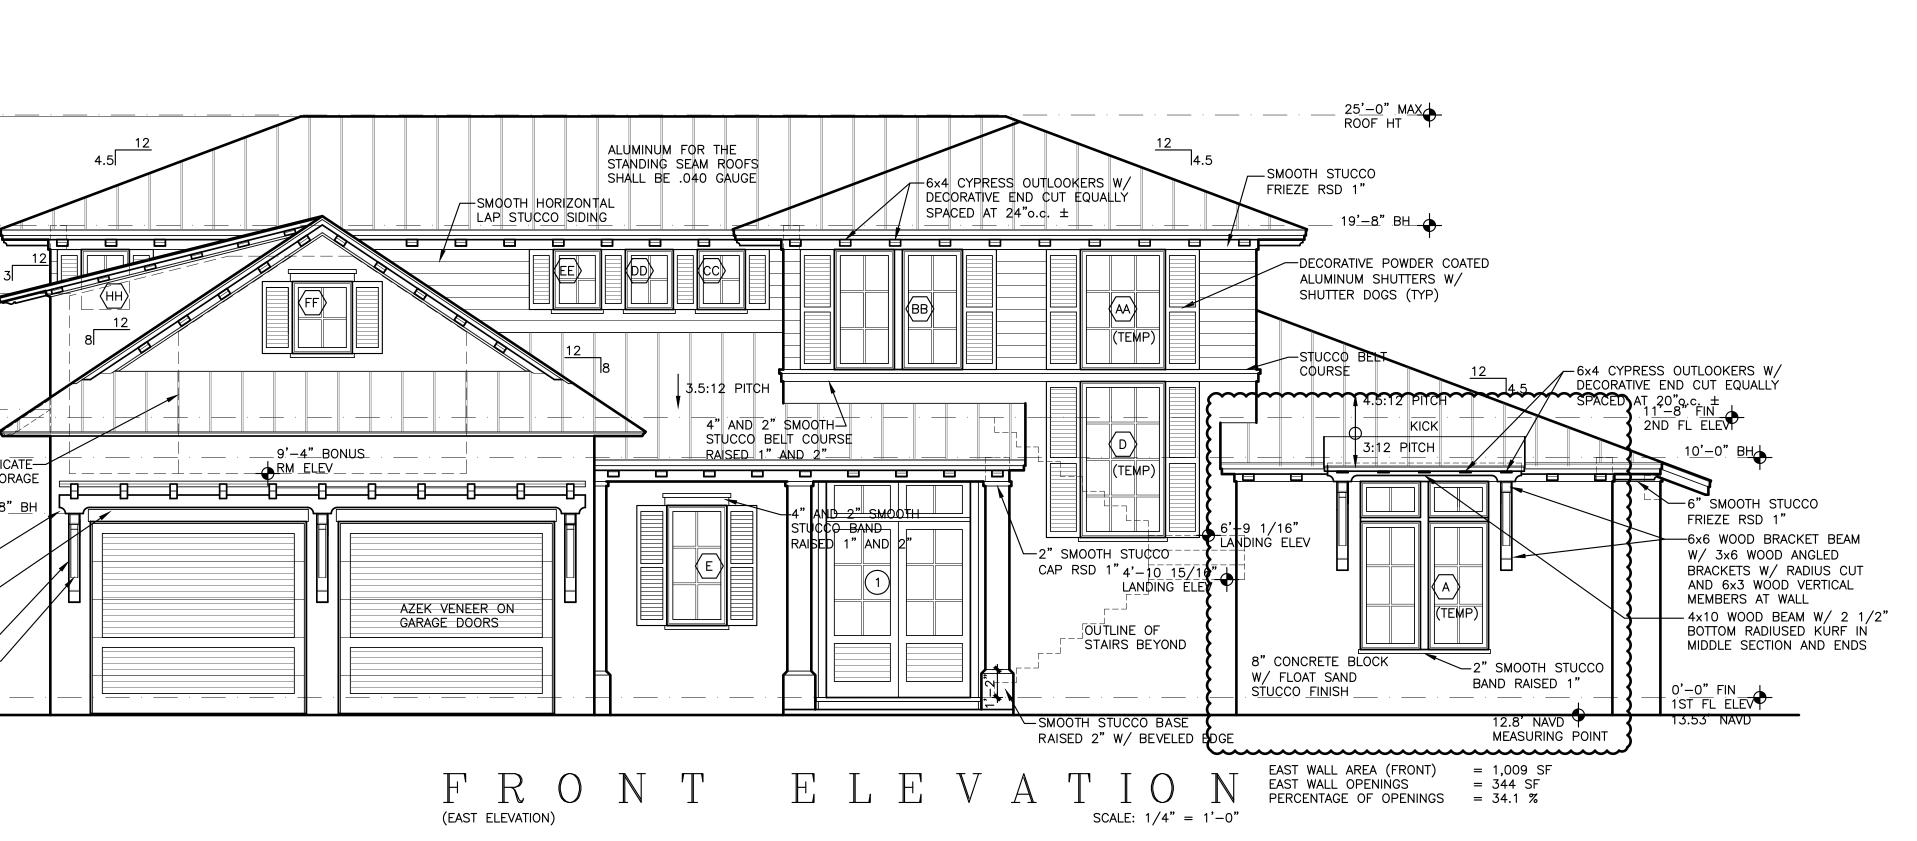

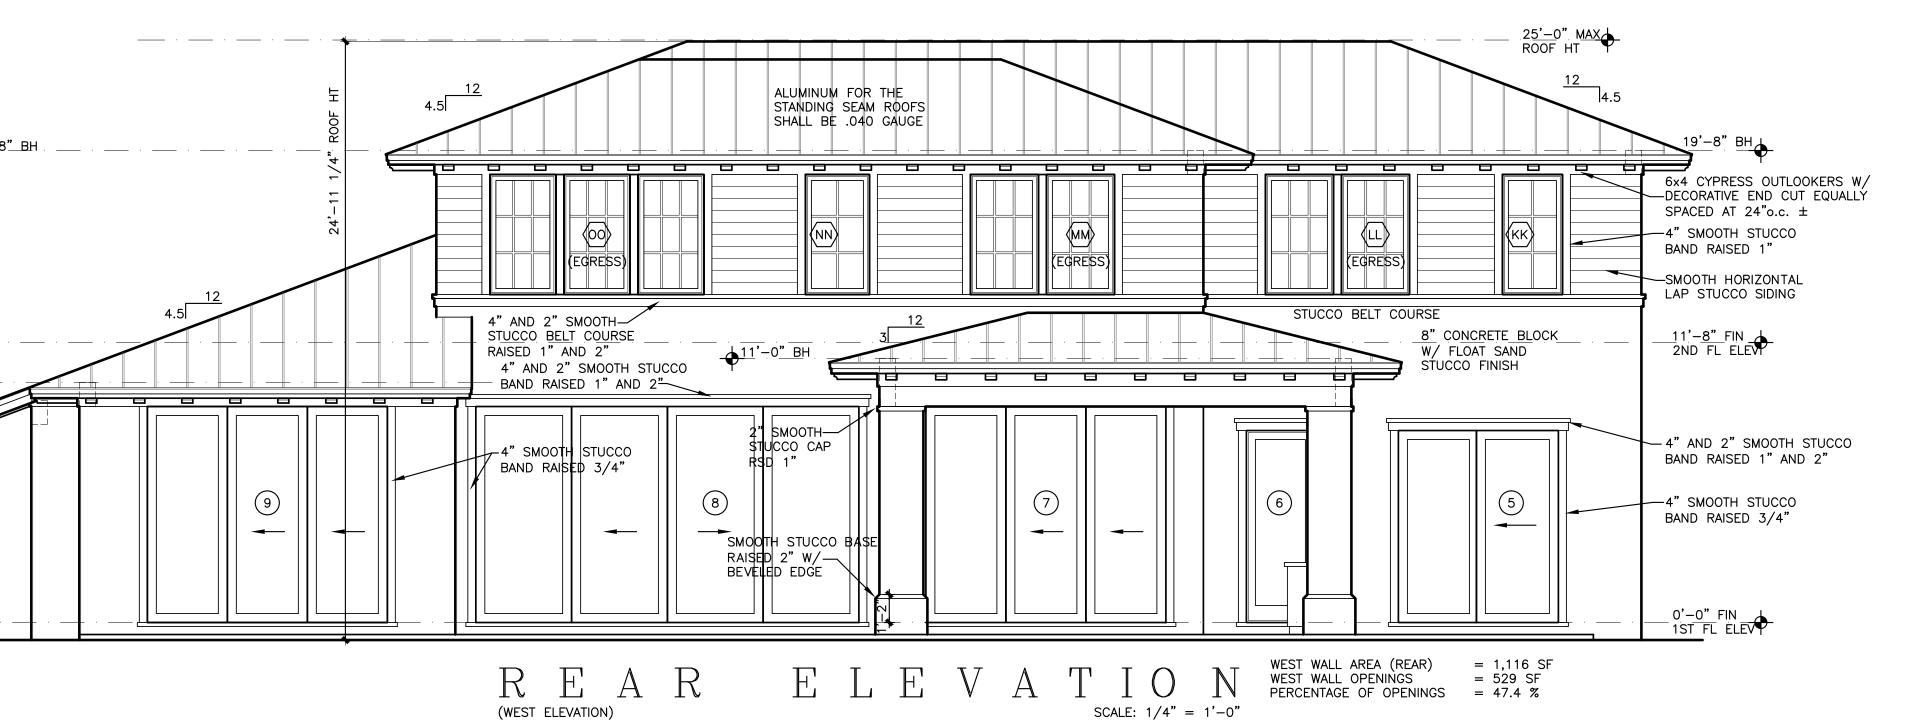





Seal :

Mitchell E. Miller Florida License No. AR91772 As Principal of Village Architects AIA, Inc.

Copyright O 2024 Village Architects AIA All rights reserved. These drawings are the Property of the architect and are not to be used for any other projects except by agreement with The architect in writing.

Consultant:

Revisions : 3-12-24 JIC REVIEW

Sheet Title	:	
FRONT AND		
REAR		
ELEVA	TIONS	
Scale:		
1/4"=1'-0"		
Comm. :	Date :	
23-041	12-7-23	
Drawn :	Checked :	
CRA	MEM	

Sheet No.



+0'−0" FIN 1ST FL ELEV







Seal :

Mitchell E. Miller Florida License No. AR91772 As Principal of Village Architects AIA, Inc.

Copyright (C) 2024 Village Architects AIA All rights reserved. These drawings are the Property of the architect and are not to be used for any other projects except by agreement with The architect in writing.


\_\_\_\_\_ Consultant:

Revisions : 3-12-24 JIC REVIEW

Sheet Title	2:	
LEFT AND		
RIGHT		
ELEVATIONS		
Scale:		
1/4"=1'-0"		
Comm. :	Date :	
23-041	12-7-23	
Drawn :	Checked :	

Sheet No.



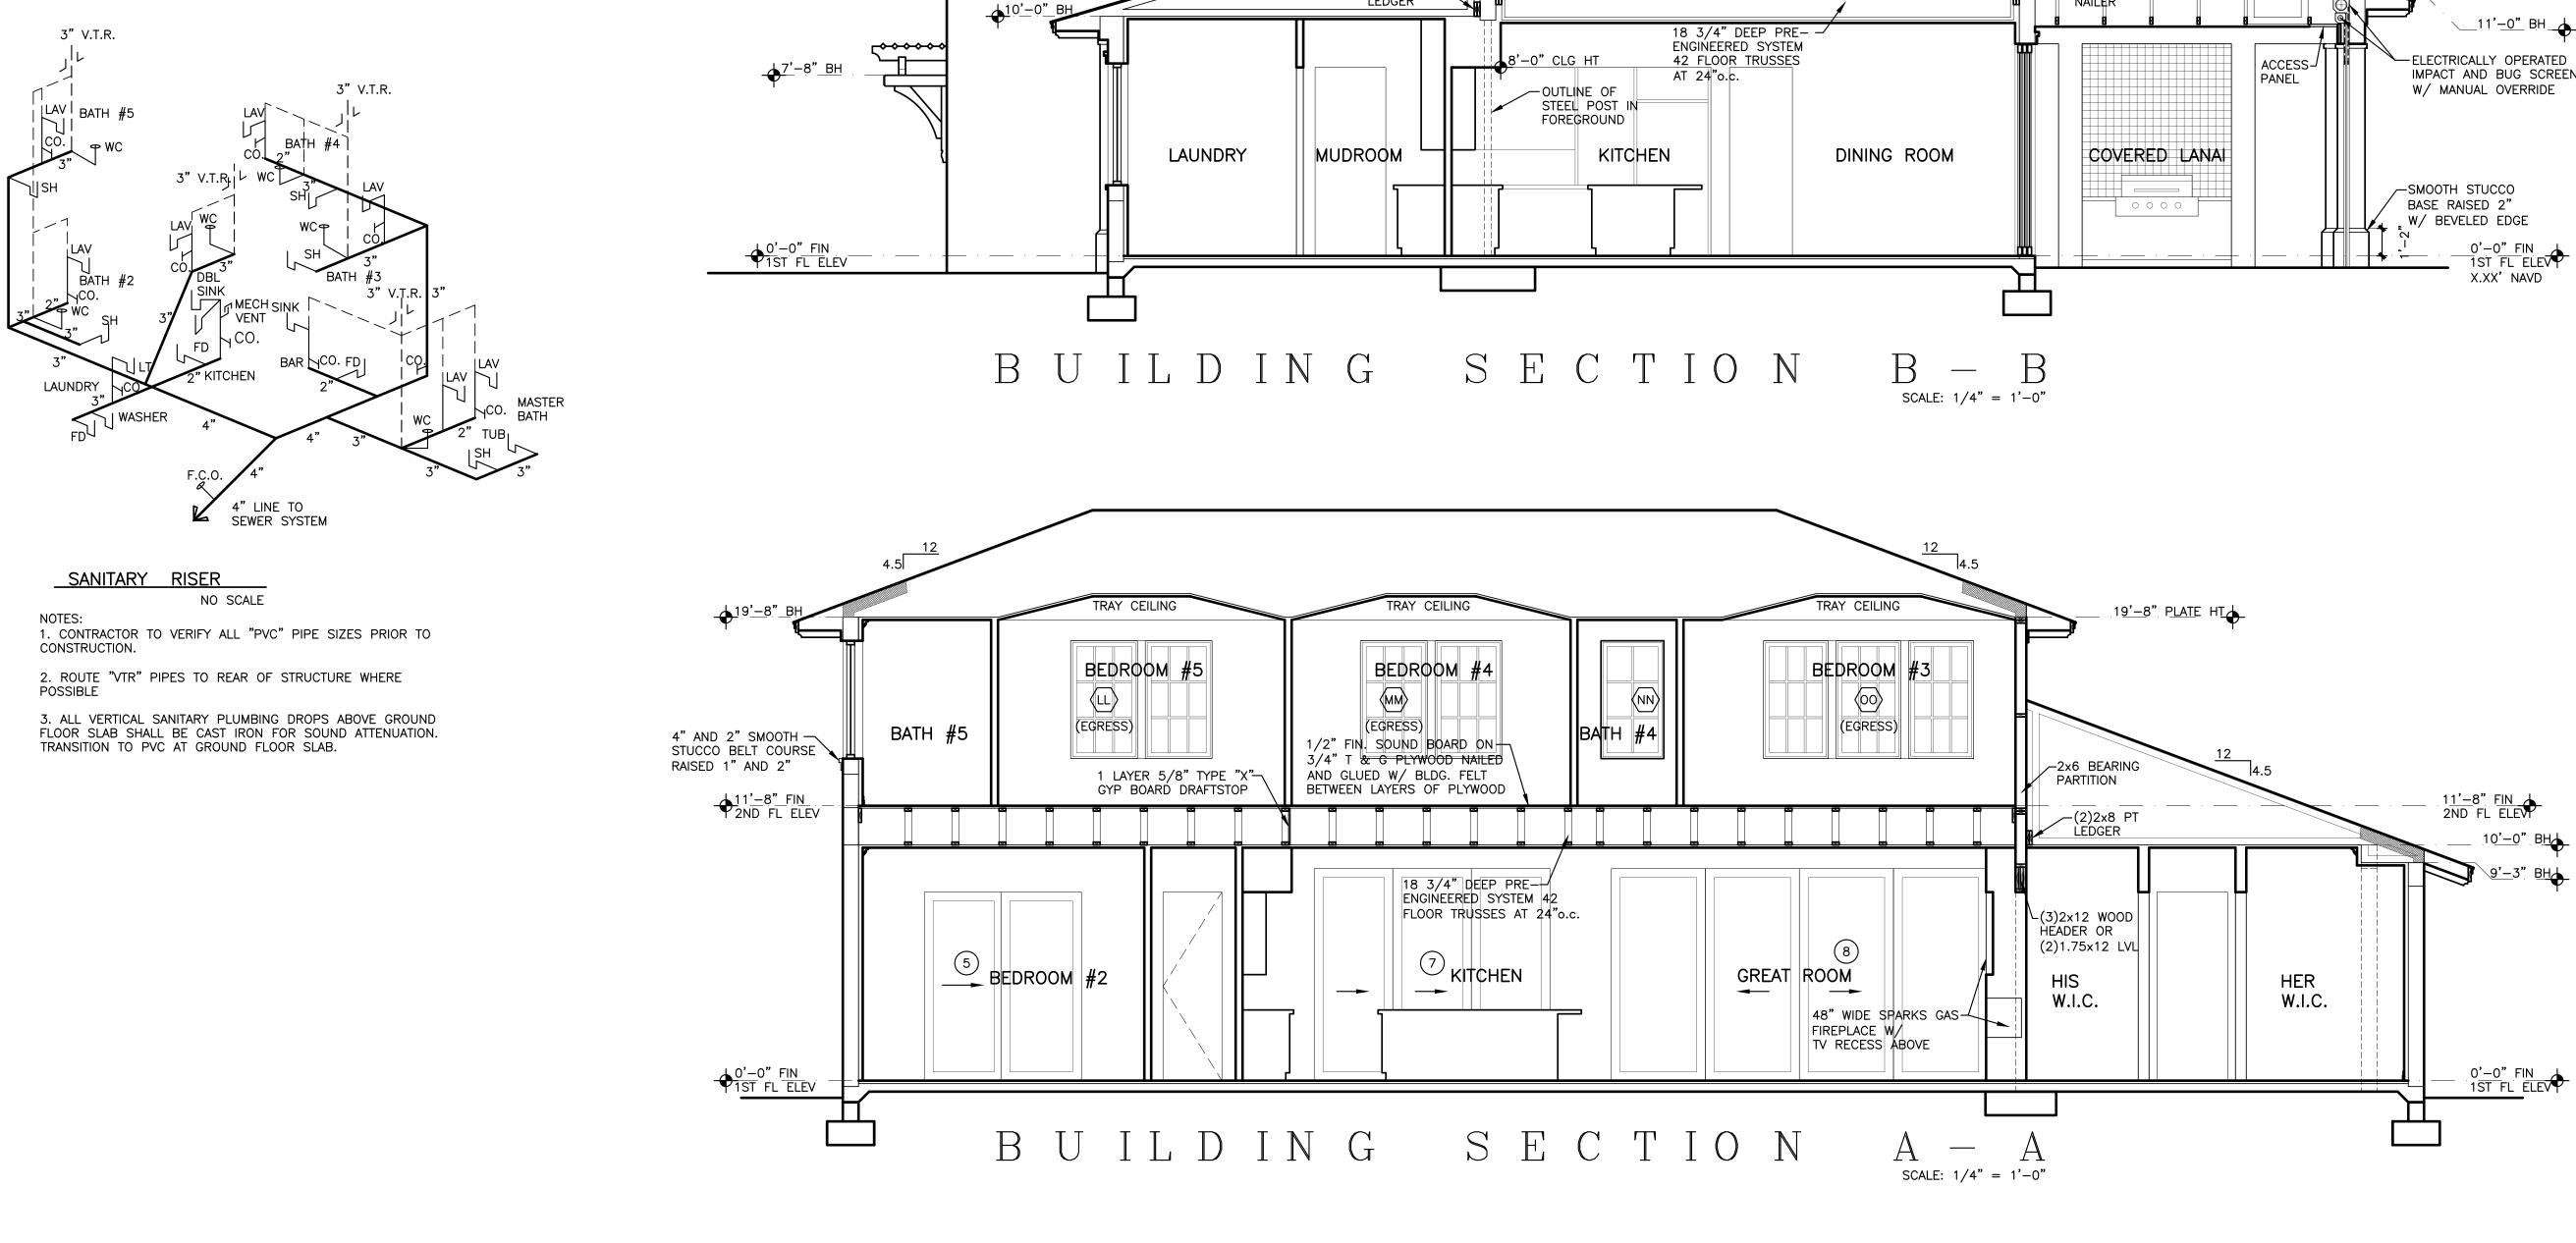

4.5

(2)2x10 PT LEDGER

<u>\_\_\_\_19'\_\_8"\_\_BH</u>

(2)2x8 PT-LEDGER

ALUMINUM FOR THE STANDING SEAM ROOFS SHALL BE .040 GAUGE

8:12 PITCH

TRAY CEILING

1/2" FIN. SOUND BOARD ON 3/4" T & G PLYWOOD NAILED

AND GLUED W/ BLDG. FELT BETWEEN LAYERS OF PLYWOOD

BEDROOM #4

(2)2x10-PT LEDGER



# \_ 19<u>'-8</u>" <u>BH</u> FLAT ROOF SLOPE 1/4" PER FOOT TO EXTERIOR. SEE FLAT ROOF NOTE SHEET A3 \_\_\_\_11'<u>\_\_8"</u> FIN\_\_\_\_\_ 2ND FL ELEV \_\_\_\_11'\_\_0"\_BH\_\_\_ ELECTRICALLY OPERATED

CEAN DRIVE T COLONY, FLORIDA ANIC HOMES RESIDENCE INLF OCE,  $\cup$ NEW -JUPITER

Seal :

Mitchell E. Miller Florida License No. AR91772 As Principal of Village Architects AIA, Inc.

Copyright 🔘 2024 Village Architects AIA All rights reserved. These drawings are the Property of the architect and are not to be used for any other projects except by agreement with The architect in writing.

Consultant:


Revisions : 3-12-24 JIC REVIEW

Sheet Title: BUILDING SECTIONS


Scale: 1/4"=1'-0"	
Comm. :	Date :
23-041	12-7-23
Drawn :	Checked :
CRA	MEM


Sheet No.



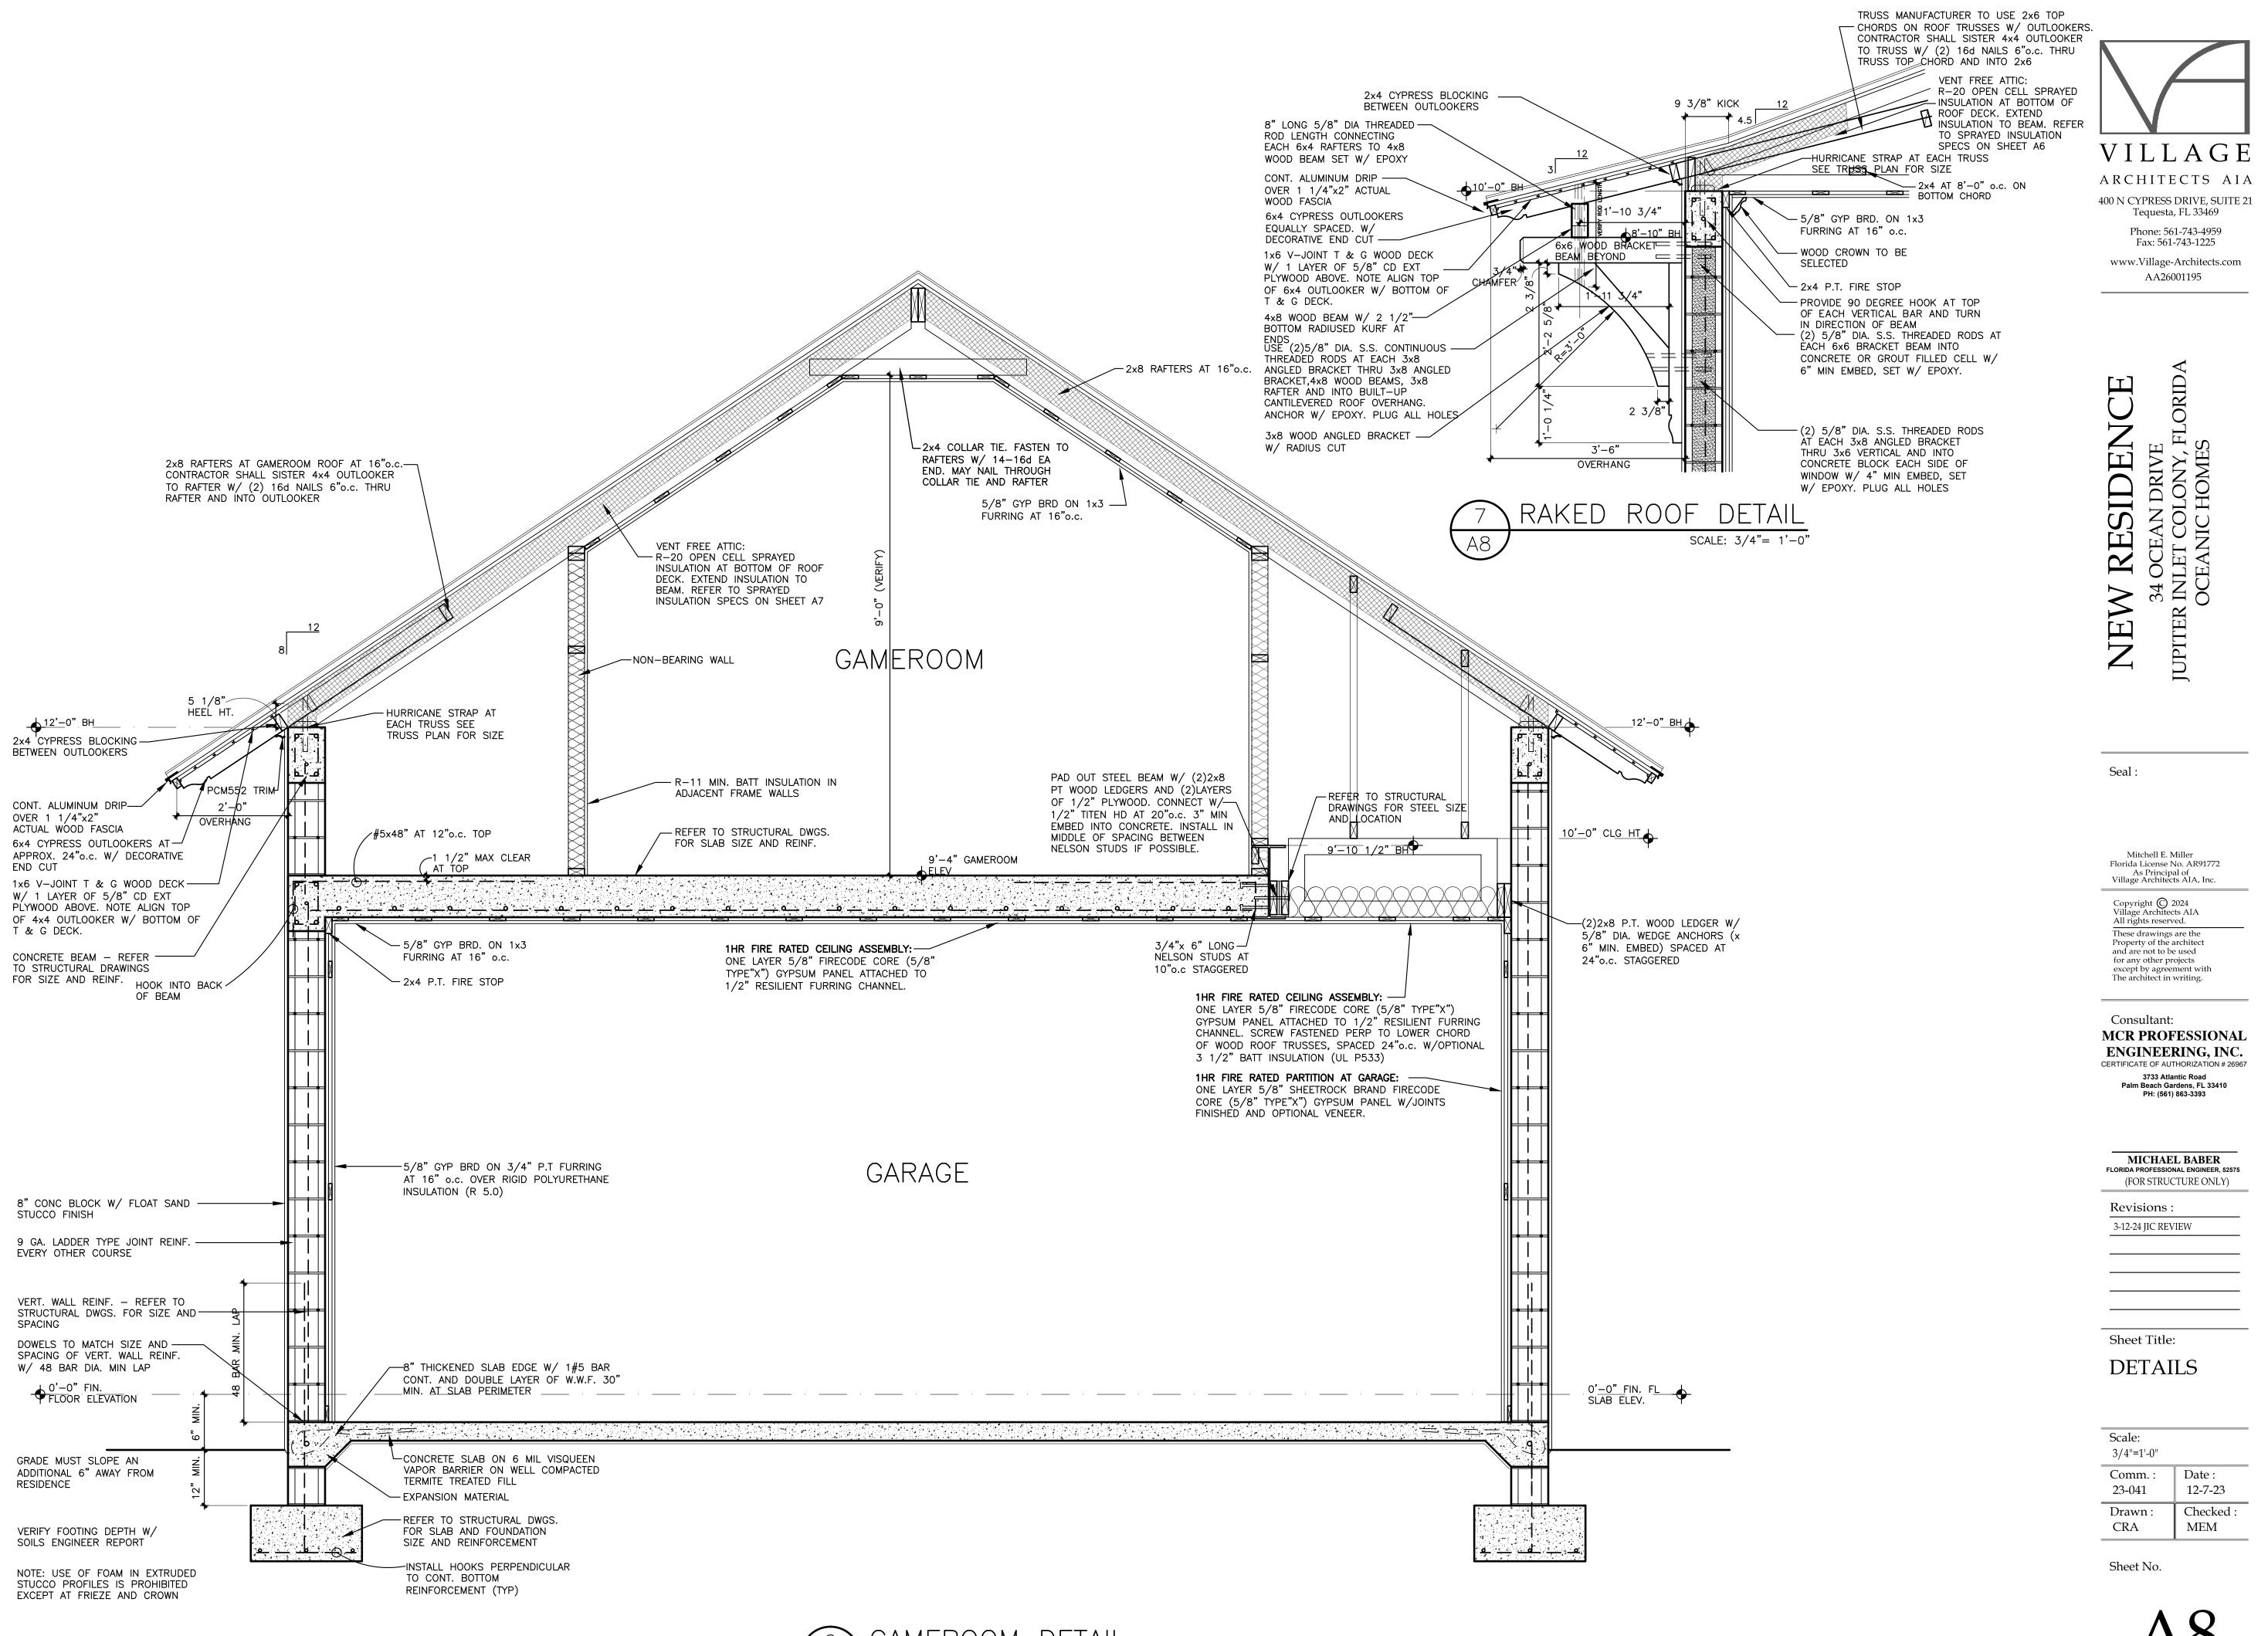





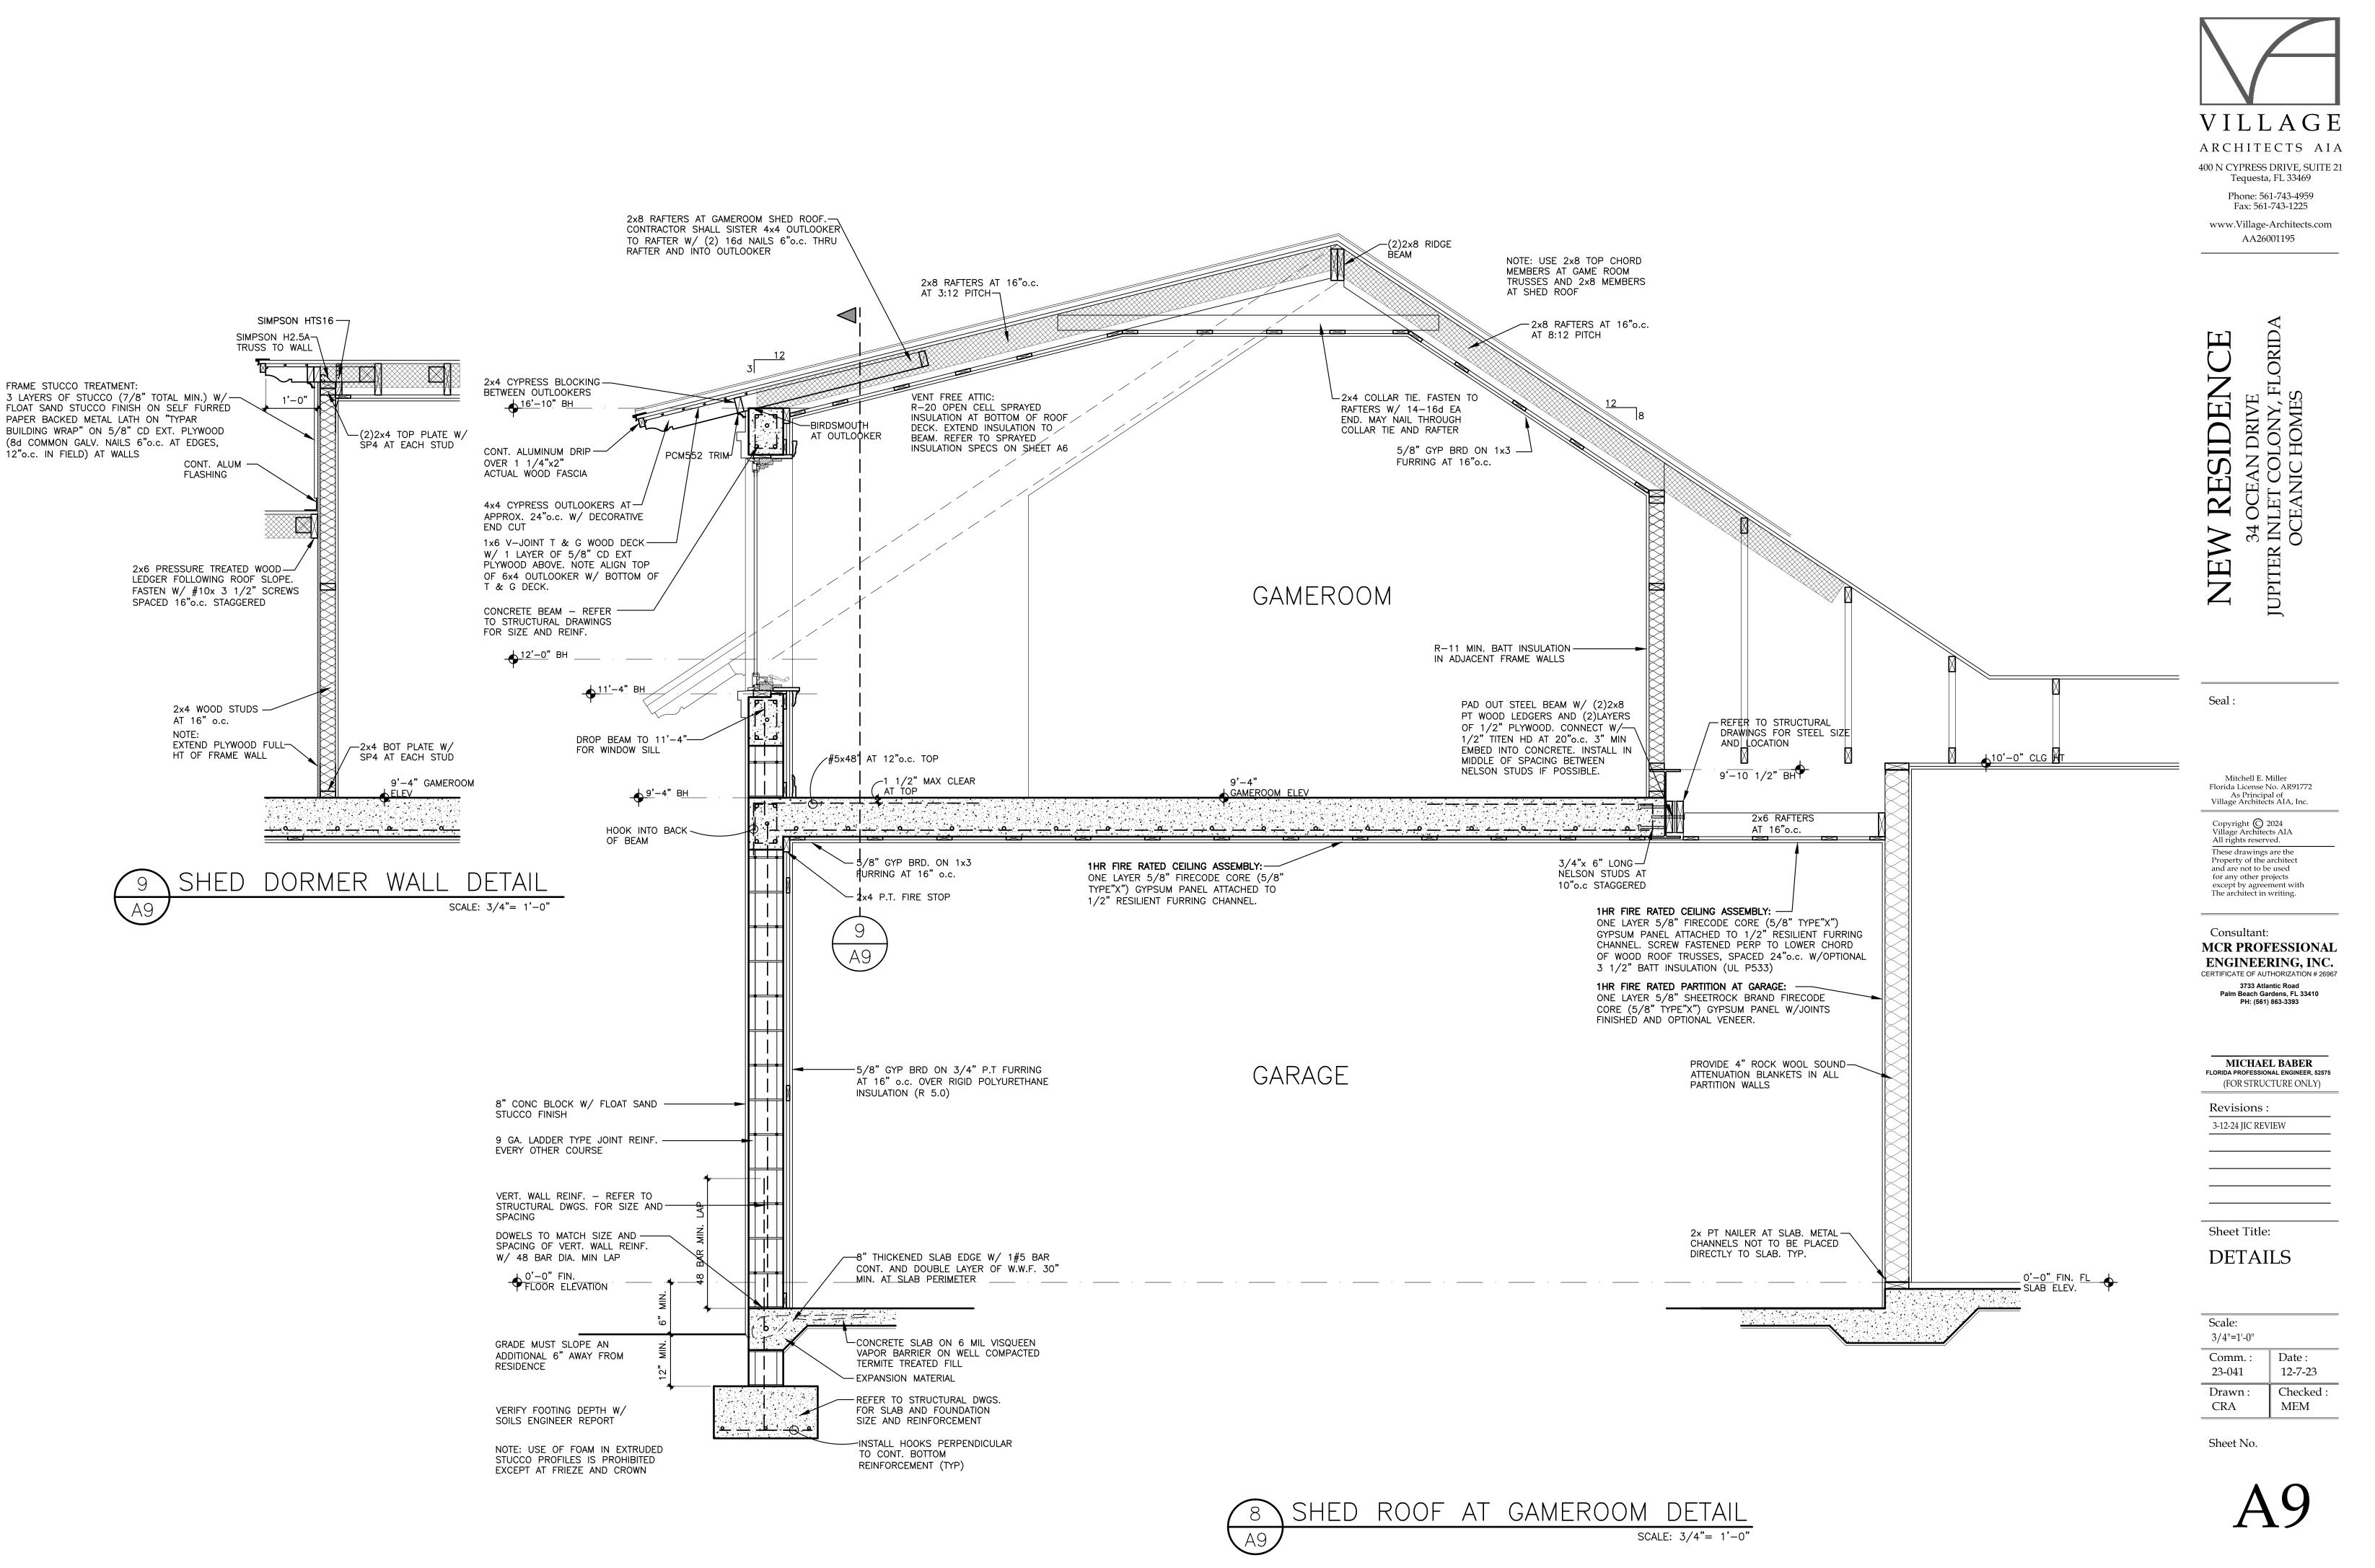


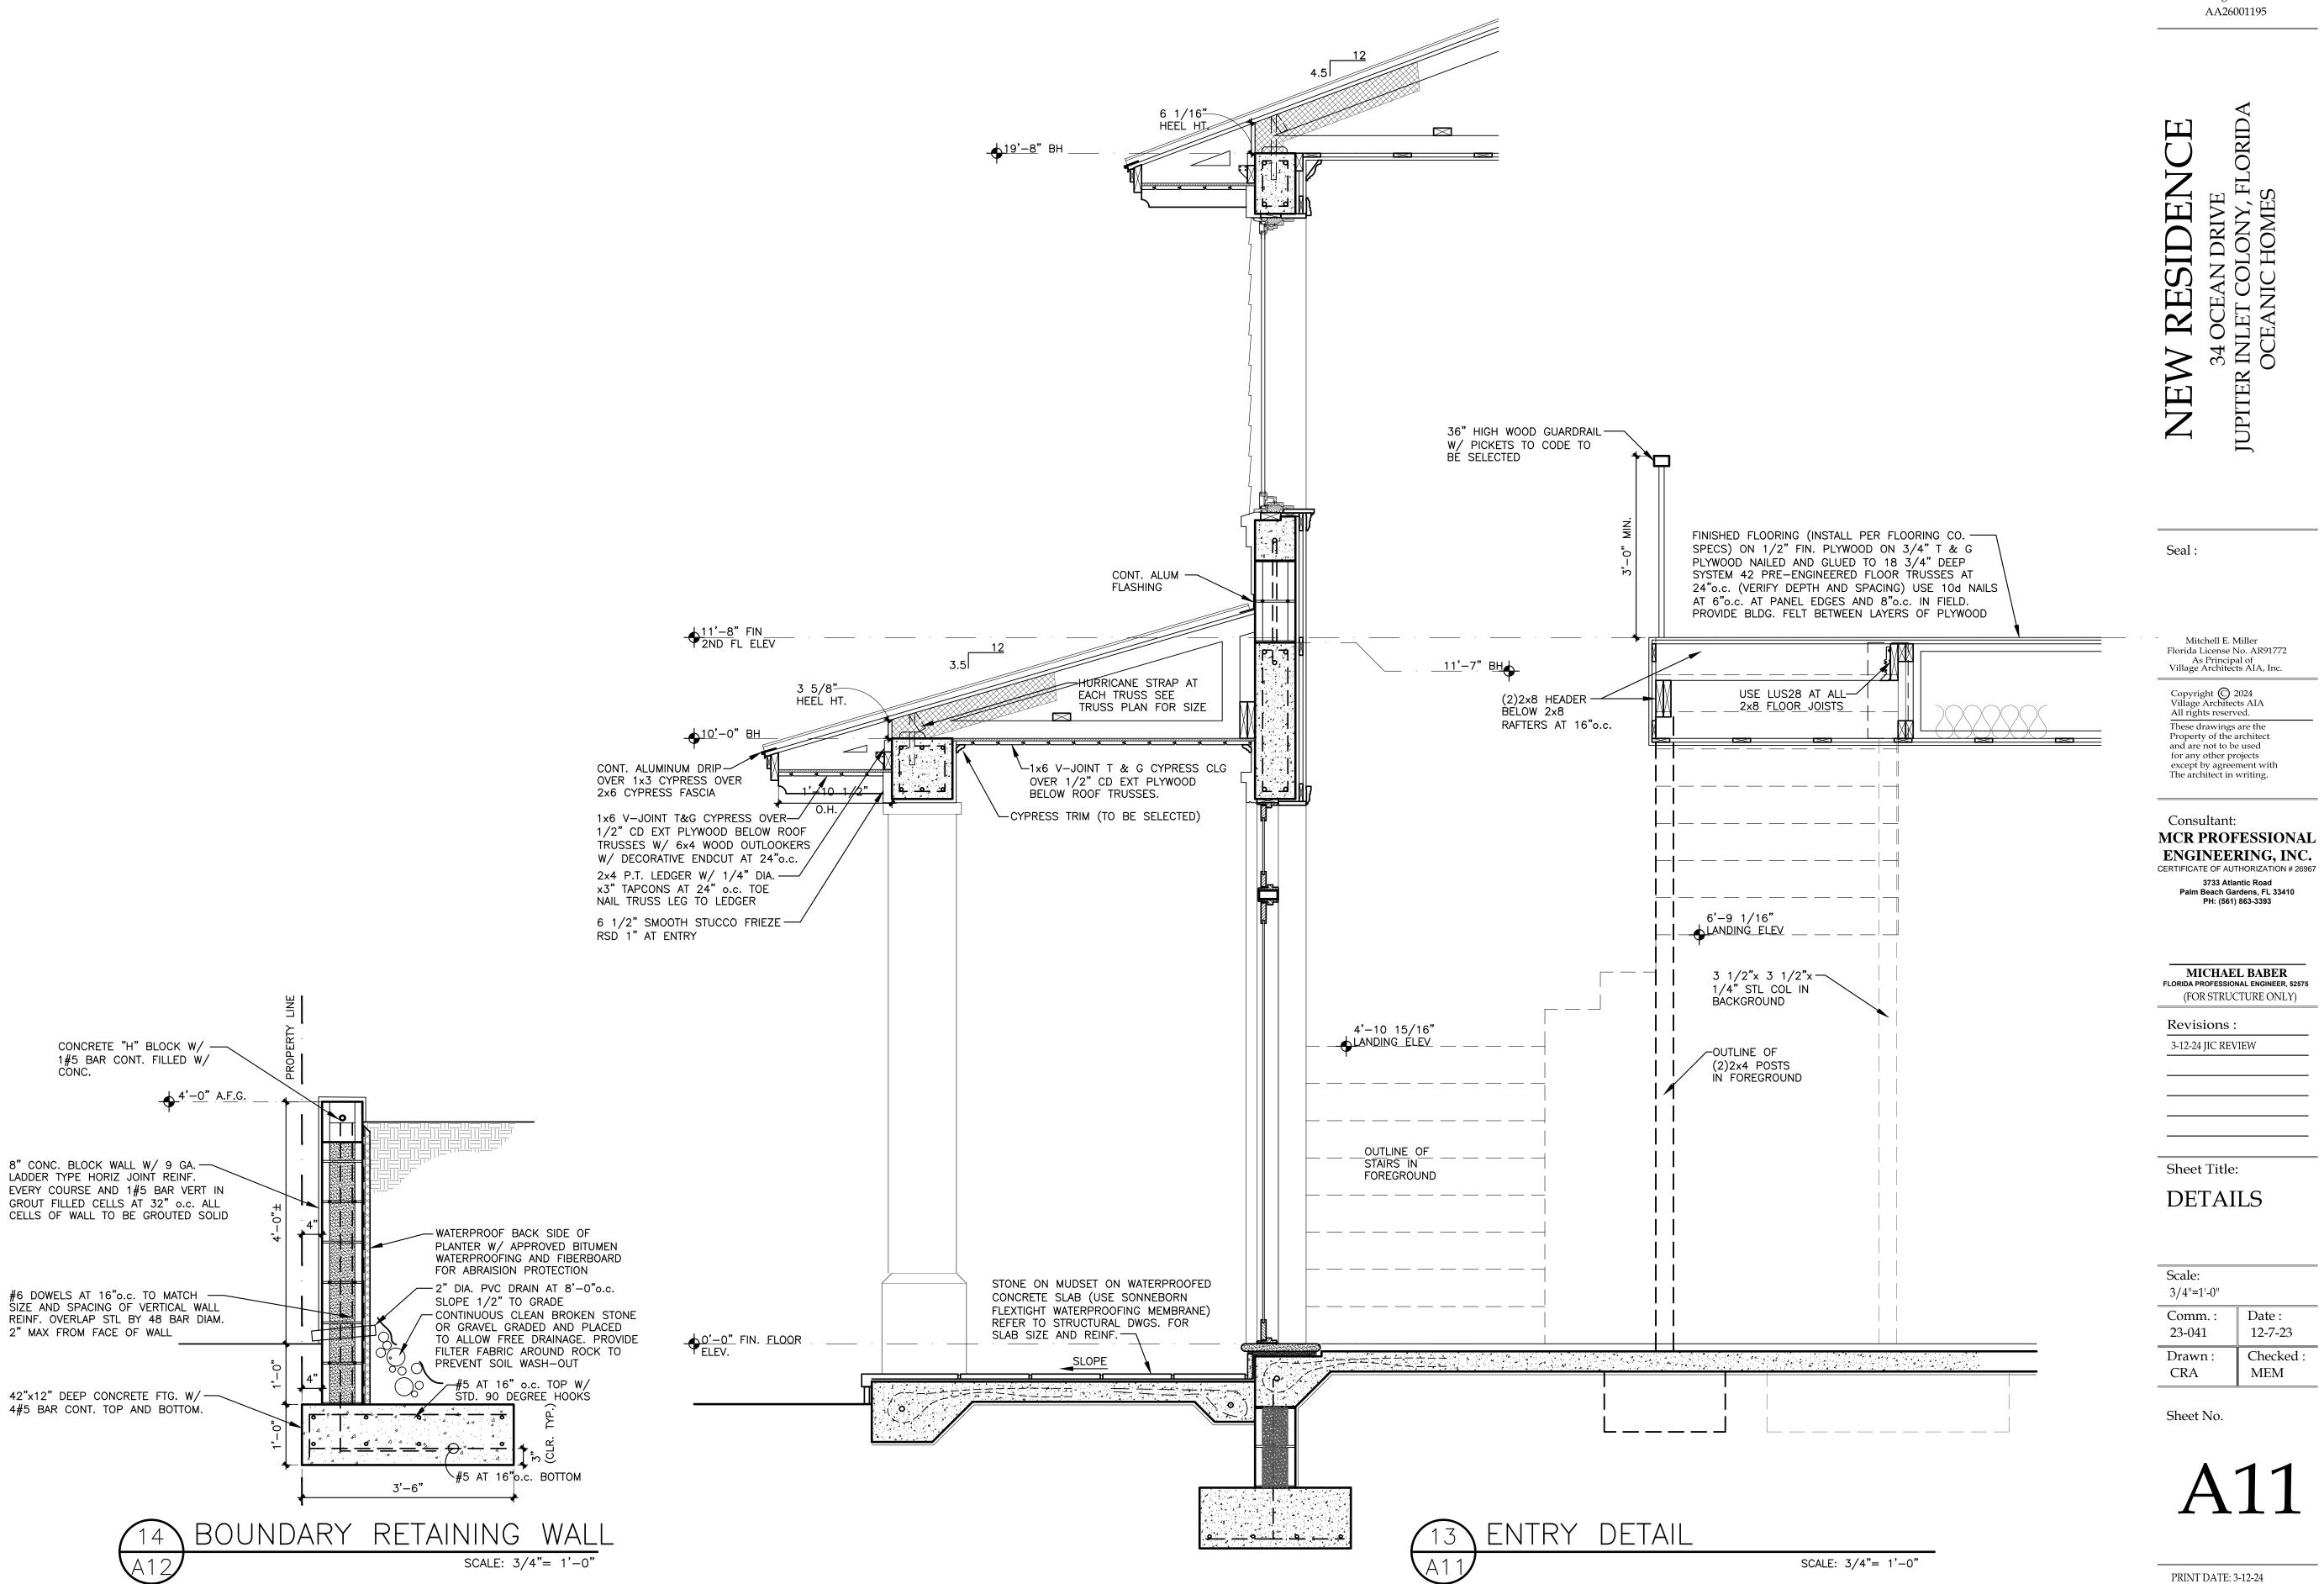



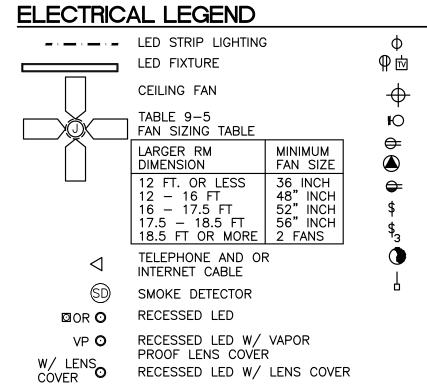

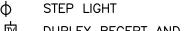

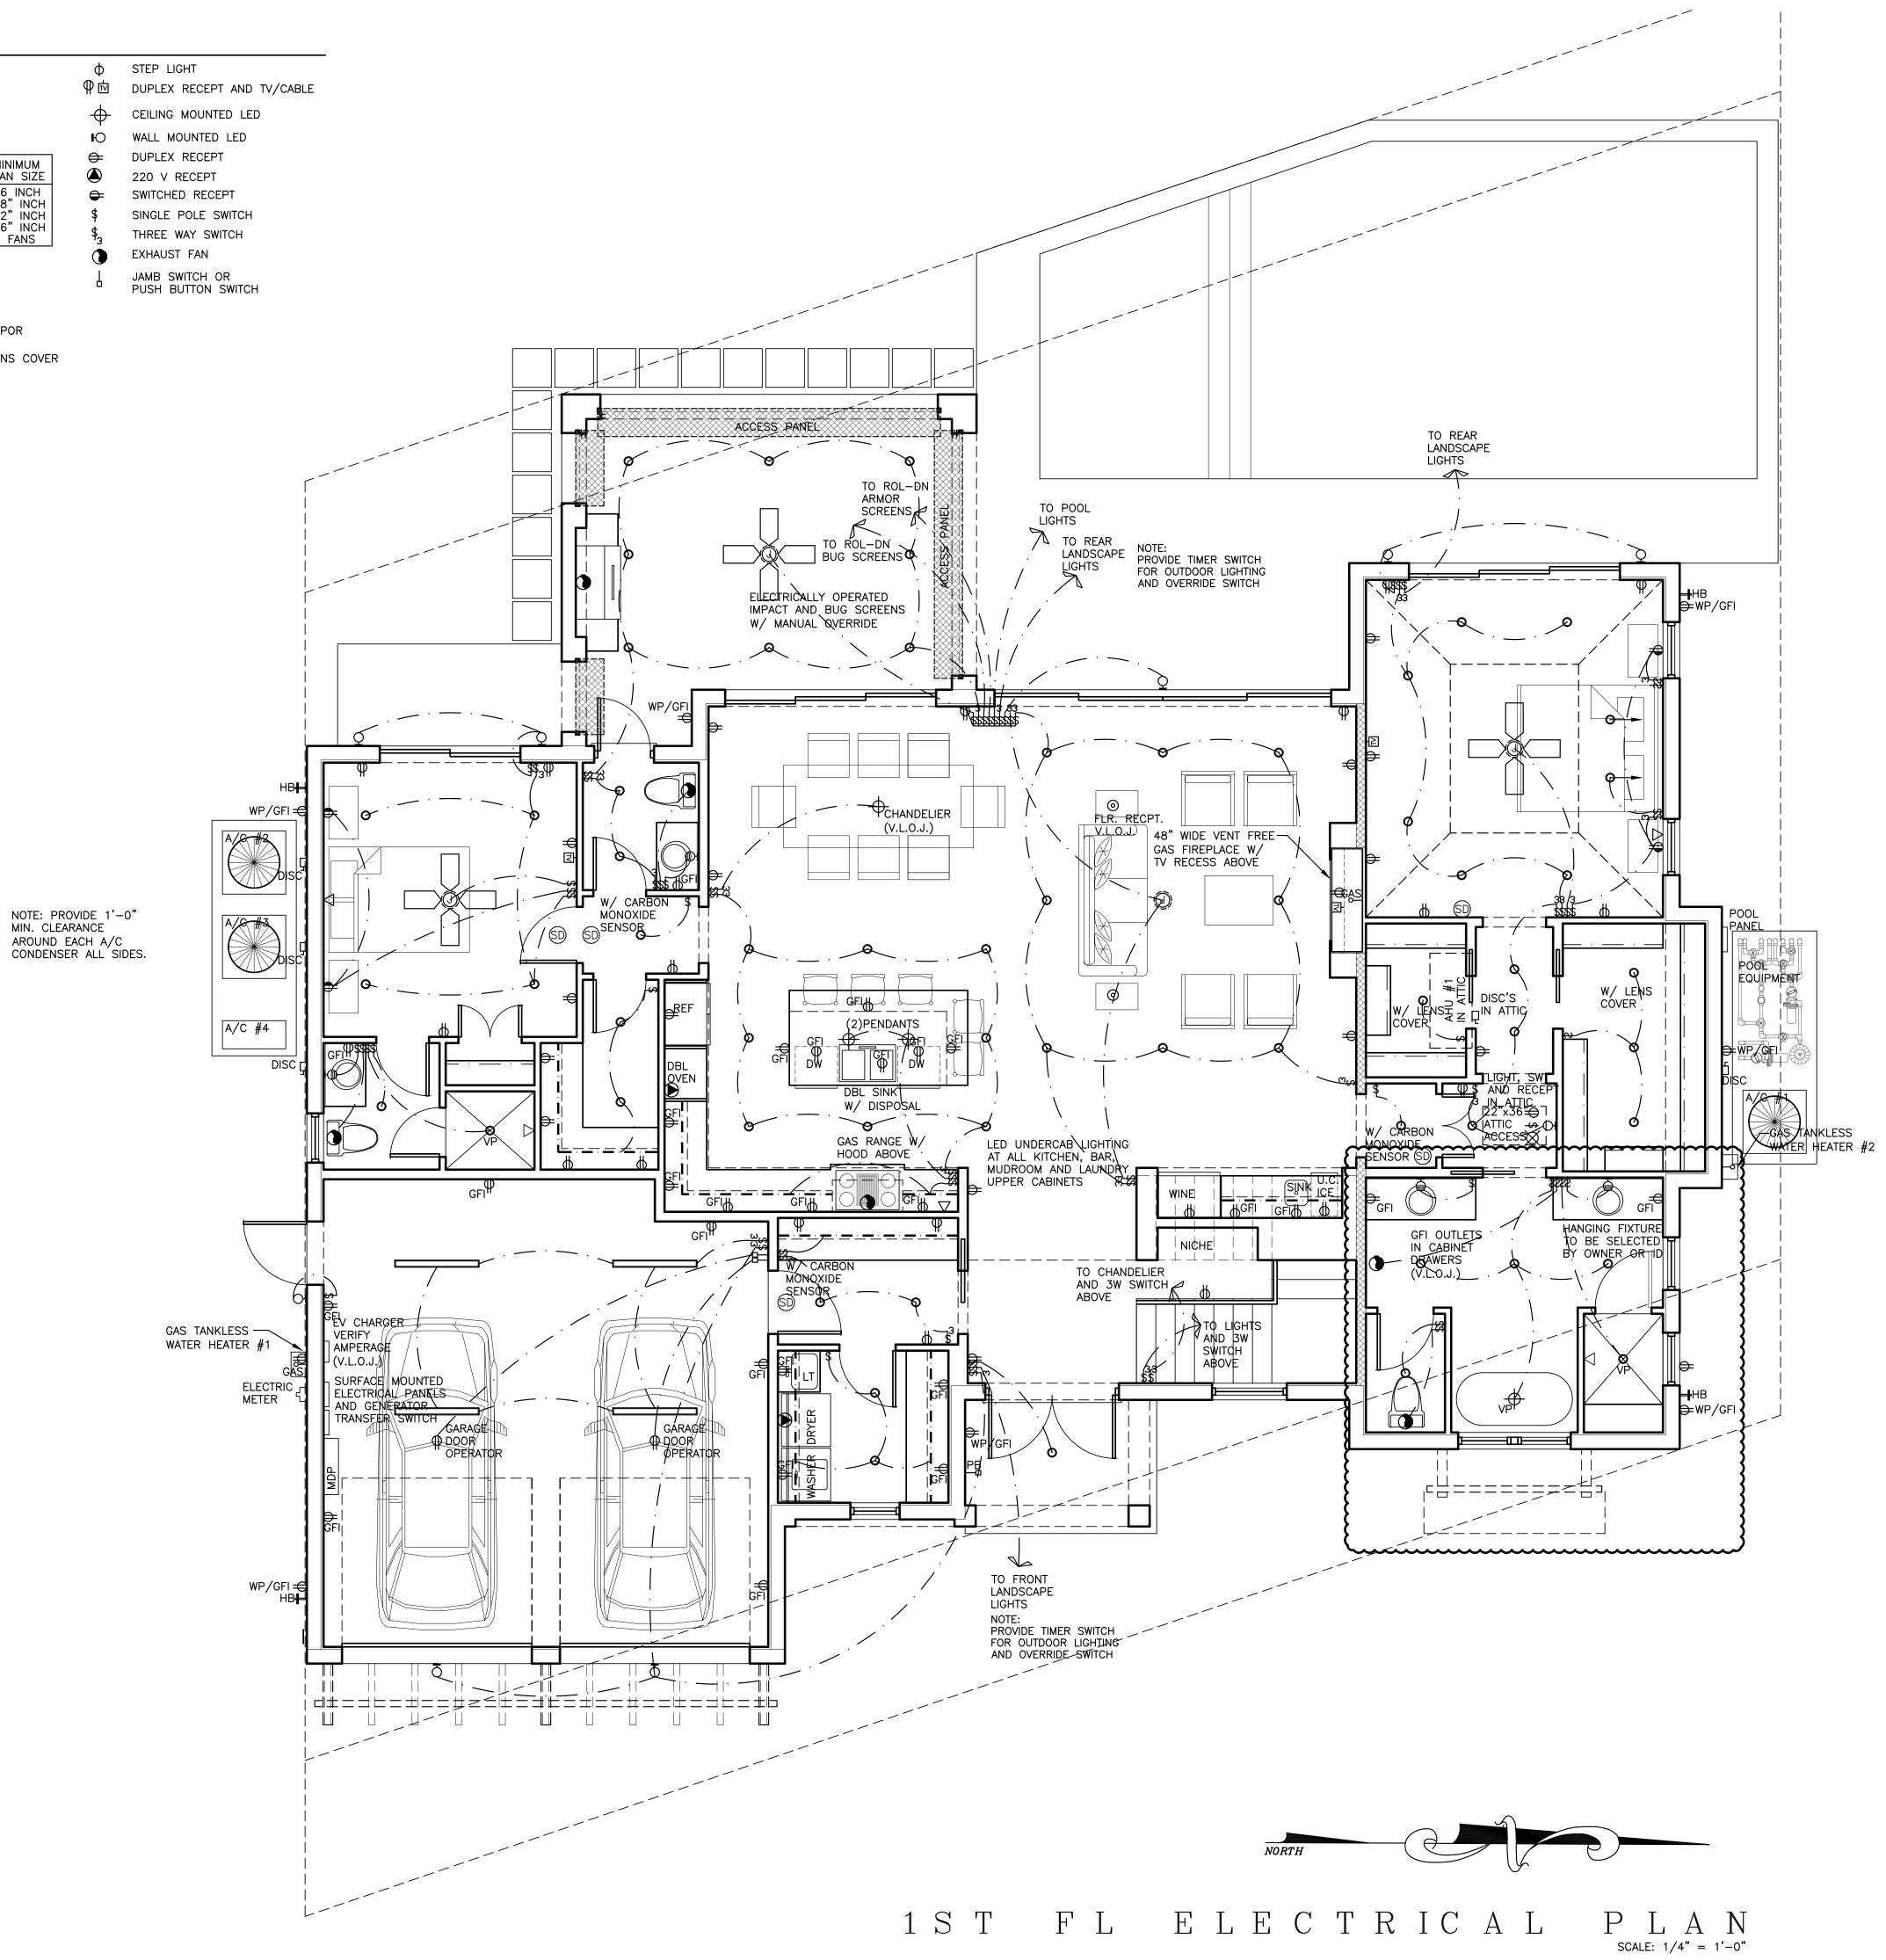



ORID.  $\bigcirc$ N DRIVE DLONY, FL HOMES RESIDEN  $\triangleleft$ INLF DCE,  $\cup$ VEW 4 JUPITER 

Seal :

Mitchell E. Miller Florida License No. AR91772 As Principal of Village Architects AIA, Inc.

Copyright () 2024 Village Architects AIA All rights reserved. These drawings are the Property of the architect and are not to be used for any other projects except by agreement with The architect in writing.

Consultant:


Revisions : 3-12-24 JIC REVIEW

Sheet Title: FIRST FLOOR ELECTRIC PLAN Scale: 1/4"=1'-0" Comm. : Date : 12-7-23 23-041 Drawn : Checked :

MEM CRA \_\_\_\_\_ Sheet No.



NO PENETRATIONS OR NOTCHES SHALL BE MADE IN ANY STRUCTURAL MEMBER INCLUDING CONCRETE BEAMS AND COLUMNS, MASONRY BLOCK AND STEEL BEAMS WITHOUT WRITTEN APPROVAL BY THE ENGINEER OF RECORD.

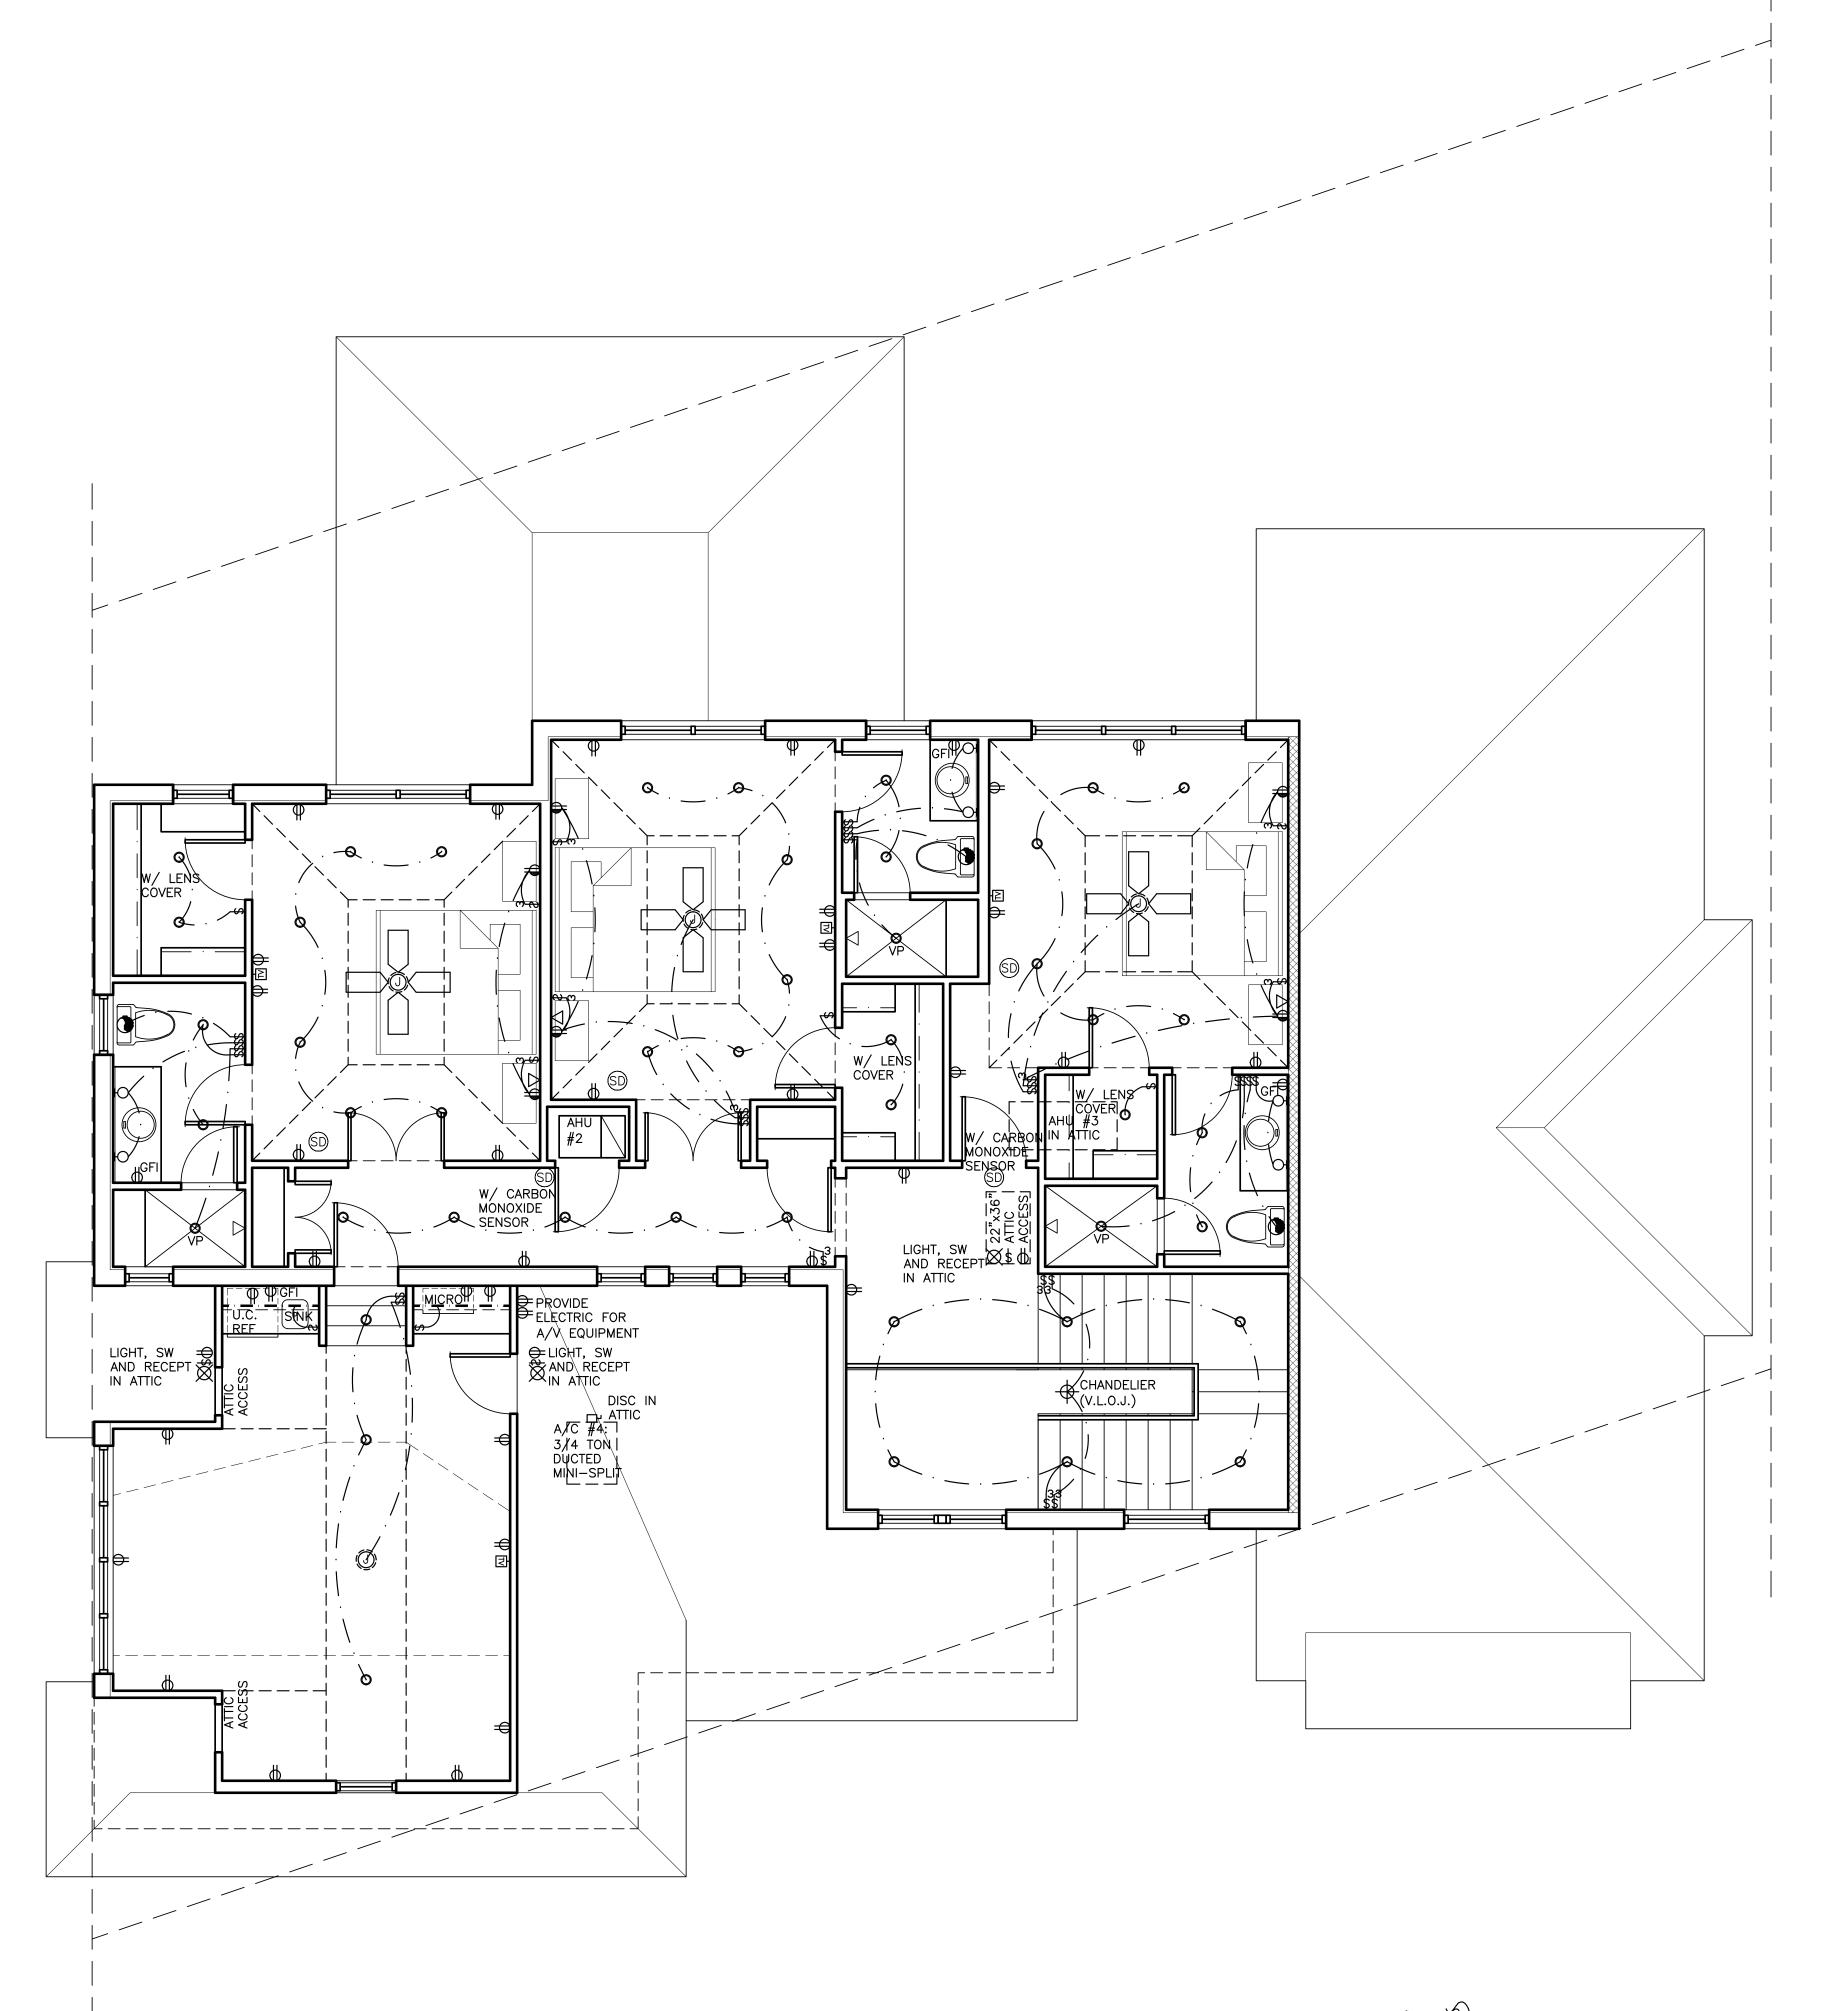

NORTH 2 N D F L O O R E L E C T R I C A L  $P_{\text{SCALE: } 1/4" = 1'-0"}$ 



# $[\mathbf{T}]$ ORID **DEN** NEW JUPITER

Seal :

Mitchell E. Miller Florida License No. AR91772 As Principal of Village Architects AIA, Inc.

Copyright 🔘 2024 Village Architects AIA All rights reserved. These drawings are the Property of the architect and are not to be used for any other projects except by agreement with The architect in writing.

Consultant:

Revisions : 3-12-24 JIC REVIEW

Sheet Title:


## SECOND FLOOR ELECTRIC PLAN

Scale: 1/4"=1'-0"	
Comm. :	Date :
23-041	12-7-23
Drawn :	Checked :
CRA	MEM

Sheet No.



NO PENETRATIONS OR NOTCHES SHALL BE MADE IN ANY STRUCTURAL MEMBER INCLUDING CONCRETE BEAMS AND COLUMNS, MASONRY BLOCK AND STEEL BEAMS WITHOUT WRITTEN APPROVAL BY THE ENGINEER OF RECORD.

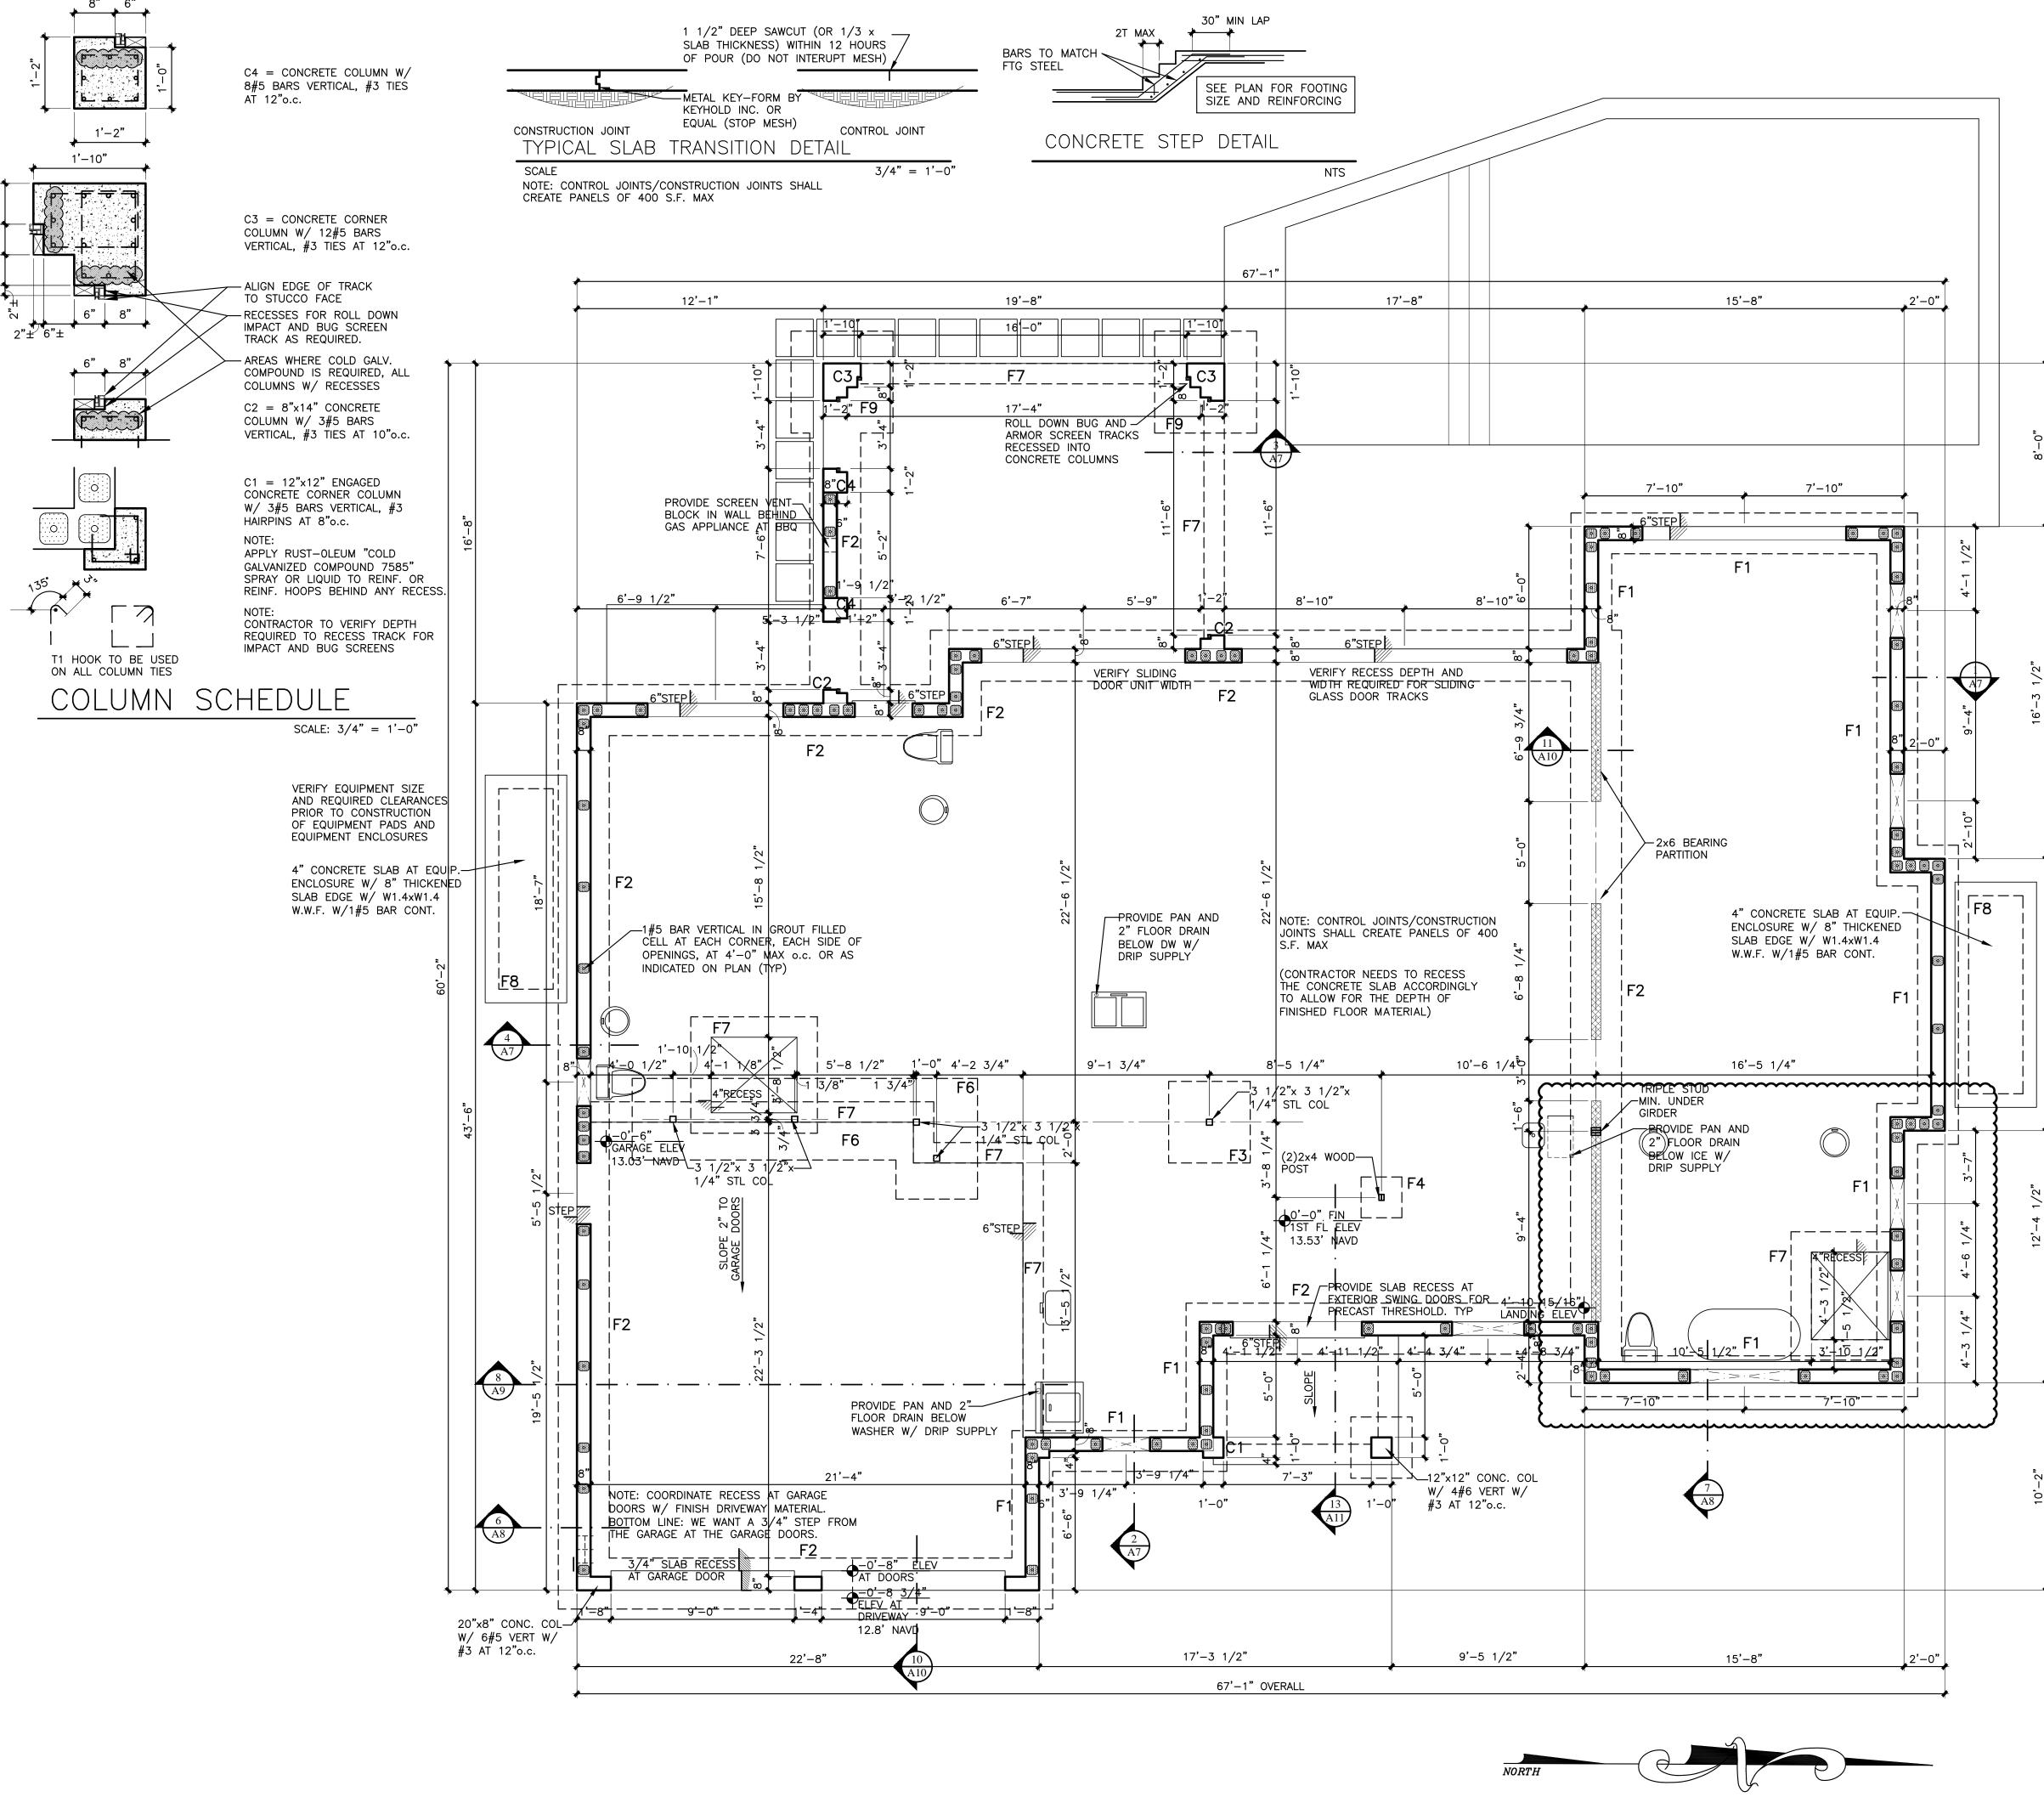

FOUNDATION



## Ш RID C DEN Ц HOME SII RE $\cup$ -+ $\simeq$ UPITE] Ш $\frown$

## FOUNDATION NOTES:

- | CONTRACTOR TO VERIFY SOIL CAPACITY PER GEOTECHNICAL ENGINEERS SPECS. FOUNDATIONS DESIGNED FOR AN ALLOWABLE SAFE BEARING CAPACITY OF 2500 PSF. U.N.O.
- . 🛄 SIZE VARIES POURED CONC COL W/ VERTICAL BARS AS NOTED AND # 3 TIES AS NOTED . 🗐 CONCRETE BLOCK W/ 1#5 BAR VERTICAL IN GROUT FILLED CELL AT EACH CORNER, EACH SIDE OF OPENINGS,
- AT 4'-0" MAX o.c. OR AS INDICATED ON PLAN 4. (2) # 5 5'-6" IN LENGTH IN CENTER OF 4"
- CONCRETE SLAB AT ALL INTERIOR CORNERS. TYPICAL 5. T-46 CONC INSPECTION BLOCK W/ INSERTS AT BASE OF GROUT FILLED COL. OPTIONAL. T-46 BLOCK
- DESIGNED FOR CLEAN INSPECTIONS OF FILLED CELLS ELIMINATING HAMMERING, CHIPPING OR SAWING. 6. CONCRETE COLUMN TIE REINFORCEMENT SHALL COMPLY WITH SECTION 7.10.5 OF ACI 318 "BUILDING CODE
- REQUIREMENTS FOR STRUCTURAL CONCRETE 7. FIRST FLOOR LOAD BEARING WOOD STUD WALLS SHALL CONSIST OF 2x4 OR 2x6 STUDS SPACED AT 16" o.c. W/ DOUBLE TOP PLATE AND SINGLE PRESSURE TREATED BOTTOM PLATE. PROVIDE 5/8" DIA WEDGE ANCHORS (W/ WASHERS) AT 32"o.c. (MAX) AT BOTTOM PLATE (x5 1/2" Consultant: MIN EMBED) PROVIDE "SIMPSON" SP4 OR SP6 STUD PLATE TIES AT TOP AND BOTTOM OF EACH WALL STUD

THE CONTRACTOR NEEDS TO COORDINATE THE DIFFERENT RECESSES IN THE CONCRETE SLAB NEEDED FOR VARIOUS FLOOR MATERIALS TO PROVIDE A LEVEL FINISHED FLOOR.

CONTRACTOR SHALL COORDINATE ALL MASONRY OPENINGS PRIOR TO CONSTRUCTION

NOTE: CONTRACTOR SHALL VERIFY EQUIPMENT, EQUIPMENT SIZE AND CLEARANCES REQUIRED PRIOR TO CONSTRUCTING EQUIPMENT WALL ENCLOSURES

FOOTING LEGEND: F1=24" WIDE x12" DEEP CONC. STEMWALL FTG. W/ 3#5 BARS CONT. AND #5 TRANSVERSE AT 12" o.c.

F2=30" WIDE x12" DEEP CONC. MONO FTG. W/ 4#5 BARS CONT. AND #5 TRANSVERSE AT 12" o.c.

F3=48"x48"x12" DEEP CONC. PAD FTG W/ 6#5 BARS BOTTOM EACH WAY

F4=24"x24"x12" DEEP CONC. PAD FTG W/ 3#5 BARS BOTTOM EACH WAY

 $F5=36^{\circ}x36^{\circ}x12^{\circ}$  DEEP CONC. PAD FTG W/ 4#5 BARS BOTTOM EACH WAY

F6=48" WIDE x12" DEEP CONC. MONO FTG. W/ 5#5 BARS CONT. AND #5 TRANSVERSE AT 12" o.c.

F7=12" THICKENED SLAB EDGE W/ 1#5 BAR CONT.

F8=8" THICKENED SLAB EDGE W/ 1#5 BAR CONT.

F9=60"x60"x12" DEEP CONC. PAD FTG W/ 5#5 BARS BOTTOM EACH WAY

### SLAB NOTE:

4" 5000 PSI CONCRETE SLAB W/ TOPICAL CURING COMPOUND W/ 6x6-W1.4xW1.4 WWF ON 6 MILL POLY VAPOR BARRIER ON WELL COMPACTED TERMITE TREATED GRANULAR FILL. 8" THICKENED SLAB EDGE W/ DOUBLE LAYER OF 6x6-W1.4xW1.4 WWF AROUND PERIMETER. EXTEND WWF 30" MIN. INTO SLAB.

## FRAME WALL CONNECTION:

ATTACH INTERIOR WOOD BEARING PARTITION WALLS AND NON BEARING PARTITION WALLS TO CONCRETE BLOCK WALL THRU 2x4 P.T. OR 2x6 P.T. END STUD W/ 3/16" DIA. TAPCONS AT 16"o.c. (x2" MIN EMBEDMENT) INTO GROUT FILLED CELL OR CONCRETE COLUMN.

> NO PENETRATIONS OR NOTCHES SHALL BE MADE IN ANY STRUCTURAL MEMBER INCLUDING CONCRETE BEAMS AND COLUMNS, MASONRY BLOCK AND STEEL BEAMS WITHOUT WRITTEN APPROVAL BY THE ENGINEER OF RECORD.

#### Mitchell E. Miller Florida License No. AR91772 As Principal of Village Architects AIA, Inc.

Copyright 🔘 2024 Village Architects AIA All rights reserved. These drawings are the Property of the architect and are not to be used for any other projects except by agreement with The architect in writing.

#### MCR PROFESSIONAL **ENGINEERING, INC.** CERTIFICATE OF AUTHORIZATION # 26967 3733 Atlantic Road Palm Beach Gardens, FL 33410 PH: (561) 863-3393

#### MICHAEL BABER FLORIDA PROFESSIONAL ENGINEER, 52575

Revisions : 3-12-24 JIC REVIEW

# Sheet Title:

FOUNDATION PLAN

Scale: 1/4"=1'-0"	
Comm. :	Date :
23-041	12-7-23
Drawn :	Checked :
CRA	MEM

Sheet No.








# PLYWOOD SHEATHING NAILING SCHEDULE

		,		
			COMPONENTS	AND CLADDING
ZONE	NAIL SIZE	NAIL SPACING	+PSF	-PSF
ZONE 1	10d RING SHANK	4" O.C. AT EDGES, 6" O.C. INTERMEDIATE	37.73	67.75
ZONE 2	10d RING SHANK	4" O.C. AT EDGES, 4" O.C. INTERMEDIATE	37.73	93.48
ZONE 3	10d RING SHANK	4" O.C. AT EDGES, 4" O.C. INTERMEDIATE	37.73	93.48
ZONE 4	10d RING SHANK	6" O.C. AT EDGES, 12" O.C. INTERMEDIATE	50.60	54.89
ZONE 5	10d RING SHANK	4" O.C. AT EDGES, 8" O.C. INTERMEDIATE	50.60	67.75
NOTES:	•			

1) GLUE DOWN SHEATHING TO TRUSSES 4'-0" IN FROM ROOF PERIMETER.

2) GLUE AND NAIL 3/4" CD EXTERIOR FLAT DECK SHEATHING WITH 10d RING SHANK NAILS AS NOTED ABOVE WITH 30# BASE SHEET TIN TAGGED TO PLYWOOD SHEATHING.

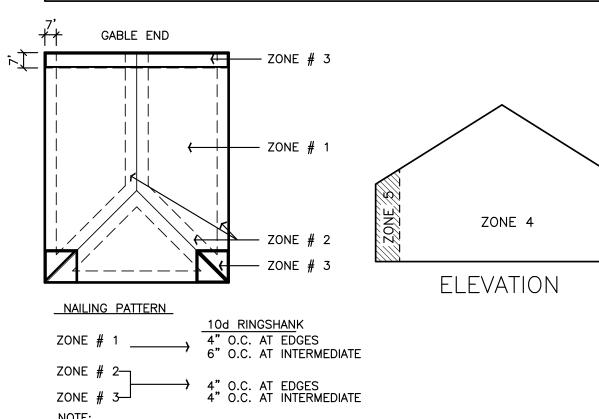

GLUE DN SHEATHING TO TRUSSES 4'-0" IN FROM ROOF PERIMETER

ENHANCED NAILING AT FLAT ROOF DECKS: GLUE AND NAIL 3/4" CD EXT FLAT DECK SHEATHING

WITH 10d RING SHANK NAILS AT 4"o.c. W/ 30# BASE

SHEET	ΤO	ΒE	TIN	TAGGED	AΤ	4"o.c.	


CC	CONCRETE BEAM SCHEDULE (fc=5,000 PSI, U.N.O.)						
BEAM	TOP OF	0.75	REINF	ORCING	STIRRUPS		
No.	BEAM ELEV.	SIZE	BOTTOM	TOP CONT.		REMARKS	
RB1	VARIES	8"x12"	2 #5	2 <b>#</b> 5		RAKED BEAM AT 3.5:12 PITCH	
RB2	VARIES	8"x12"	2 <b>#</b> 5	2 <b>#</b> 5		RAKED BEAM AT 4.5:12 PITCH	
B01	10'-0"	8"x12"	2 #5	2 <b>#</b> 5			
B02	10'-0"	8"x24"	2 <b>#</b> 5	2 <b>#</b> 5	#3 AT 12"o.c.	2#5 BARS MID	
B03	10'-0"	8"x12"	2 #5	2 <b>#</b> 5			
B04	10'-0"	12"x12"	3 #5	3 <b>#</b> 5			
B05	10'-0"					SEE DETAIL	
B06	9'–3"	8"x12"	2 #5	2 <b>#</b> 5			
B07	11'-0"	8"x24"	2 <b>#</b> 5	2 #5		2#5 BARS MID	
B08	11'-7"	8"x19"	2 <b>#</b> 5	2 <b>#</b> 5		2#5 BARS MID	
B09	11'-7"	8"x31"	2 <b>#</b> 6	2 <b>#</b> 5	#3 AT 14"o.c.	2#5 BARS MID	
B10	11'-7"	8"x19"	2 <b>#</b> 7	2 <b>#</b> 6	#3 AT 8"o.c.	2#5 BARS MID	
B11	11'–7"	8"x44"	2 #6	2 #5	#3 AT 20"o.c.	2#5 BARS MID	
B12	12'-0"	8"x12"	2 #5	2 #5			
B13	9'-4"	8"x20 3/4"	2 #7	2 <b>#</b> 5	#3 AT 7"o.c.	2#5 BARS MID	
B14	11'-4"	8"x12"	2 <b>#</b> 5	2 <b>#</b> 5			
B15	9'-4"	8"x12"	2 <b>#</b> 5	2 <b>#</b> 5			
B16	11'-0"	8"x12"	2 <b>#</b> 5	2 <b>#</b> 5			
B20	19'–8"	8"x12"	2 #5	2 #5			
B21	19'–8"	8"x12"	2 #5	2 <b>#</b> 5	#3 AT 4"o.c.		
B22	16'-10"	8"x12"	2 #5	2 #5			
L1	8'-8"	8"×8"	1 #5			8"x8"PRECAST LINTEL 550 PLF	
L2	7'-2"	8"x8"	1 #5			8"x8"PRECAST LINTEL 550 PLF, OVER FIREPLACE	
BEAM	NOTES:						

1. ALL BEAMS SHALL HAVE #3 STIRRUPS AT 24" o.c. MAX.


2. CONCRETE BEAM DEPTHS VARY + OR - 2" FOR MASONRY OPENING REQUIREMENTS

3. ALL BEAMS OVER 24" DEEP TO HAVE (2)#5 MID BARS PER

\* TOP BARS MAY ONLY BE LAPPED MID POINT OF LONG SPAN

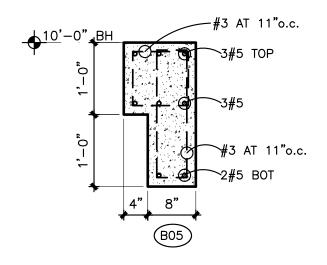

12" OF DEPTH

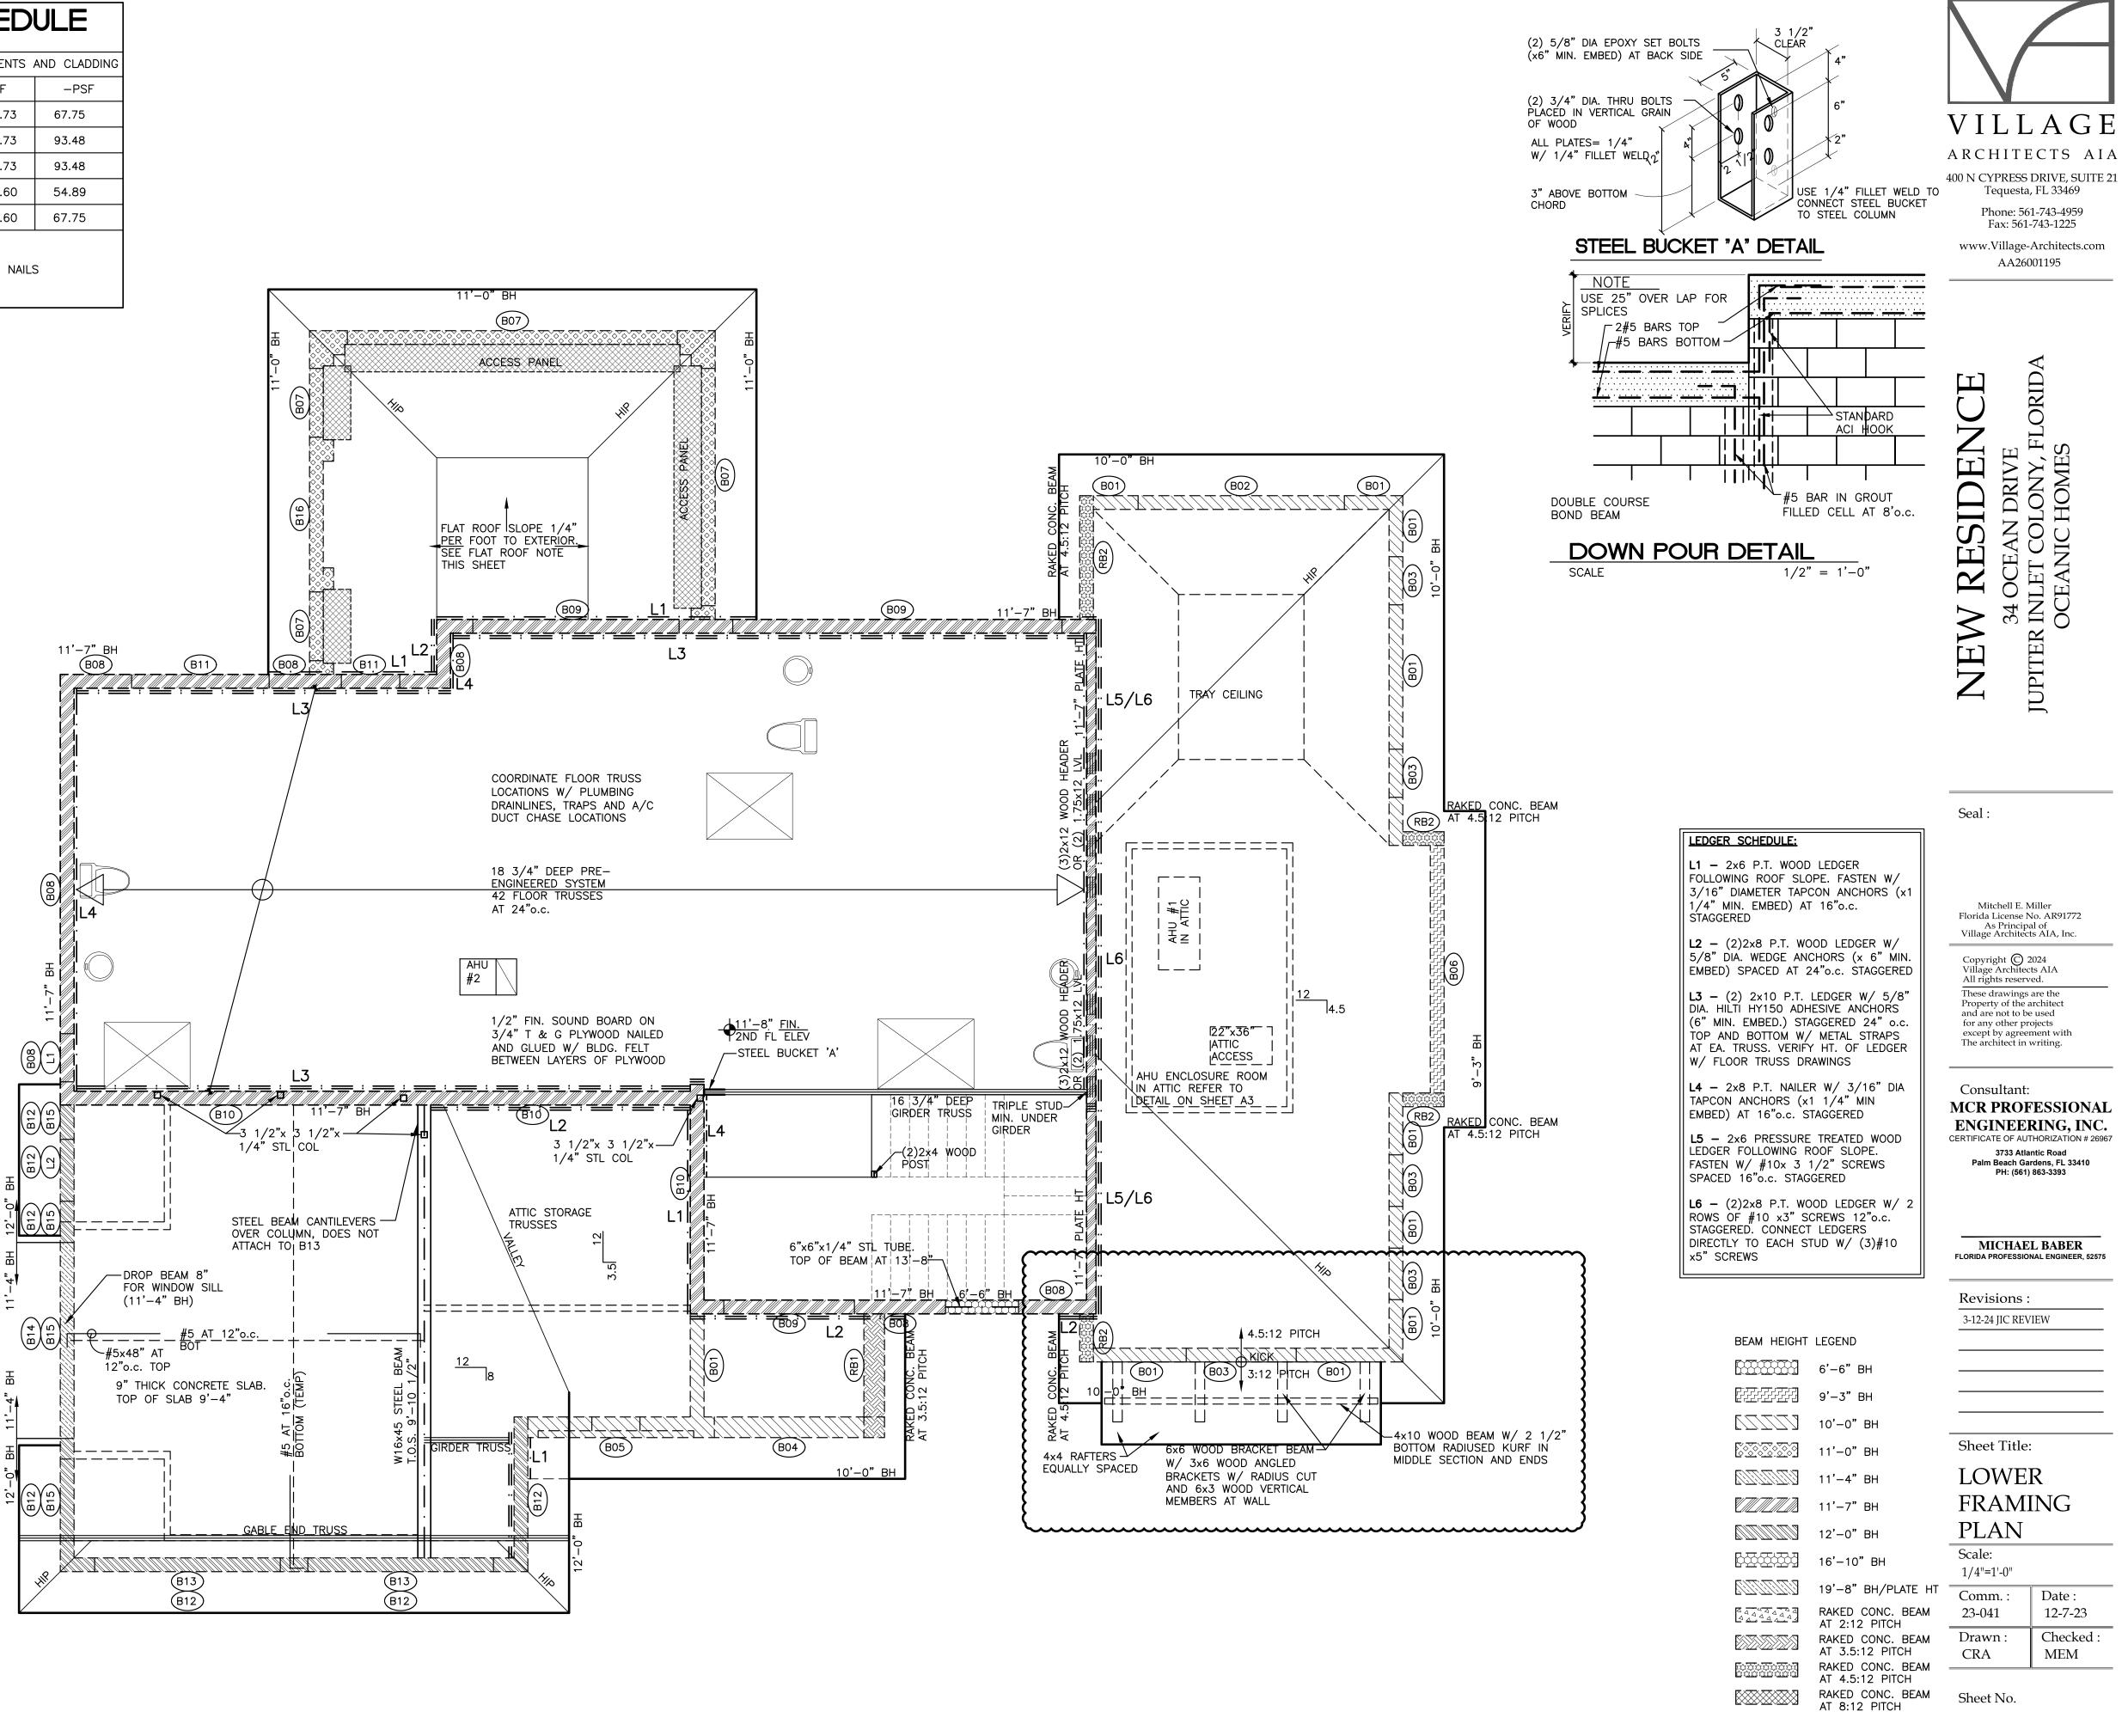


L O W E R F R A M I N G  $P \underset{\text{scale: } 1/4" = 1'-0"}{\text{I}}$ 

52

 $A_{E: 1/4"} = 1'-0"$ 

NO PENETRATIONS OR NOTCHES SHALL BE MADE IN ANY STRUCTURAL MEMBER INCLUDING CONCRETE BEAMS AND COLUMNS, MASONRY BLOCK AND STEEL BEAMS WITHOUT WRITTEN APPROVAL BY THE ENGINEER OF RECORD.

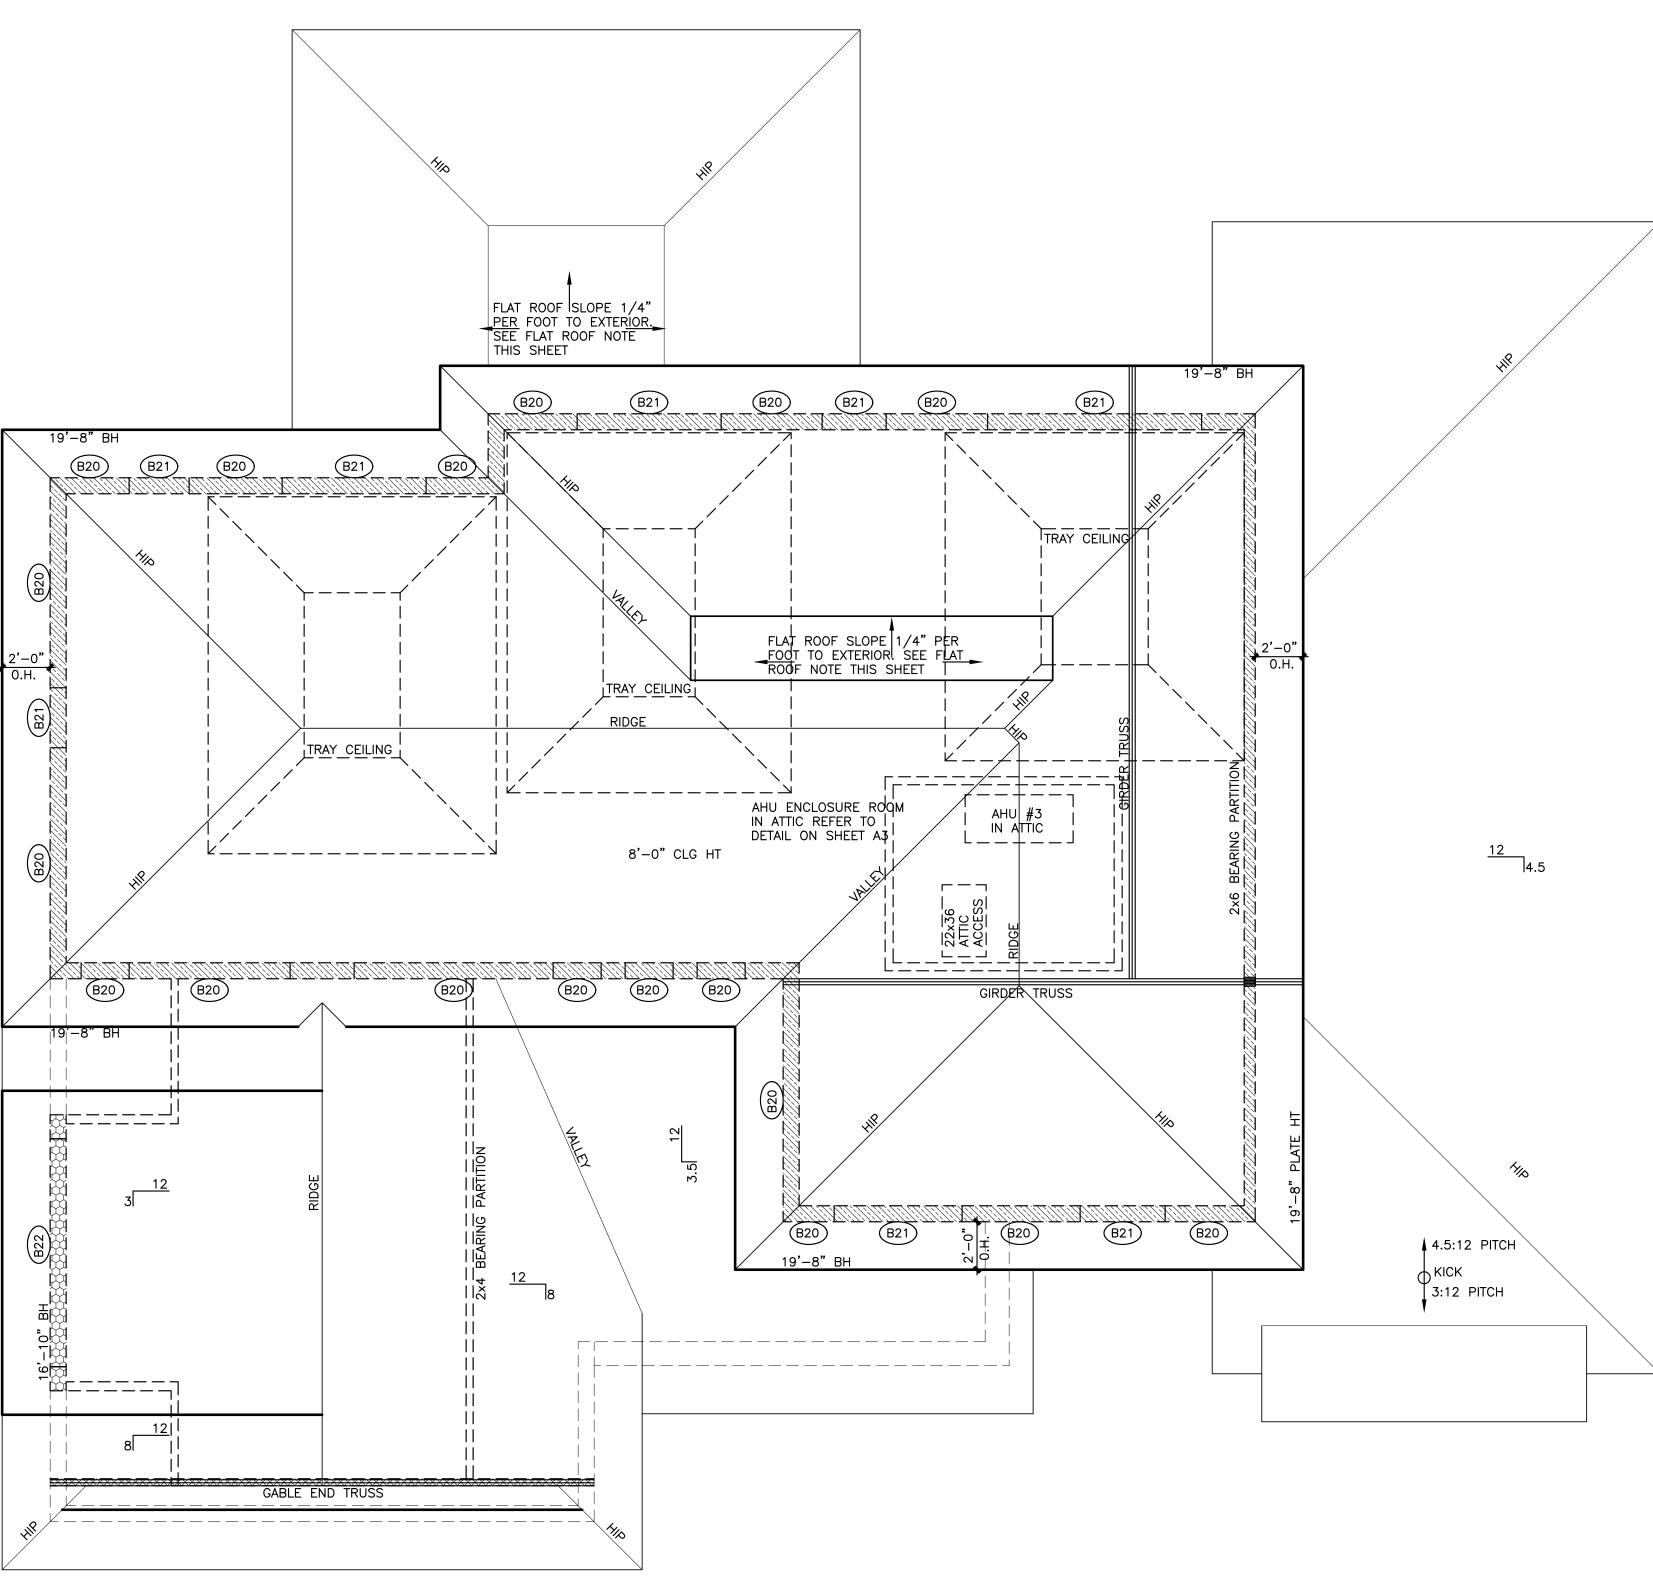

U P P E R F R A M I N G  $P \underset{\text{scale: 1/4"} = 1'-0"}{\text{I}}$ 



# CEAN DRIVE T COLONY, FLORIDA ANIC HOMES Щ RESIDENC INLE7 OCEA $\cup$ NEW -JUPITER

#### Seal :

# Mitchell E. Miller Florida License No. AR91772 As Principal of Village Architects AIA, Inc.

Copyright 🔘 2024 Village Architects AIA All rights reserved.

These drawings are the Property of the architect and are not to be used for any other projects except by agreement with The architect in writing.

## Consultant: MCR PROFESSIONAL **ENGINEERING, INC.** CERTIFICATE OF AUTHORIZATION # 26967 3733 Atlantic Road Palm Beach Gardens, FL 33410 PH: (561) 863-3393

#### MICHAEL BABER FLORIDA PROFESSIONAL ENGINEER. 52575

Revisions : 3-12-24 JIC REVIEW

11'—0" BH	Sheet Title:	:
11'-4" BH	UPPER	
11'-7" BH	FRAM	ING
12'-0" BH	PLAN	
16'-10" BH	Scale: 1/4"=1'-0"	
19'–8" BH/PLATE HT	Comm. :	Date :
RAKED CONC. BEAM AT 2:12 PITCH	23-041	12-7-23
RAKED CONC. BEAM AT 3.5:12 PITCH	Drawn : CRA	Checked : MEM

RAKED CONC. BEAM Sheet No. AT 8:12 PITCH

LEDGER SCHEDULE:

STAGGERED

L1 – 2x6 P.T. WOOD LEDGER

1/4" MIN. EMBED) AT 16"o.c.

FOLLOWING ROOF SLOPE. FASTEN W/

L2 - (2)2x8 P.T. WOOD LEDGER W/

5/8" DIA. WEDGE ANCHORS (x 6" MIN.

L3 – (2) 2×10 P.T. LEDGER W/ 5/8" DIA. HILTI HY150 ADHESIVE ANCHORS

(6" MIN. EMBED.) STAGGERED 24" o.c. TOP AND BOTTOM W/ METAL STRAPS AT EA. TRUSS. VERIFY HT. OF LEDGER

**L4 –** 2x8 P.T. NAILER W/ 3/16" DIA

L5 – 2×6 PRESSURE TREATED WOOD LEDGER FOLLOWING ROOF SLOPE.

L6 – (2)2x8 P.T. WOOD LEDGER W/ 2 ROWS OF #10 x3" SCREWS 12"o.c. STAGGERED. CONNECT LEDGERS

DIRECTLY TO EACH STUD W/(3)#10

BEAM HEIGHT LEGEND

6'-6" BH

[];;;;;;;;] 9'−3" BH

[\_\_\_\_] 10'-0" вн

ИЛИ 11'-7" ВН

\_\_\_\_\_ВН

6'-10" BH

RAKED CONC. BEAM AT 3.5:12 PITCH

RAKED CONC. BEAM AT 4.5:12 PITCH

11'-4" BH

<u>Ullillilli</u>li

FASTEN W/ #10x 3 1/2" SCREWS

SPACED 16"o.c. STAGGERED

x5" SCREWS

TAPCON ANCHORS (x1 1/4" MIN

EMBED) AT 16"o.c. STAGGERED

W/ FLOOR TRUSS DRAWINGS

EMBED) SPACED AT 24"o.c. STAGGERED

3/16" DIAMETER TAPCON ANCHORS (x1

NO PENETRATIONS OR NOTCHES SHALL BE MADE IN ANY STRUCTURAL MEMBER INCLUDING CONCRETE BEAMS AND COLUMNS, MASONRY BLOCK AND STEEL BEAMS WITHOUT WRITTEN APPROVAL BY THE ENGINEER OF RECORD.

"SIMPSON" TRUSS TIE DOWN CONNECTORS							
MARK	PRODUCT CODE	NAILS TO TRUSS	NAILS TO SEAT/TOP PL.		LATERAL LOADS F1(PERPEND) F2(PARALLEL)		APPROVAL NUMBER
$\langle A \rangle$	HETA12	7-10dx1 1/2"	EMBED	1520 #	340#	725#	FL11473
В	HETA16	9-10dx1 1/2"	EMBED	1810 #	340#	725 <b>#</b>	FL11473
<u>(</u>	MGT	22-10d	(1) 5/8" DIA	3965 <b>#</b>	_	_	FL11470
D HGT-2 16	16-10d	2-3/4" ATR	10980 #	_	-	FL10866	
E	E         HUS26         6-16d           (F)         H3         4-8d	6–16d	14—16d	1550 #	-	-	FL10655
F		4-8d	4–8d	415 #	125#	160#	FL10456
G	HTS20	8-10dx1 1/2	8-10dx1 1/2	1450 #	-	-	FL10456
Н	H10A	9-10dx1 1/2"	9-10dx1 1/2"	1140 #	590 <b>#</b>	285 <b>#</b>	FL11478
J H2.5A 5-8d		5-8d	5–8d	-	_	600 <b>#</b>	FL10456
К	VTCR	3-10dx1 1/2"	4-10d	370 <b>#</b>	_	_	
	<u> </u>	TRUSS TIE DOWN				TRUSS CON	

PRODUCT CODE NUMBERS ARE AS MANUFACTURED BY SIMPSON STRONG-THE COMPANY, INC SUBSTITUTIONS ARE ACCEPTABLE WITH THE APPROVAL OF THE STRUCTURAL ENGINEER.

## NOTES:

1. ROOF AND FLOOR LAYOUTS PROVIDED ON THESE PLANS HAVE BEEN USED FOR BUILDING STRUCTURAL AND ARCHITECTURAL DESIGN. TRUSS MANUFACTURER IS RESPONSIBLE FOR FINAL TRUSS LAYOUT, SPANS, AND ALL TRUSS/HEADER ENGINEERING. CHANCES TO THIS LAYOUT THAT AFFECT STRUCTURAL OR ARCHITECTURAL DESIGNS AS SHOWN ON THIS PLAN SHALL BE PROVIDED TO AND APPROVED BY THE ARCHITECT PRIOR TO THE FABRICATION OF TRUSSES.

2. WOOD TRUSSES, SHALL BE FABRICATED BY A LICENSED WOOD TRUSS FABRICATOR. TRUSSES SHALL BE FURNISHED IN ACCORDANCE WITH DESIGNS PREPARED BY AND SIGNED AND SEALED BY A FLORIDA REGISTERED PROFESSIONAL ENGINEER. TRUSS DESIGN SHALL FOLLOW THE SPECIFICATIONS AS OUTLINED BY THE "NATIONAL DESIGN SPECIFICATIONS FOR STRESS GRADE LUMBER" AND IT'S FASTENINGS BY AMERICAN INSTITUTE OF TIMBER CONSTRUCTION (LATEST REVISION), AND "DESIGN SPECIFICATIONS FOR LIGHT METAL PLATE CONNECTED WOOD TRUSSES", BY THE TRUSS PLATE INSTITUTE.

3. THE DESIGN AND SHOP DRAWINGS, AS WELL AS THE FABRICATION OF WOOD TRUSSES, WILL BE SUBJECT TO THE INSPECTION AND APPROVAL OF THE ENGINEER AT ALL TIMES.

4. THE HANDLING AND ERECTION OF WOOD TRUSSES SHALL BE IN ACCORDANCE WITH THE SPECIFICATIONS NOTED ON THE DESIGN DRAWINGS.

5. ALL ENGINEERED BEAMS AND METAL CONNECTORS BETWEEN MATERIAL SUPPLIED BY THE TRUSS MANUFACTURER SHALL BE SUPPLIED BY THE TRUSS MANUFACTURER.

6. ATTACH VALLEYS AND "PIGGY-BACKS" IN ACCORDANCE WITH TRUSS SUPPLIERS DETAILS.


7. THIS ARCHITECT WILL REVIEW THE TRUSS SHOP DRAWINGS ONLY AFTER THE CONTRACTOR HAS PREVIOUSLY REVIEWED THE TRUSS SHOP DRAWINGS. PLEASE SUBMIT TO OUR OFFICE A MINIMUM OF TWO PAPER COPIES OF BOTH THE TRUSS PLANS AND THE TRUSS CUT SHEETS. WE WILL NOT REVIEW OR MARK UP PDF FILES. WE ALSO WILL NOT REVIEW PREVIEW PLANS WITHOUT CUT SHEETS. AFTER OUR REVIEW, OUR OFFICE WILL RETAIN ONE PAPER COPY OF THE PLANS AND THE CUT SHEETS FOR OUR RECORDS.

8. TRUSSES SHALL BE DESIGNED TO A MINIMUM DEFLECTION OF L/360 OR A TOTAL DEFLECTION NOT TO EXCEED 1/2" ON THE BOTTOM CHORD.

WHEN OUTLOOKERS DON'T ALIGN W/ IRUSSES: -

END OF OUTLOOKER, USE SIMPSON LS90 AT EACH

CONNECTION

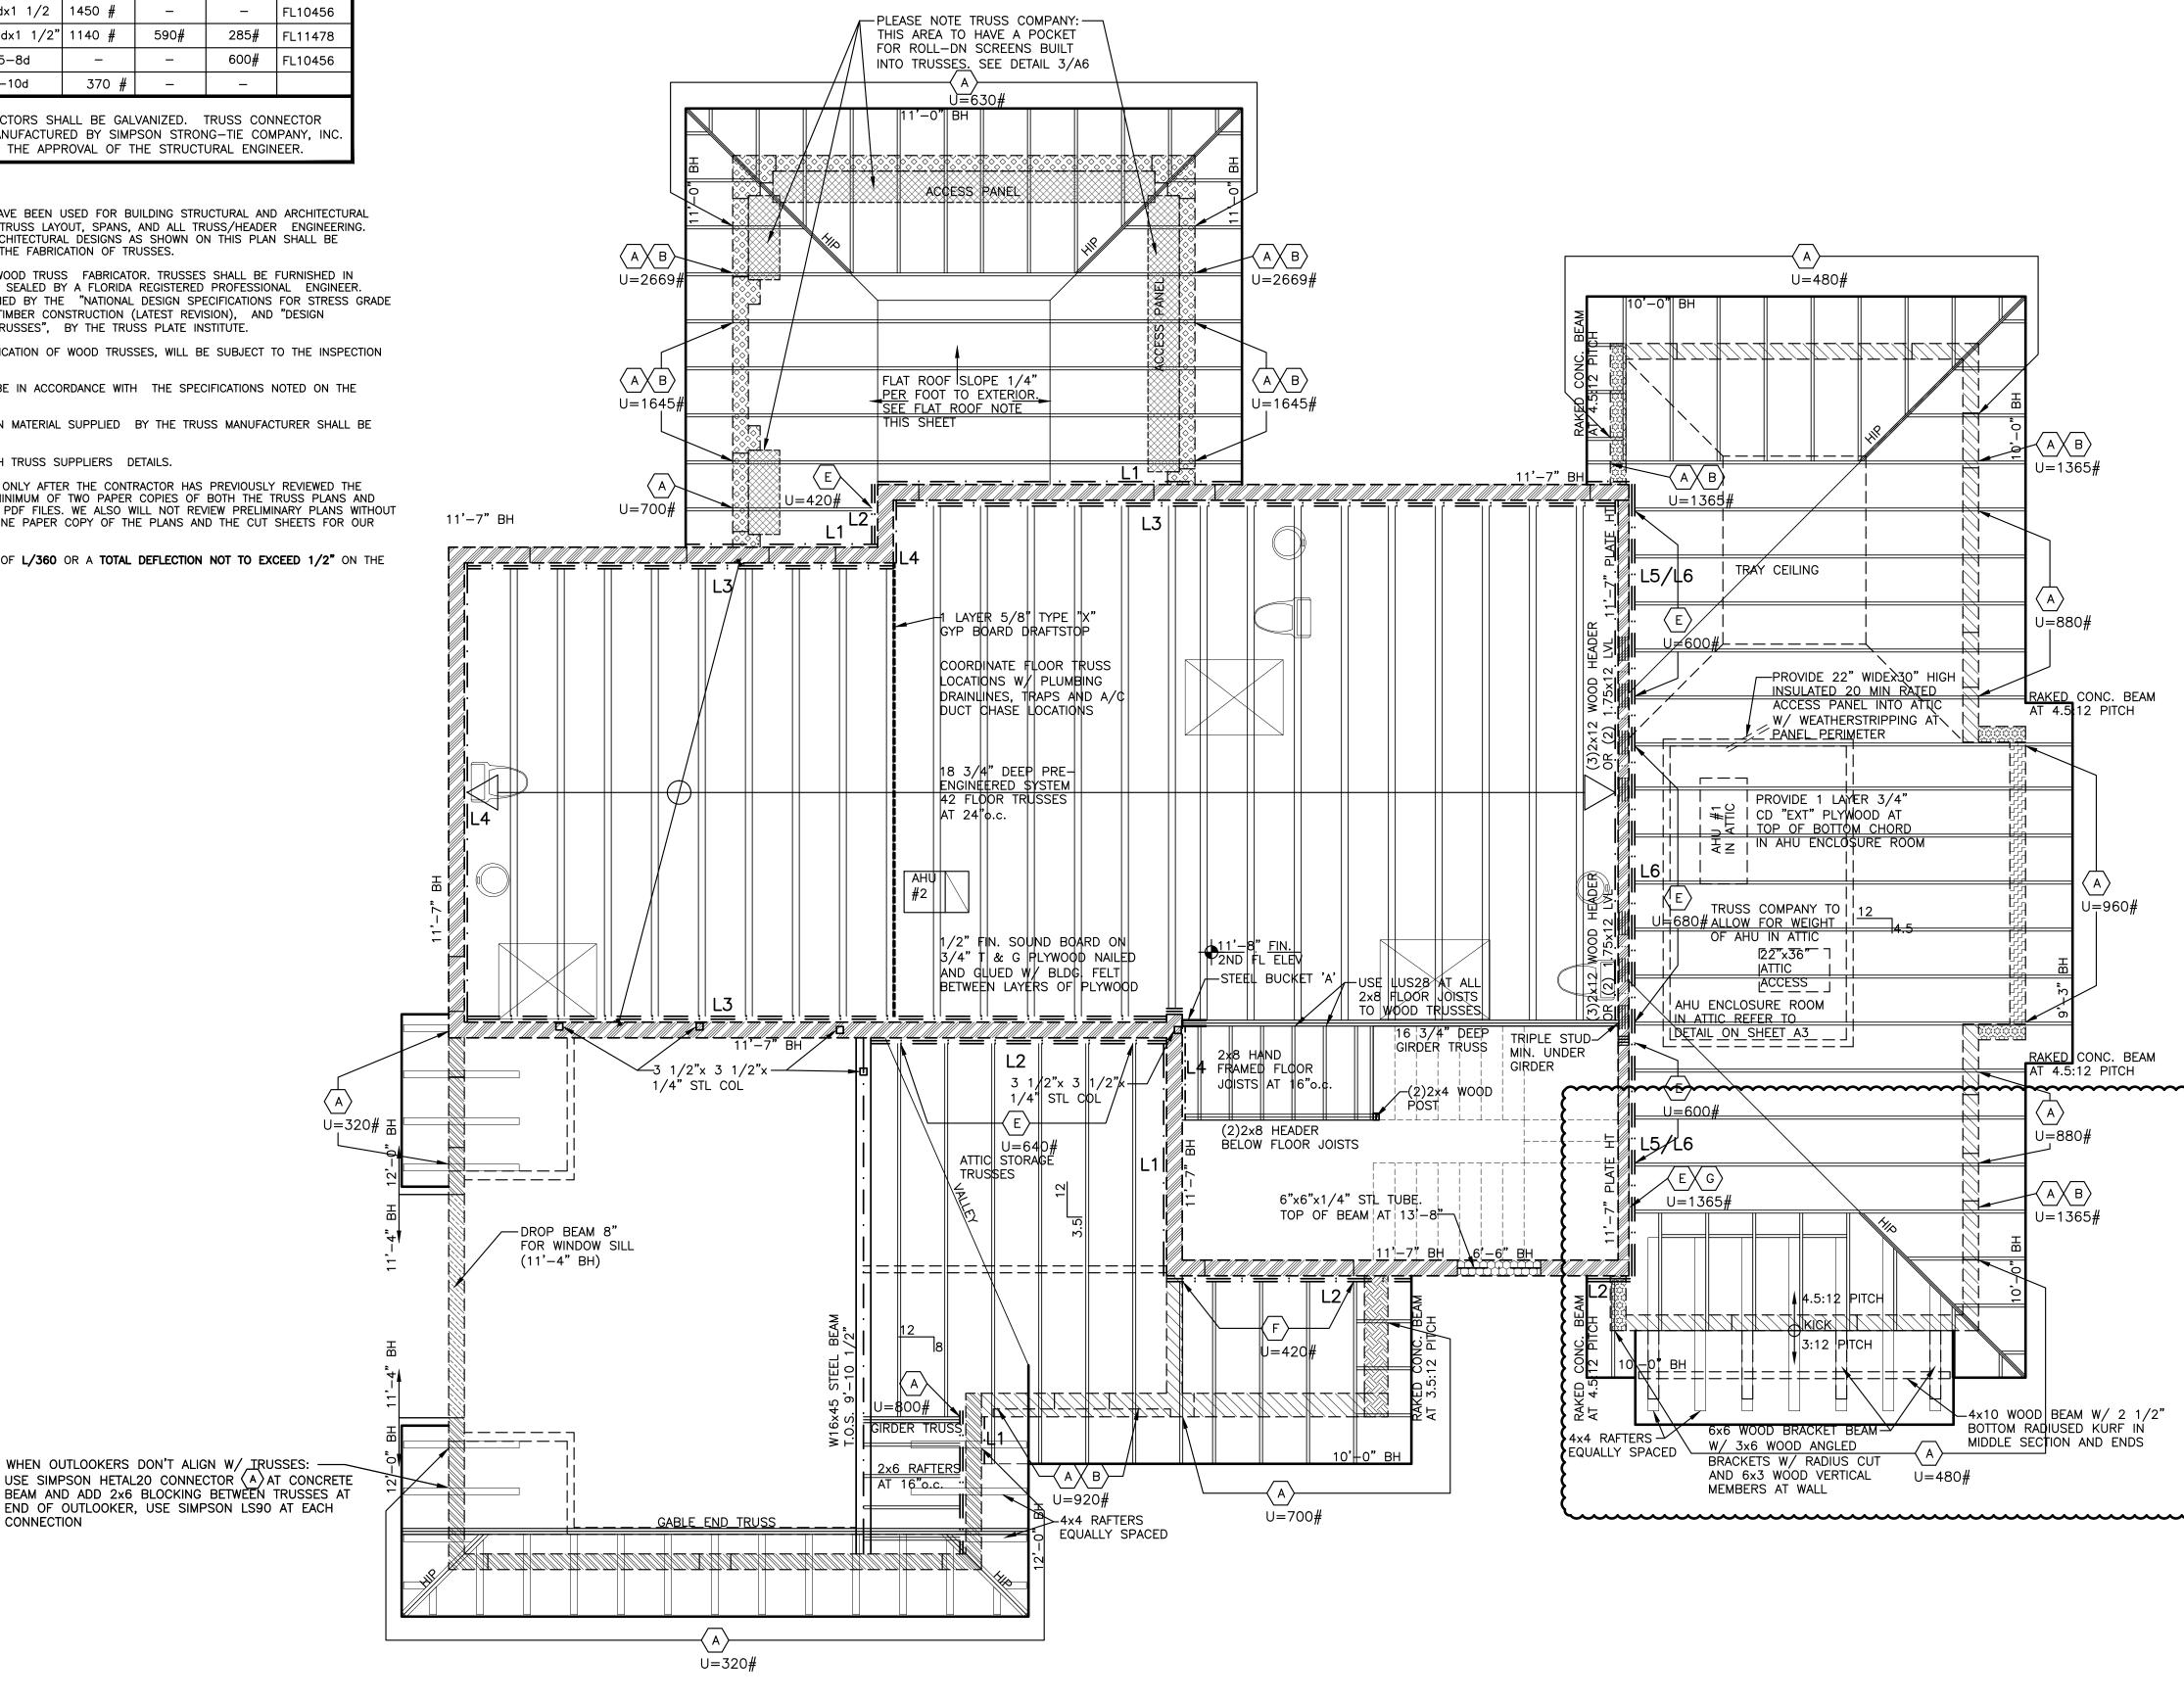

LOWER TRUSS  $P \underset{\text{scale: } 1/4" = 1'-0"}{\text{L}}$ 



ORID

N DRIVE DLONY, HOME

Ο

 $\mathbb{N}$ 

UPITEI

Ц

 $\triangleleft$ 

 $\cup$ 

-+

Ш

SIDEN

RE

ГЦ

 $\sim$ 

#### LEDGER SCHEDULE:

L1 – 2x6 P.T. WOOD LEDGER FOLLOWING ROOF SLOPE. FASTEN W/ 3/16" DIAMETER TAPCON ANCHORS (x1 1/4" MIN. EMBED) AT 16"o.c. STAGGERED

L2 - (2)2x8 P.T. WOOD LEDGER W/ 5/8" DIA. WEDGE ANCHORS (x 6" MIN. EMBED) SPACED AT 24"o.c. STAGGERED

L3 – (2) 2x10 P.T. LEDGER W/ 5/8" DIA. HILTI HY150 ADHESIVE ANCHORS (6" MIN. EMBED.) STAGGERED 24" o.c. TOP AND BOTTOM W/ METAL STRAPS AT EA. TRUSS. VERIFY HT. OF LEDGER W/ FLOOR TRUSS DRAWINGS

**L4 –** 2x8 P.T. NAILER W/ 3/16" DIA TAPCON ANCHORS (x1 1/4" MIN EMBED) AT 16"o.c. STAGGERED

L5 – 2x6 PRESSURE TREATED WOOD LEDGER FOLLOWING ROOF SLOPE. FASTEN W/ #10x 3 1/2" SCREWS SPACED 16"o.c. STAGGERED

L6 - (2)2x8 P.T. WOOD LEDGER W/ 2 ROWS OF #10 x3" SCREWS 12"o.c. STAGGERED. CONNECT LEDGERS DIRECTLY TO EACH STUD W/(3)#10 x5" SCREWS

#### BEAM HEIGHT LEGEND 6'-6" BH [ZZZZ]10'—0" BH 11'—0" BH UTITITI S 11'-4" BH 11'—7" BH 12'-0" BH 16'—10" BH 19'-8" BH/PLATE HT RAKED CONC. BEAM AT 2:12 PITCH RAKED CONC. BEAM <u> XXXXX</u>XX AT 3.5:12 PITCH RAKED CONC. BEAM Fry 777 1 77 AT 4.5:12 PITCH RAKED CONC. BEAM AT 8:12 PITCH

ALL TRUSS CONNECTORS SPECIFIED BASED ON A F2 FORCE OF 573# ON EACH TRUSS

NO PENETRATIONS OR NOTCHES SHALL BE MADE IN ANY STRUCTURAL MEMBER INCLUDING CONCRETE BEAMS AND COLUMNS, MASONRY BLOCK AND STEEL BEAMS WITHOUT WRITTEN APPROVAL BY THE ENGINEER OF RECORD.

## Seal :

#### Mitchell E. Miller Florida License No. AR91772 As Principal of Village Architects AIA, Inc.

Copyright 🔘 2024 Village Architects AIA All rights reserved.

These drawings are the Property of the architect and are not to be used for any other projects except by agreement with The architect in writing.

#### Consultant: MCR PROFESSIONAL **ENGINEERING, INC.** CERTIFICATE OF AUTHORIZATION # 26967 3733 Atlantic Road Palm Beach Gardens, FL 33410 PH: (561) 863-3393

#### MICHAEL BABER FLORIDA PROFESSIONAL ENGINEER, 52575

Revisions : 3-12-24 JIC REVIEW

#### Sheet Title:

LOWER TRUSS PLAN

Scale: 1/4"=1'-0"	
Comm. :	Date :
23-041	12-7-23
Drawn :	Checked :
CRA	MEM

Sheet No.




#### **DESIGN CRITERIA:** DESIGN CODE: FLORIDA BUILDING CODE 8TH EDITION (2023) ACI 318-19 ASCE 7-22 SUPERIMPOSED LOADS: ROOF:ATTIC STORAGE TRUSSES:DEAD LOAD=25 psfDEAD LOAD=30 psfLIVE LOAD=30 psfTOTAL=55 psfBOTTOM CHORDLIVE LOADLIVE LOAD=30 psfLIVE LOAD10 psfLIVE LOAD10 psfLIVE LOAD10 psfLIVE LOAD **ROOF W/ MECH** DEAD LOAD = 25 psf LIVE LOAD = 30 psf MECHANICAL = 5 psf LIVE LOAD = 30 psfTOTAL = 60 psfTOTAL = 85 psf WIND: WIND SPEED = 170 mph EXPOSURE "D" RISK CATEGORY II INTERNAL PRESSURE COEFFICIENT = 0.18WIND IMPORTANCE FACTOR = 1.0MEAN ROOF HEIGHT = 22'-7"FOUNDATIONS: FOUNDATIONS DESIGNED FOR AN ALLOWABLE SAFE BEARING CAPACITY OF 2,500 psf. CONCRETE: 5,000 psi WITH WATER/CEMENT RATIO=.040 FOR FOOTINGS AND SLABS ON GRADE. 5,000 psi FOR ALL STRUCTURAL CONCRETE (U.N.O.) WITH WATER /CEMENT RATIO = 0.4 (BROOM FINISH AT ALL CONCRETE BALCONIES) NO WATER TO BE ADDED ON SITE. WATER REDUCERS MAY BE USED IN MIX DESIGN SUBMIT CONCRETE MIX DESIGNS TO ARCHITECT/ ENGINEER FOR APPROVAL REINFORCING STEEL: CONFORMS TO ASTM A615, GRADE 60 DEFORMED BARS. WELDED WIRE MESH: CONFORMS TO ASTM A-185. MASONRY WALLS: MASONRY UNITS: ASTM C-90 (f'm= 1,500 psi) MORTAR: ASTM C-270, TYPE "M" OR "S" GROUT: ASTM C-476 (PEA GRAVEL CONCRETE IS PROHIBITED) 5'-0" <u>STRUCTURAL STEEL:</u> STRUCTURAL STEEL TUBING SHALL CONFORM TO ASTM A-500, Fy = 46 ksi. STRUCTURAL STEEL PLATES SHALL CONFORM TO ASTM A-36. ALL SHOP CONNECTIONS SHALL BE WELDED UTILIZING E70XX ELECTRODES. 0.H. SETBACK <u>WOOD:</u> STRUCTURAL WOOD COMPONENTS SHALL HAVE THE FOLLOWING MINIMUM ALLOWABLE FIBER STRESSES: BENDING: 1,200 psi SHEAR: 90 psi U=480# WOOD IN CONTACT WITH MASONRY OR CONCRETE SHALL BE PROTECTED OR PRESSURE

TREATED IN ACCORDANCE WITH AITC-109. MANUFACTURED WOOD: MEMBERS DESIGNATED 'LVL' (e.g. , 1-3/4" x 11-7/8" LVL) SHALL BE LAMINATED VENEER LUMBER AS MANUFACTURED BY TRUSSJOIST MacMILLAN (MICROLLAM), OR ENGINEER APPROVED SUBSTITUTION. Fb= 3100 psi, E= 2,000,000 psi, Fv= 285 psi.

CONNECTION

19ï-8″ E WHEN OUTLOOKERS DON'T ALIGN W/ TRUSSES: 12 USE SIMPSON HETAL20 CONNECTOR  $\langle A \rangle$  AT CONCRETE Ê BEAM AND ADD 2x6 BLOCKING BETWEEN TRUSSES AT END OF OUTLOOKER, USE SIMPSON LS90 AT EACH CONNECTION U=587# <u>-</u> è₿ ╤╫┲╼┼┽╼╺┥┝╸┑ | i| || WHEN OUTLOOKERS DON'T ALIGN W/\_IRUSSES: · 12 USE SIMPSON HETAL20 CONNECTOR  $\langle A \rangle$  AT CONCRETE BEAM AND ADD 2x6 BLOCKING BETWEEN TRUSSES AT END OF OUTLOOKER, USE SIMPSON LS90 AT EACH 

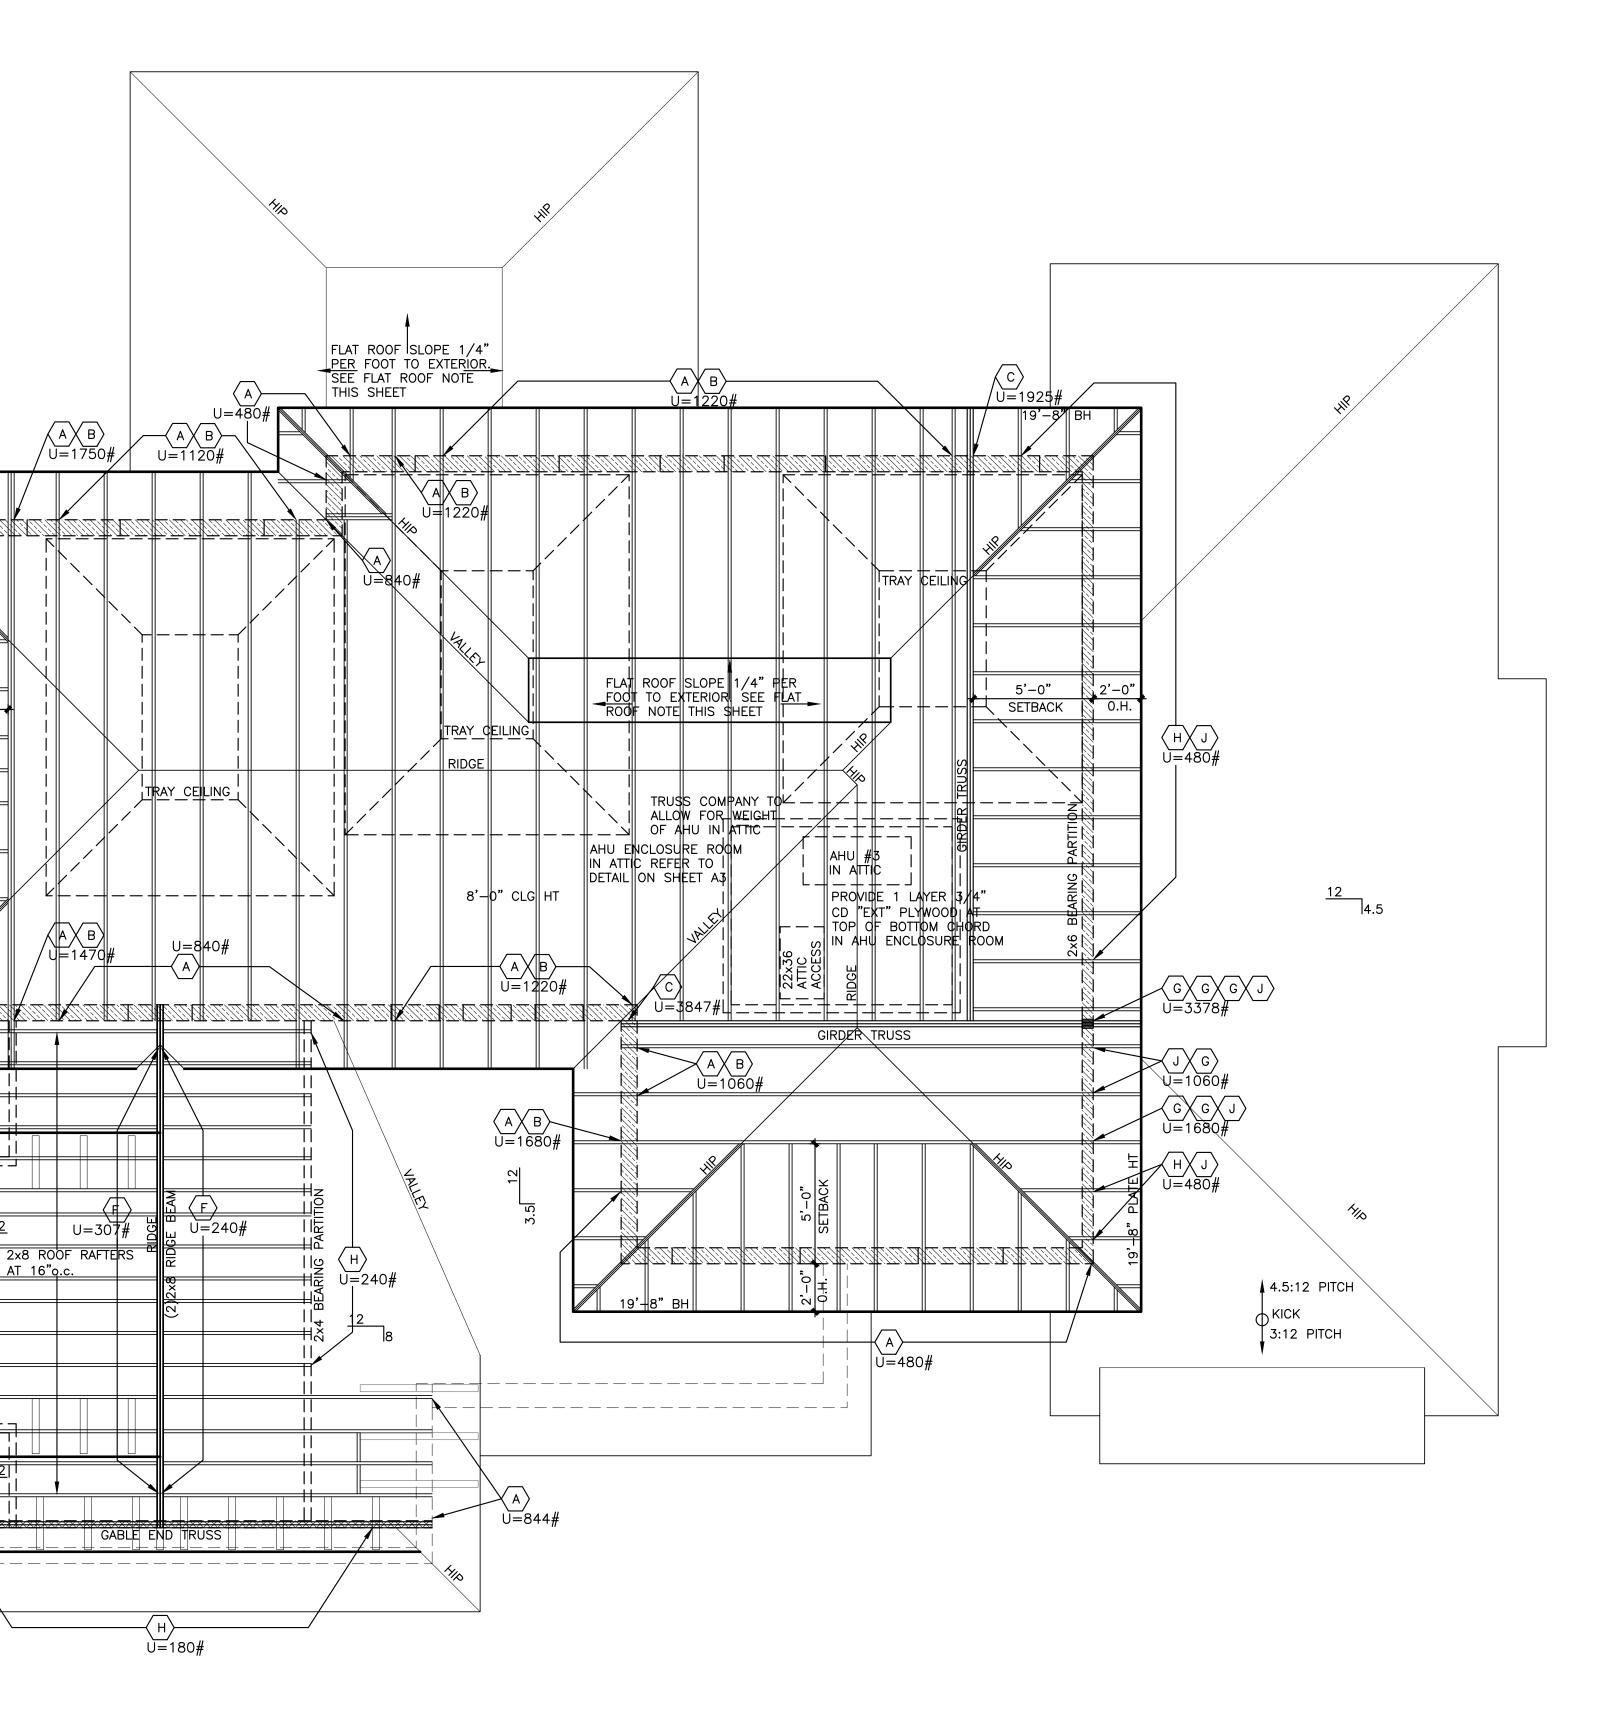

U P P E R T R U S S P L A N SCALE: 1/4" = 1'-0"



## CEAN DRIVE ET COLONY, FLORIDA ANIC HOMES $[\mathbf{I}]$ RESIDEN $\cup$ - $\geq$ IUPITER Ξ

#### Seal :

LEDGER SCHEDULE:

STAGGERED

L1 – 2x6 P.T. WOOD LEDGER

1/4" MIN. EMBED) AT 16"o.c.

FOLLOWING ROOF SLOPE. FASTEN W/

L2 - (2)2x8 P.T. WOOD LEDGER W/

5/8" DIA. WEDGE ANCHORS (x 6" MIN.

L3 – (2) 2x10 P.T. LEDGER W/ 5/8" DIA. HILTI HY150 ADHESIVE ANCHORS

(6" MIN. EMBED.) STAGGERED 24" o.c.

TOP AND BOTTOM W/ METAL STRAPS AT EA. TRUSS. VERIFY HT. OF LEDGER

**L4 –** 2x8 P.T. NAILER W/ 3/16" DIA

L5 – 2x6 PRESSURE TREATED WOOD

L6 - (2)2x8 P.T. WOOD LEDGER W/ 2

TAPCON ANCHORS (x1 1/4" MIN

LEDGER FOLLOWING ROOF SLOPE.

SPACED 16"o.c. STAGGERED

x5" SCREWS

FASTEN W/ #10x 3 1/2" SCREWS

ROWS OF #10 x3" SCREWS 12"o.c.

DIRECTLY TO EACH STUD W/(3)#10

BEAM HEIGHT LEGEND

[ZZZZ]

UTITITI S

<u>UNNNN</u>

<u>EXIXIXIX</u>IX

ALL TRUSS CONNECTORS

OF 468# ON EACH TRUSS

6'-6" BH

9'—3" BH

10'—0" BH

11'-0" BH

11'-4" BH

11'—7"BH

12'—0" BH

16'—10" BH

19'–8" BH/PLATE HT

RAKED CONC. BEAM AT 2:12 PITCH

RAKED CONC. BEAM

RAKED CONC. BEAM

AT 3.5:12 PITCH

STAGGERED. CONNECT LEDGERS

EMBED) AT 16"o.c. STAGGERED

W/ FLOOR TRUSS DRAWINGS

EMBED) SPACED AT 24"o.c. STAGGERED

3/16" DIAMETER TAPCON ANCHORS (x1

#### Mitchell E. Miller Florida License No. AR91772 As Principal of Village Architects AIA, Inc.

Copyright 🔘 2024 Village Architects AIA All rights reserved.

These drawings are the Property of the architect and are not to be used for any other projects except by agreement with The architect in writing.

## Consultant: MCR PROFESSIONAL **ENGINEERING, INC.** CERTIFICATE OF AUTHORIZATION # 26967 3733 Atlantic Road Palm Beach Gardens, FL 33410 PH: (561) 863-3393

#### MICHAEL BABER FLORIDA PROFESSIONAL ENGINEER, 52575

Revisions : 3-12-24 JIC REVIEW

## Sheet Title: UPPER TRUSS PLAN

Scale: 1/4"=1'-0"	
Comm. :	Date :
23-041	12-7-23
Drawn :	Checked :
CRA	MEM


Sheet No.

NO PENETRATIONS OR NOTCHES SHALL BE MADE IN ANY STRUCTURAL MEMBER INCLUDING CONCRETE BEAMS AND COLUMNS, MASONRY BLOCK AND STEEL BEAMS WITHOUT WRITTEN APPROVAL BY THE ENGINEER OF RECORD.

SPECIFIED BASED ON A F2 FORCE

AT 4.5:12 PITCH

RAKED CONC. BEAM AT 8:12 PITCH

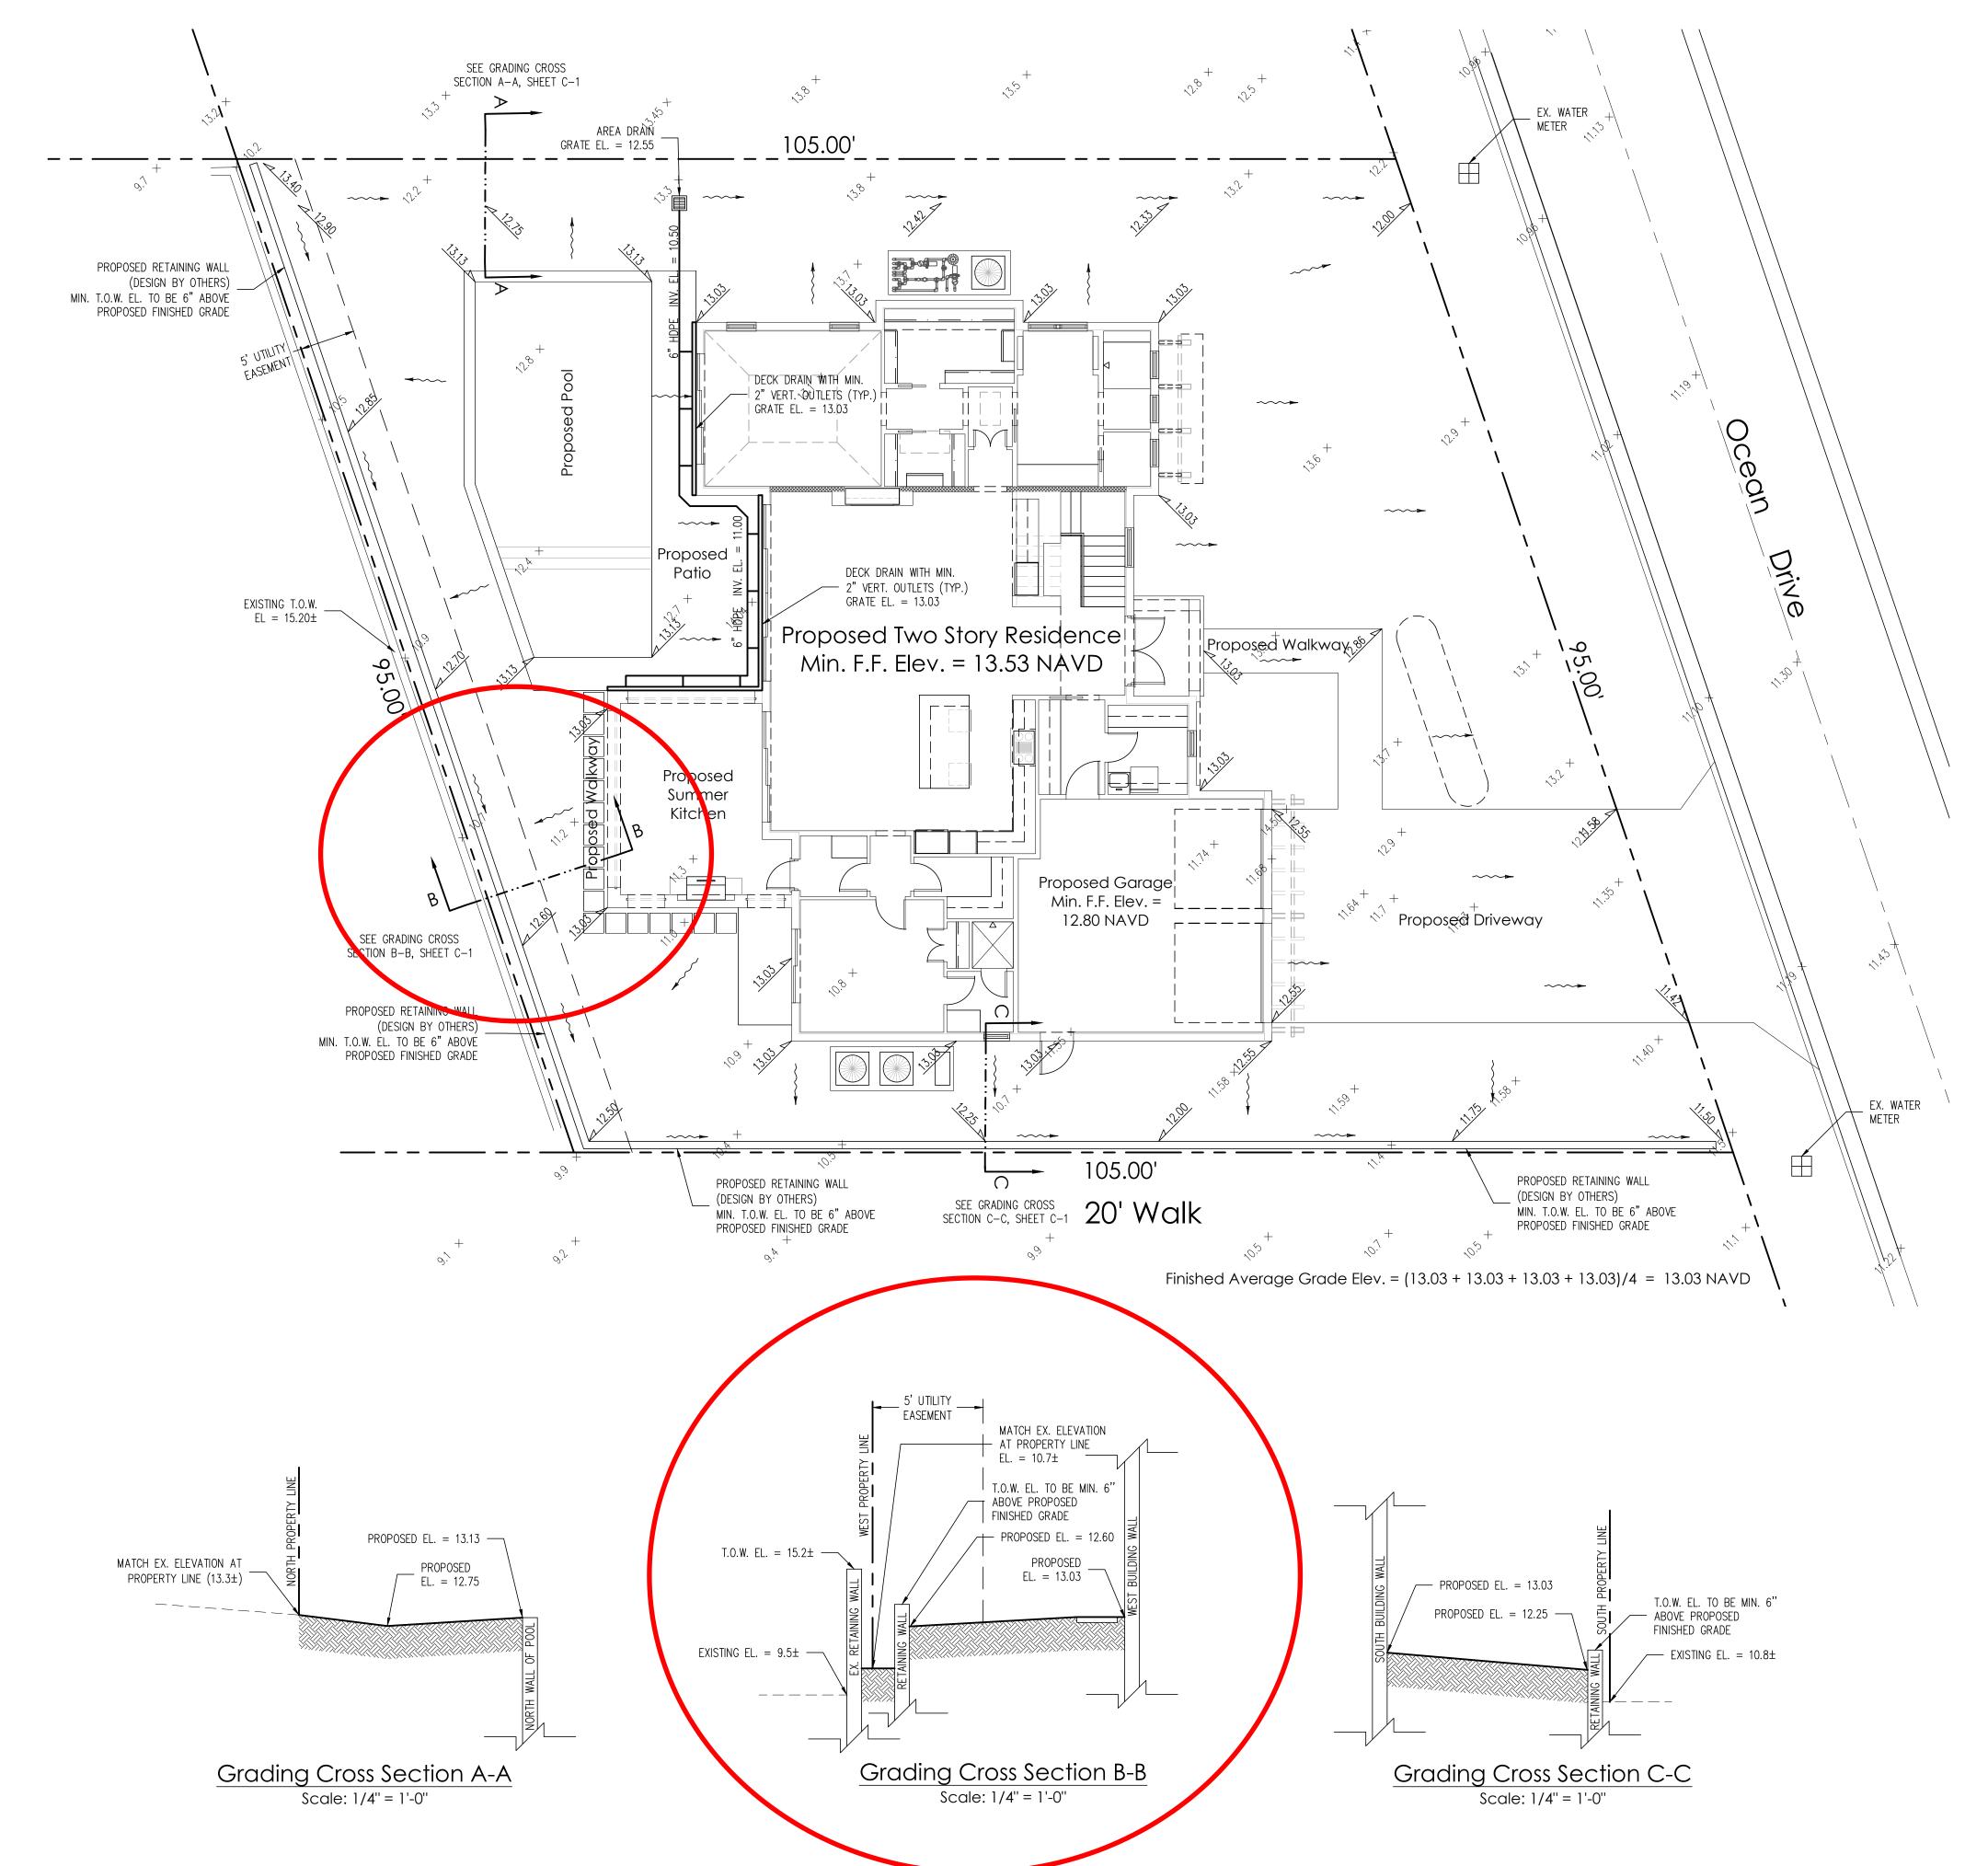

# Notes:


1) Exfiltration trenches and storm piping to be protected from roots with a root barrier.

2) Roof drain downspouts are to be connected to the proposed drainage system. Contractor to provide engineer with downspout locations prior to installation of drainage system.

3) Contractor shall mill and overlay all roadway cuts a minimum of 50 ft. on either side of the excavation the entire width of each affected lane.

4) Contractor is responsible for installing and maintaining erosion control measures during construction.

5) Video inspection of storm drainage system required prior to installation of sod.

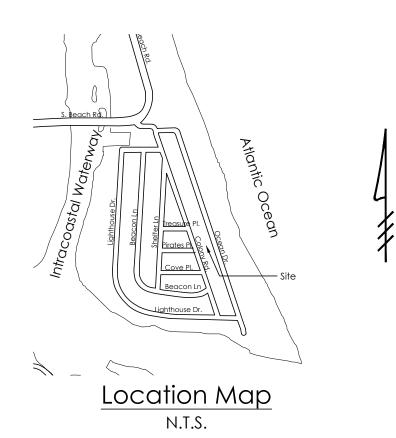

## GRUBER CONSULTING **ENGINEERS**


2475 Mercer Avenue, Suite 305 West Palm Beach, FL 33401 61.312.2041 office@gruberengineers.com

48 HOURS BEFORE DIGGING, CALL 1-800-432-4770 SUNSHINE STATE ONE CALL OF FLORIDA, INC.

Contractor is responsible for obtaining location of existing utilities prior to commencement of construction activities.

# Legend

EXISTING ELEVATION PER R.L. VAUGHT & ASSOC. (NAVD-88) Ø PROPOSED ELEVATION (NAVD-88) --7.00 --- PROPOSED ELEVATION CONTOUR (NAVD-88) ----- FLOW DIRECTION AREA DRAIN

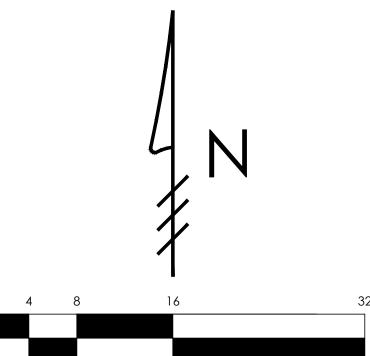

Scale: 1/8" = 1'-0"



03/04/24 UPDATE PLAN BACKGROUND; REVISE PROPOSED GRADING AND DRAINAGE; ADD GRADING CROSS SECTIONS 03/14/24 REVISE PROPOSED GRADING AND CROSS SECTIONS

2

Plan Background from Site Plan by Village Architects Received 2/26/24 © 2024 Gruber Consulting Engineers, Inc.

SIDEN Plan For: Ю Ю **D**  $\square$ ళ S ling 0 Grad QP PR Site O 34

ш

U

#### **PROJECT INFORMATION:** Project No. | 2024-0003

Issue Date 02/01/2024

Sca	Scale 1/8" = 1'-0		
REV	SIONS:		
1	03/0	04/2024	
2	03/1	4/2024	
3			
4			
5			
6			
7			
8			
9			
10			


CHAD M. GRUBER

FLORIDA P.E. NO. 57466

This item has been electronically signed and sealed by Chad M. Gruber on the date adjacent to the seal using a SHA authentication code. Printed copies of this document are not considered signed and sealed and the SHA authentication code must be verified on any electronic copies.

SHEET NUMBER:



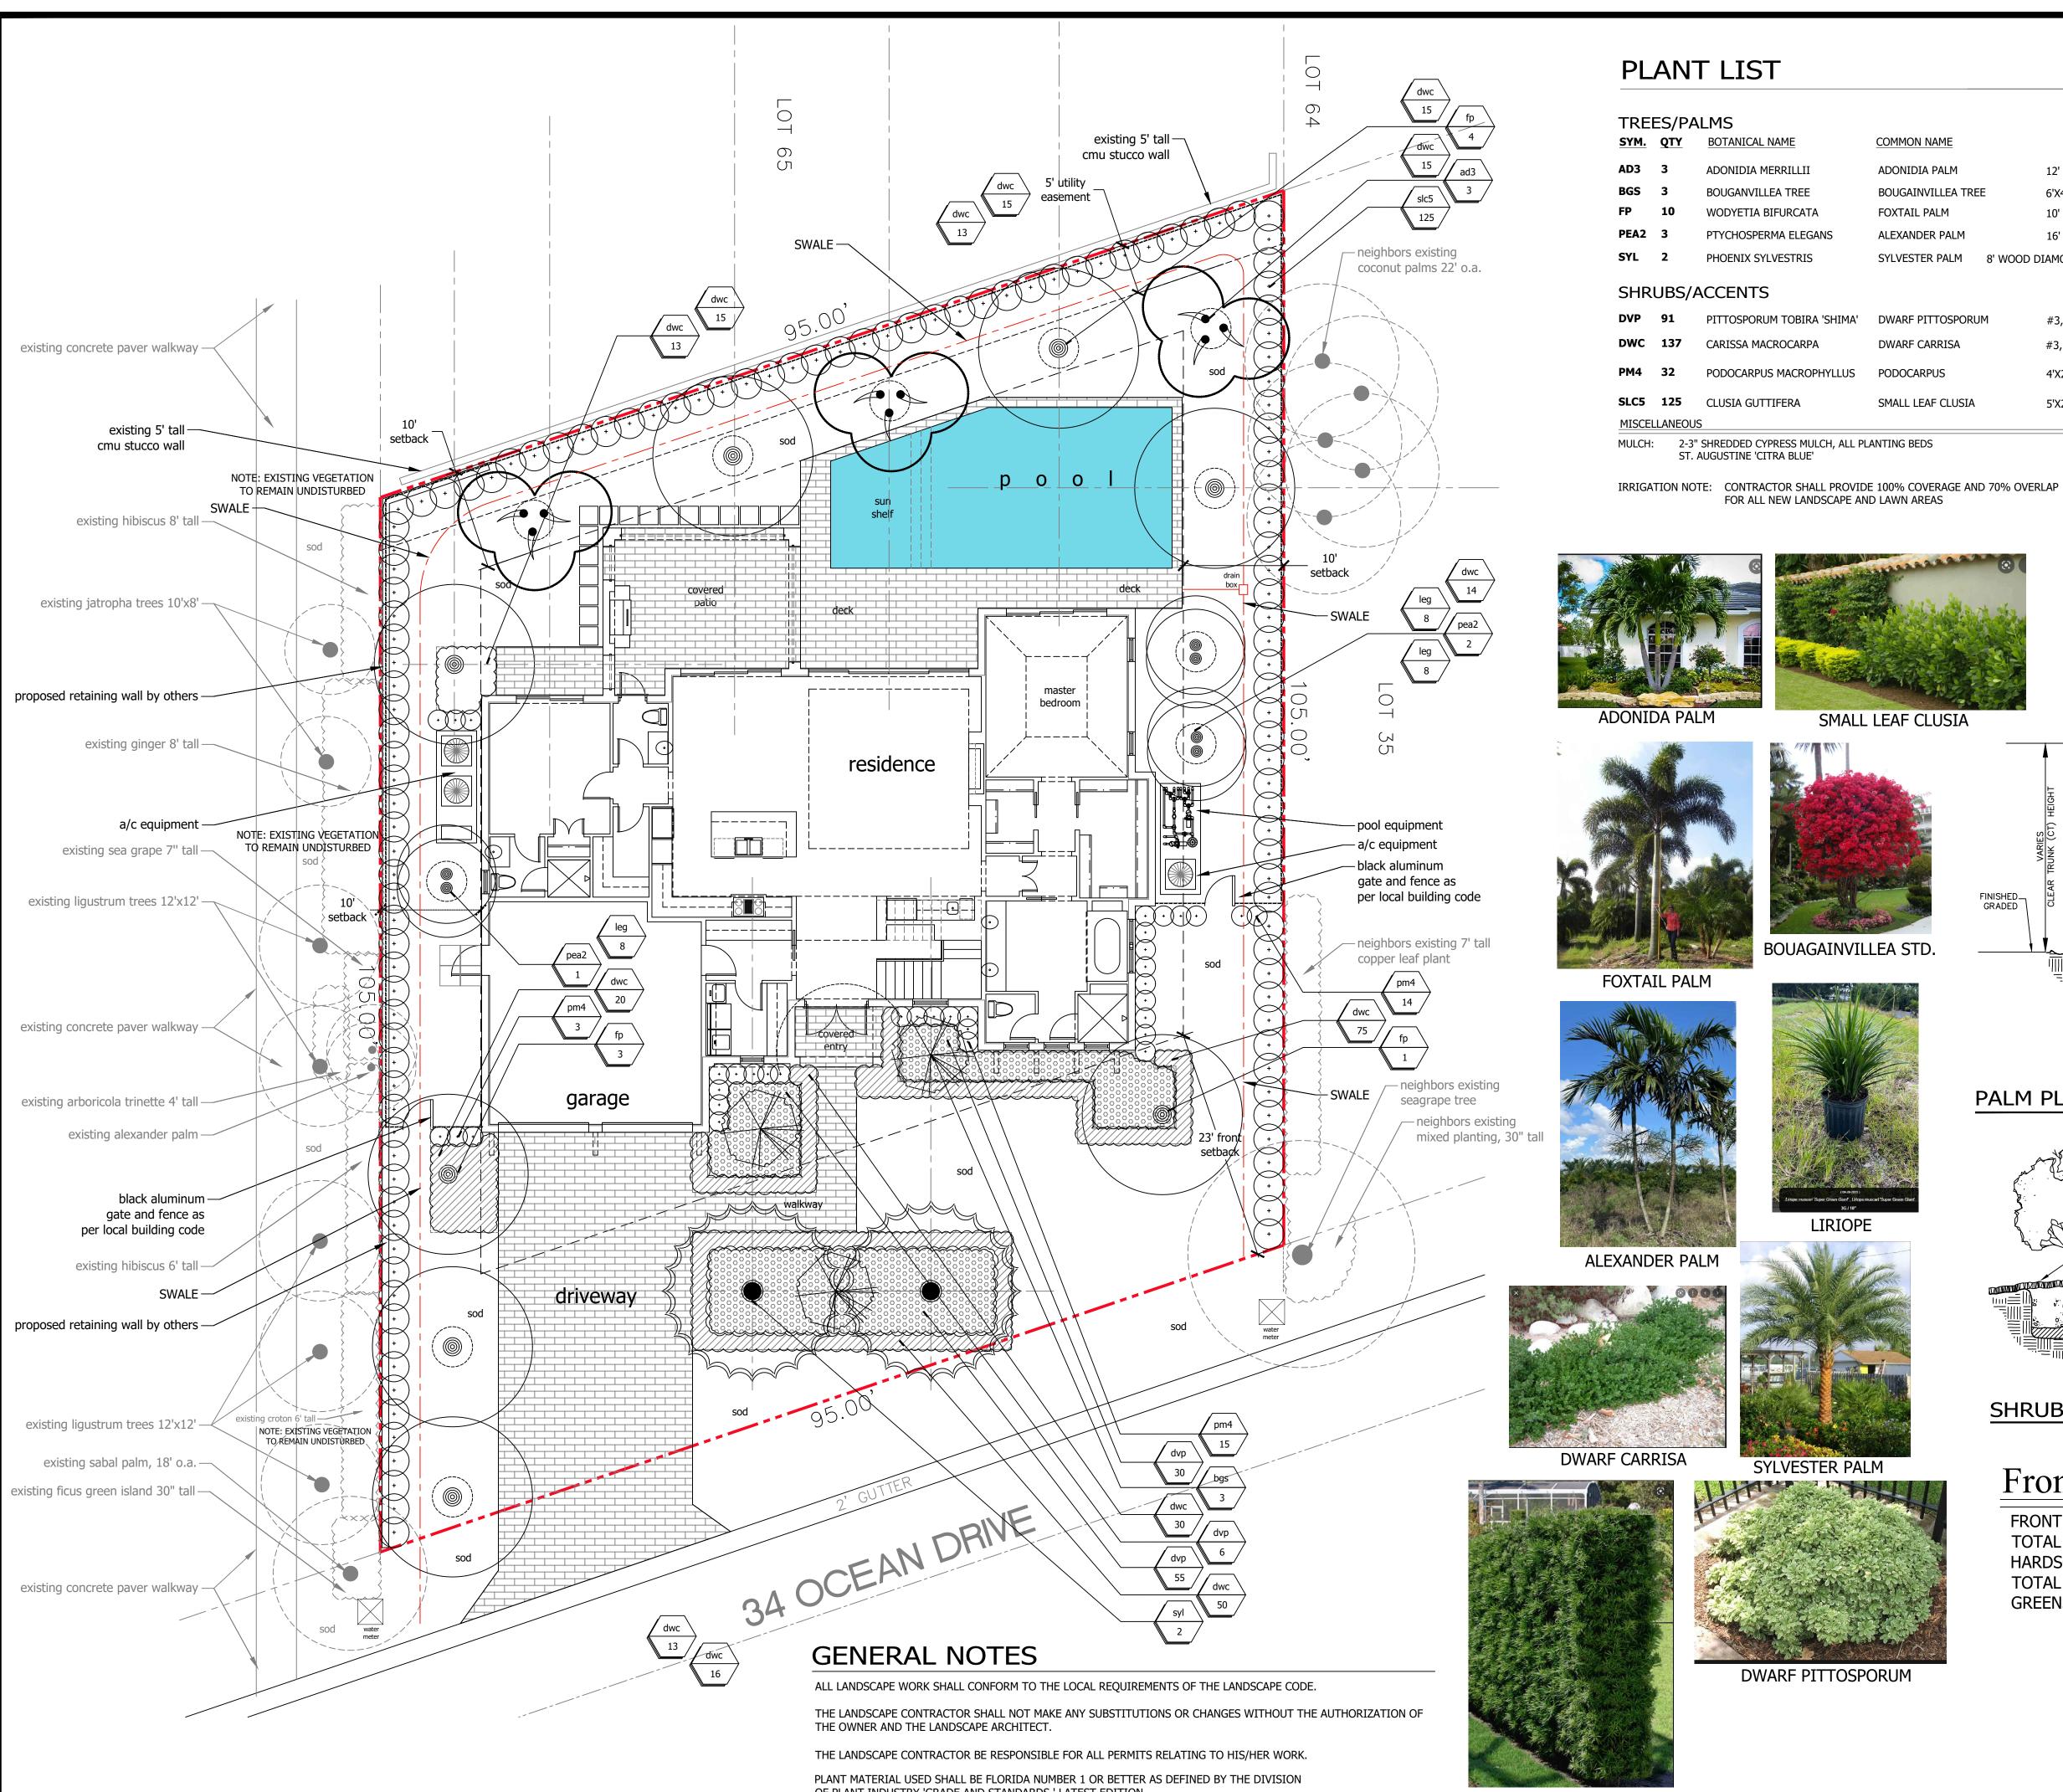


OF PLANT INDUSTRY 'GRADE AND STANDARDS ' LATEST EDITION.


THE IRRIGATION SYSTEM SHALL BE EQUIPPED WITH A RAIN SENSOR/CUT OFF SWITCH

PODOCARPUS


COMMON NAME	SIZE	SPACING	REMARKS
ADONIDIA PALM	12' O.A. TRIPLE STEM	A.S.	MATHCED
BOUGAINVILLEA TREE	6'X4' MIN, MAGENTA	A.S.	MATHCED
FOXTAIL PALM	10' WOOD	A.S.	MATCHED, FULL HEADS
ALEXANDER PALM	16' O.A., DOUBLE STEM	A.S.	FULL HEALTHY GROWTH
SYLVESTER PALM 8' WOOD D	IAMOND CUT, THICK TRUNK ONL	Y A.S.	MATCHING, FULL HEADS
DWARF PITTOSPORUM	#3, 18"X18" MIN	2' O.C.	FULL HEALTHY GROWTH
DWARF CARRISA	#3, 16"X14" MIN	18" O.C.	FULL HEALTHY GROWTH
PODOCARPUS	4'X2'	20" O.C.	FULL HEALTHY GROWTH
SMALL LEAF CLUSIA	5'X2.5' MIN.	A.S.	FULL HEALTHY GROWTH

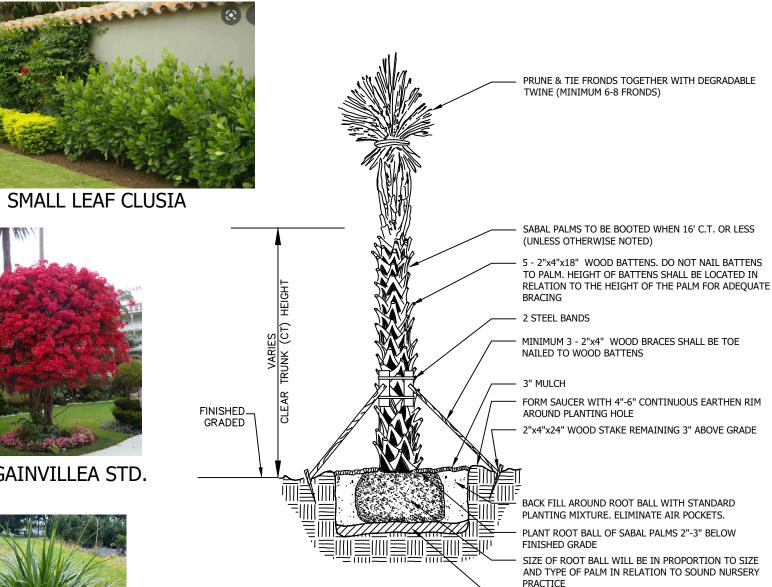


## PALM PLANTING DETAIL

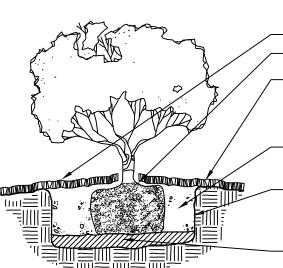

SIZE OF ROOT BALL WILL BE IN PROPORTION TO SIZE AND TYPE OF PALM IN RELATION TO SOUND NURSERY PRACTICE PLACE ROOT BALL AT BOTTOM OF PLANTING PIT ON 4"-6" LAYER OF COMPACTED STANDARD PLANTING MIXTURE. NTS

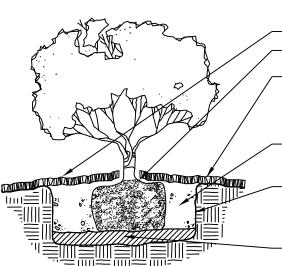

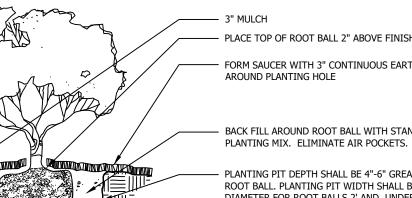

PLACE TOP OF ROOT BALL 2" ABOVE FINISHED GRADE FORM SAUCER WITH 3" CONTINUOUS EARTHEN RIM AROUND PLANTING HOLE

BACK FILL AROUND ROOT BALL WITH STANDARD

PLANTING PIT DEPTH SHALL BE 4"-6" GREATER THAN ROOT BALL. PLANTING PIT WIDTH SHALL BE TWICE THE DIAMETER FOR ROOT BALLS 2' AND UNDER OR 2' LARGER IN DIAMETER FOR ROOT BALLS OVER 2'.

PLACE ROOT BALL AT BOTTOM OF PLANTING PIT ON


NTS


4"-6" LAYER OF COMPACTED STANDARD PLANTING MIXTURE

SHRUB/GROUNDCOVER PLANTING DETAIL

# Front Yard Lot Coverage Data

FRONT YARD SETBACK AREA: 2169 SQ. FT. TOTAL HARDSCAPE AREA: 548 SQ. FT. HARDSCAPE COVERAGE: 25% IMPERVIOUS TOTAL GREENSPACE AREA: 1621 SQ. FT. GREENSPACE COVERAGE: 75% PERVIOUS

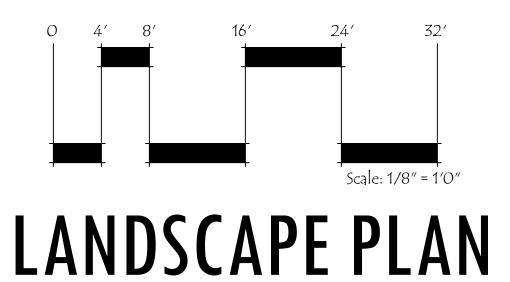

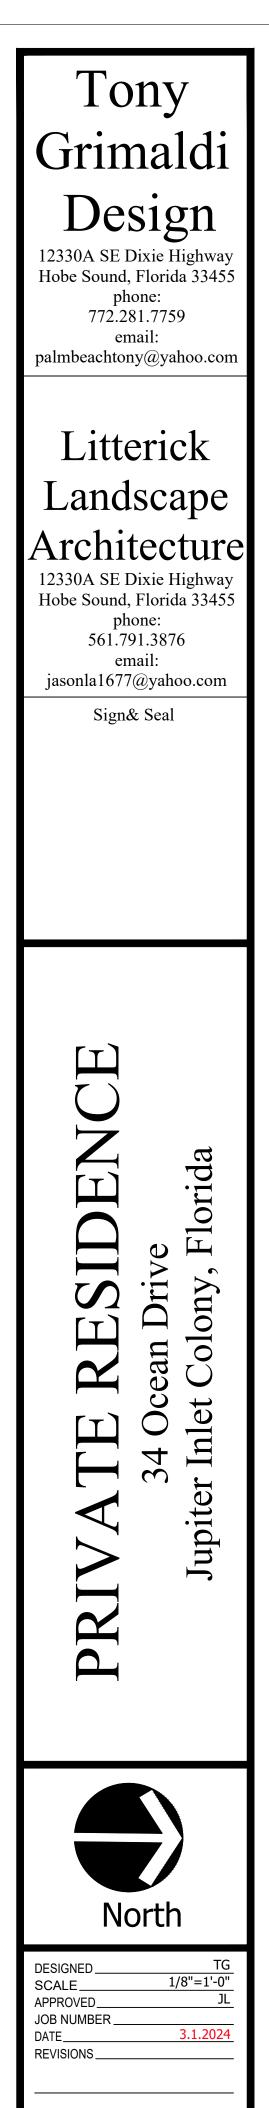


SHEET LP1 OF 1

•	Title	Start	Workdays
•	UNASSIGNED	Apr 15, 2024	289 days
	Underground MEP	Apr 15, 2024	15 days
	Concrete Slab, Foundation & Shell	May 6, 2024	100 days
	Pool Piping & Shell	Jul 16, 2024	20 days
	Waterproofing	Aug 19, 2024	3 days
	Roof Dry In & Flashing	Aug 22, 2024	20 days
	Exterior Windows & Doors	Sep 5, 2024	20 days
	Interior Framing	Sep 19, 2024	25 days
	Rough-In MEP's	Oct 3, 2024	40 days
	Lath & Stucco	Oct 10, 2024	15 days
	Exterior Finish and Trim	Oct 28, 2024	20 days
	Interior Insulation	Nov 5, 2024	5 days
	Drywall, Tape & Finish	Nov 12, 2024	30 days
	Install Tile	Dec 23, 2024	30 days
	Interior Flooring Install	Dec 30, 2024	15 days
	Cabinetry & Vanities	Jan 13, 2025	15 days
	Interior Trims	Jan 13, 2025	30 days
	Order Fences, Gate Install	Feb 3, 2025	60 days
	Template, Fabricate & Install Counter Tops	Feb 3, 2025	20 days
	Paint - Prep, Prime, Spray, Ect	Feb 10, 2025	30 days
	Hardscape/ Landscape	Mar 3, 2025	25 days
	Mirrors and Glasswork	Mar 10, 2025	14 days
	Interior Hardware Install	Apr 7, 2025	3 days
	Pool Stucco and Finish	Apr 7, 2025	5 days
	Final touch up, punchout, clean.	Apr 14, 2025	5 days
	Completion	Apr 21, 2025	1 day
	Final MEP's Including Appliances	Apr 21, 2025	25 days

April 2024	May 2024	June 2024	July
Underground MEP			Concrete Slab, Fou
	7		



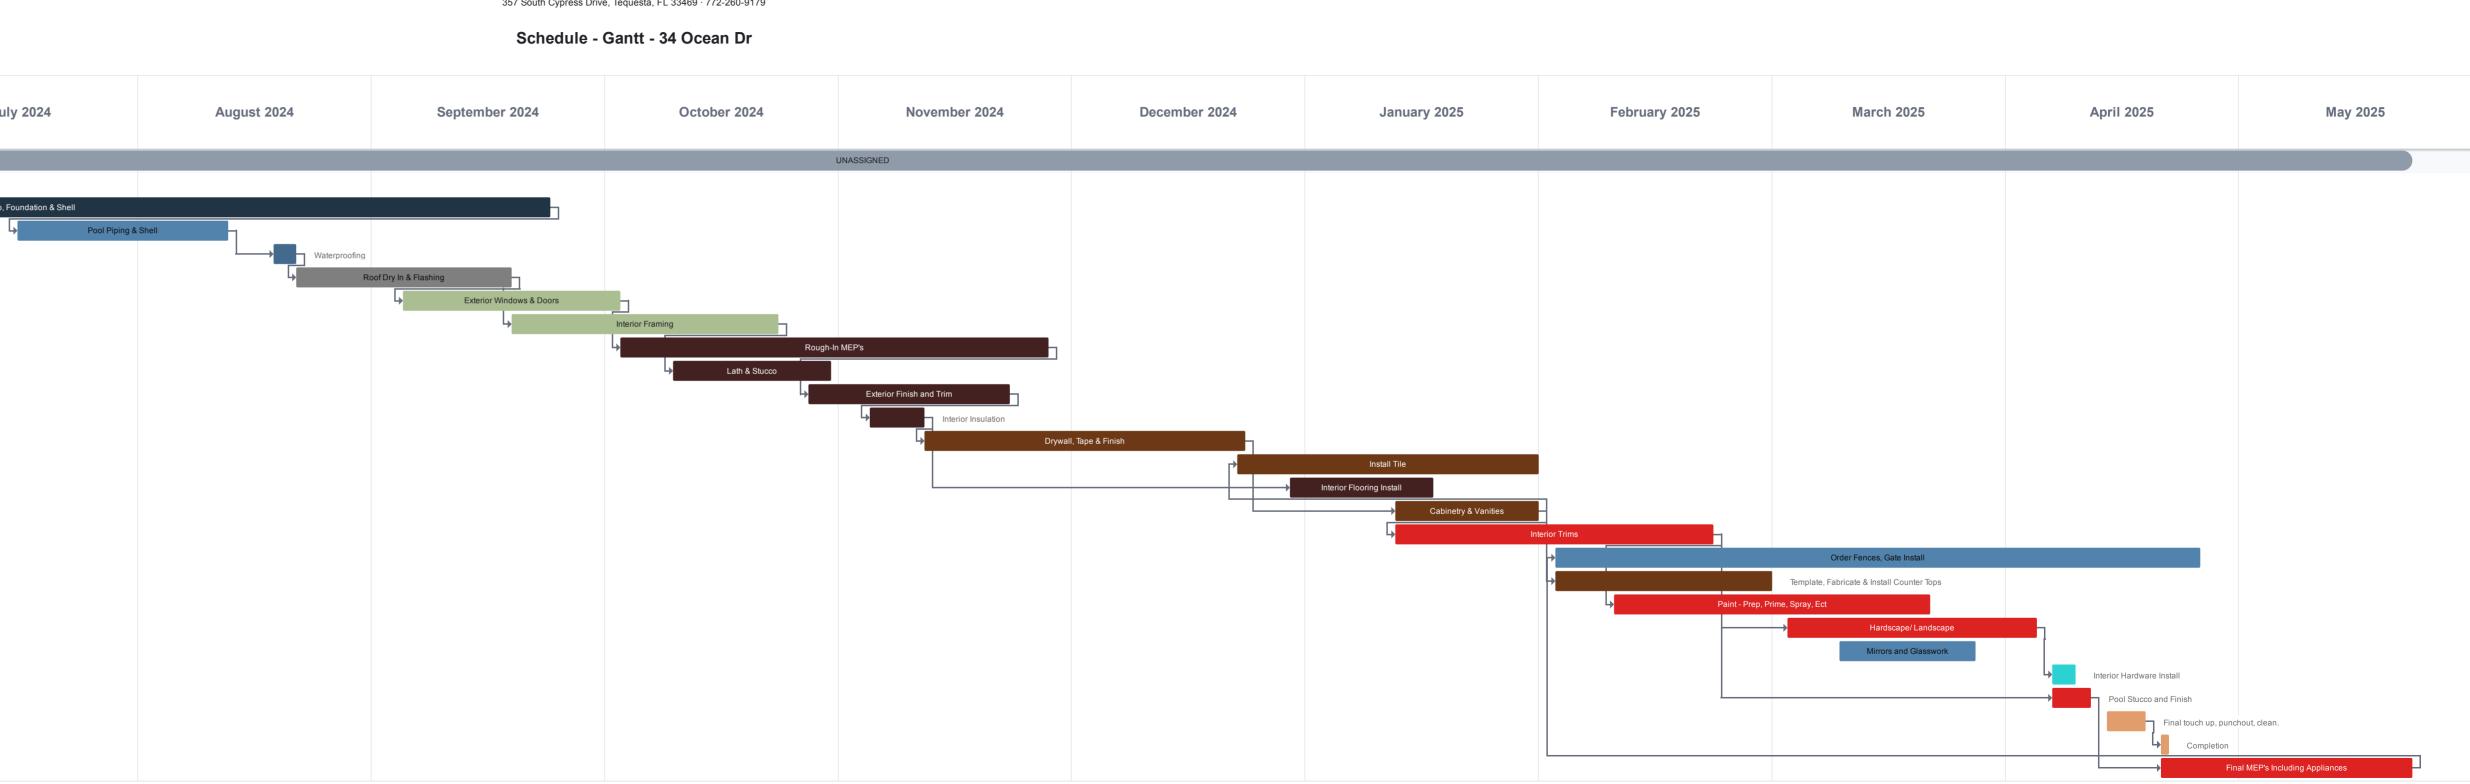

#### JUPITER INLET COLONY BUILDING AND ZONING COMMITTEE REVIEW STANDARDS

#### MASS AND VOLUME

#### Zoning Code Section 10.1. - Development standards for single family residences.

**Mass and Volume Distribution.** Because lots within the town are limited in size, the massing and volume of any new residential building or addition *should be sensitive to the profiles of adjacent buildings and should locate second stories adequately to reduce the apparent overall scale of the building.* Second story windows, decks, terraces, and balconies for new construction *shall be designed and located to ensure privacy for adjacent properties* to the extent possible. (*emphasis added*)

#### IMPACT REVIEW STANDARDS AND DECISIONS Ordinance 02-2021

**Procedures: Standards for Review.** In performing its impact review analysis, the Building and Zoning Committee shall approve an application if the Applicant demonstrates that:

- a. The proposed development will not adversely affect the public interest; and
- b. The mass, scale and height of the proposed development is consistent with the surrounding properties and neighborhood character; and
- c. The proposed development will not adversely affect adjoining properties; and
- d. For development on waterfront properties, the proposed development is sensitive to and preserves views from adjoining properties as much as is practicable.

**Decisions: Appeals.** In performing its impact review analysis, the Building and Zoning Committee shall either approve, approve with conditions, or deny an application for development approval. In the event the Building and Zoning Committee finds that an application meets the requirements of this Section, then the application shall be approved. In the event the Building and Zoning Committee approves the application with conditions or denies the application, the Applicant may either amend its development application in compliance with the decision of the Building and Zoning Committee or may appeal the decision to the Town Commission. ...

#### JUPITER INLET COLONY BUILDING AND ZONING COMMITTEE MEETING 03-20-2024

#### Conditions of Approval: #34 Ocean Drive

- 1) A temporary area consisting of compacted gravel shall be installed on the lot for contractor parking.
- 2) Temporary filters shall be installed in the road drains within close proximity of the site to prevent sand and silt from entering the town's drainage system. Filters shall be cleaned thoroughly weekly and after each storm event. Sand and silt in the filters shall be properly disposed and not emptied into the town's drainage system.
- 3) A temporary screen shall be installed and maintained along the front of the property that shields construction activity from view to the extent possible.
- 4) The road in front of the lot shall be swept and cleaned nightly and kept clear of debris, runoff, sand, and vegetation at all times.
- 5) The contractor shall be responsible for the repair and maintenance of any damage in the town right-of-way and on private property as the result of construction activity.
- 6) During construction, the general contactor shall provide the Town quarterly updates regarding the construction schedule, major milestones, and timeline to complete the residence. Any significant deviation from the schedule shall require review and approval by the Building and Zoning Committee.

#### JUPITER INLET COLONY

#### **GENERATOR LAND DEVELOPMENT CODE REQUIREMENTS**

#### Sec. 4-13. Generators.

- (a) These regulations shall apply to all portable or permanent generators temporarily or permanently placed on the ground, on a stand or on a trailer.
- (b) All permanent generators shall be permitted as required by the Florida Building Code.
- (c) There shall be no more than one such generator on any privately-owned property.
- (d) The generator shall be set back a minimum of five (5) feet from the side or rear property line. (NOTE: ten (10) feet preferred.)
- (e) The generators exhaust shall be, as much as practically feasible, vented upwards or directed away from neighboring properties.
- (f) The generator shall be used only during periods of power outages or for periodic testing and necessary maintenance operation and shall not be used to sell power back to a power company or for use by power customers during periods of peak demand.
- (g) A generator may be operated for manufacturer recommended testing or maintenance. Such operation shall not occur more than one (1) time in any seven-day period and for no longer than thirty (30) minutes for each operation. The operation of a generator pursuant to this paragraph shall be conducted only on Monday through Friday (excluding holidays) between the hours of 9:00 a.m. and 5:00 p.m.
- (h) Testing may be conducted when the unit is being repaired provided that such testing shall not exceed thirty (30) minutes and shall be conducted only between the hours of 9:00 a.m. and 5:00 p.m. Monday through Saturday, excluding holidays.
- (i) Generators shall not be permitted in the required front yard area or on the roof of a building.
- (j) All permanent generators shall be screened from the street and the neighboring property owner's view by a wing wall (three-sided wall) at least four (4) feet high or at the same height as the generator, including the height of the exhaust, whichever is greater. Landscape material shall be installed along the exterior of each face of the wing wall.
- (k) This code section shall not apply to generators owned and operated by the town or another governmental entity.
- (I) The building official may issue a permit for the use of a portable generator for a period not to exceed four (4) days provided the permit applicant provides proof that either permanent or temporary electrical power is not available at the work location. The portable generator shall be operated only during the times for permissible construction activities as set forth in section 4-3 of this Code. No fee shall be required for the issuance of such a permit. (Ord. No. 244-155-110, § 1, 9-27-10; Ord. No. 08-2016, § 10, 1-9-17)

#### TOWN OF JUPITER INLET COLONY ACCESSORY STRUCTURES AND SETBACKS

#### Section 11. - Uses Permitted.

- (B) Within the RS Single-Family Residential District, no building, structure, land, or water shall be used, unless otherwise permitted by this Code, except for one (1) or more of the following uses:
- (1) Single-family residential dwellings and accessory uses customarily incident to them.

#### Section 17. - General Provisions and Exceptions.

- (A) Location of Accessory Building and Uses.
- (1) When an accessory building is attached to a main structure by a breezeway, passage, or otherwise, it shall conform to the setback and height requirements of the principal structure.
- (2) A detached accessory building shall not be closer than four (4) feet to the main building or other accessory building on the same lot.
- (3) No detached accessory building shall be located in the front yard area.

#### (B) Yards.

(1) Every part of a required yard shall be open, from its lowest point to the sky; unobstructed, except for ordinary projections less than ten and one-half (10.5) inches in width protruding from the side of a home or structure, such as impact protection (hurricane shutters, excluding awning type), sills, belt courses, cornices, buttresses, ornamental features, chimneys, flues, dryer vents, electric outlets, meters, water spigots, and the like. If eaves, canopies, or cantilevered roofs project more than twenty-four (24) inches, the minimum yard requirement shall be extended a distance equal to the amount such projection exceeds twenty-four (24) inches.

Except as provided in this section and Section 14, front, rear, and side yard regulations, no other structure or improvement of any nature, other than fences, privacy walls, seawalls, landings, walks, walkways, driveways, mailboxes, landscape lighting, light posts, clean-outs, and equipment on equipment pads, shall be constructed or placed in a required yard area. Sufficient side yard area shall be maintained at all times to allow access to the rear yard for maintenance purposes. All other projections, structures, and improvements not specifically permitted by the Zoning Code or required by the Florida Building Code or other governmental entity are prohibited.

#### Section 1. - Definitions and Rules of Construction.

**Accessory building**. A detached, subordinate structure, the use of which is clearly incidental and related to that of the principal structure and which is located on the same lot as the principal structure, e.g. garage and bath house.

**Residence.** A single-family home, including accessory buildings and garages, on a residential lot or combination of lots.

#### JUPITER INLET COLONY

#### **GENERATOR LAND DEVELOPMENT CODE REQUIREMENTS**

#### Sec. 4-13. Generators.

- (a) These regulations shall apply to all portable or permanent generators temporarily or permanently placed on the ground, on a stand or on a trailer.
- (b) All permanent generators shall be permitted as required by the Florida Building Code.
- (c) There shall be no more than one such generator on any privately-owned property.
- (d) The generator shall be set back a minimum of five (5) feet from the side or rear property line. (NOTE: ten (10) feet preferred.)
- (e) The generators exhaust shall be, as much as practically feasible, vented upwards or directed away from neighboring properties.
- (f) The generator shall be used only during periods of power outages or for periodic testing and necessary maintenance operation and shall not be used to sell power back to a power company or for use by power customers during periods of peak demand.
- (g) A generator may be operated for manufacturer recommended testing or maintenance. Such operation shall not occur more than one (1) time in any seven-day period and for no longer than thirty (30) minutes for each operation. The operation of a generator pursuant to this paragraph shall be conducted only on Monday through Friday (excluding holidays) between the hours of 9:00 a.m. and 5:00 p.m.
- (h) Testing may be conducted when the unit is being repaired provided that such testing shall not exceed thirty (30) minutes and shall be conducted only between the hours of 9:00 a.m. and 5:00 p.m. Monday through Saturday, excluding holidays.
- (i) Generators shall not be permitted in the required front yard area or on the roof of a building.
- (j) All permanent generators shall be screened from the street and the neighboring property owner's view by a wing wall (three-sided wall) at least four (4) feet high or at the same height as the generator, including the height of the exhaust, whichever is greater. Landscape material shall be installed along the exterior of each face of the wing wall.
- (k) This code section shall not apply to generators owned and operated by the town or another governmental entity.
- (I) The building official may issue a permit for the use of a portable generator for a period not to exceed four (4) days provided the permit applicant provides proof that either permanent or temporary electrical power is not available at the work location. The portable generator shall be operated only during the times for permissible construction activities as set forth in section 4-3 of this Code. No fee shall be required for the issuance of such a permit. (Ord. No. 244-155-110, § 1, 9-27-10; Ord. No. 08-2016, § 10, 1-9-17)